


CITY OF EVANS, COLORADO
CONSTRUCTION BID PLANS OF PROPOSED
37TH STREET WIDENING PHASE 2B
WELD COUNTY

TABULATION OF LENGTH & DESIGN DATA	
STATION	LINEAR FEET
	ROADWAY
APPROACH TO PROJECT = STA. 1109+60.00 TO STA. 1114+96.00	536
BEGIN PROJECT 37TH STREET = STA. 1114+96.00	2,385
END PROJECT 37TH STREET = STA. 1138+80.93	
APPROACH TO PROJECT = STA. 1138+80.93 TO STA. 1140+87.19	206
TOTAL	3,127
SUMMARY OF PROJECT LENGTH	FEET
PROJECT GROSS LENGTH	3,127

DESIGN DATA	37TH STREET (40 MPH)
MAXIMUM RADIUS OF CURVE	5930
MAXIMUM GRADE	1.48%
MINIMUM S.S.D. HORIZONTAL	550 FT.
MINIMUM S.S.D. VERTICAL	305 FT.
MAXIMUM DESIGN SPEED	40 MPH
2040 DESIGN TRAFFIC	ADT 14,000
DHV TRUCK %	2%
CLEAR ZONE DISTANCE (TANGENT)	26-32 FT.

PROJECT LIST OF CONTACTS		
City of Evans	Rick Pickard	970-475-1113
Utilities	See Utility Plans	

STA. 1109+60.00 TO SAT. 1114+96.00
APPROACH TO PROJECT

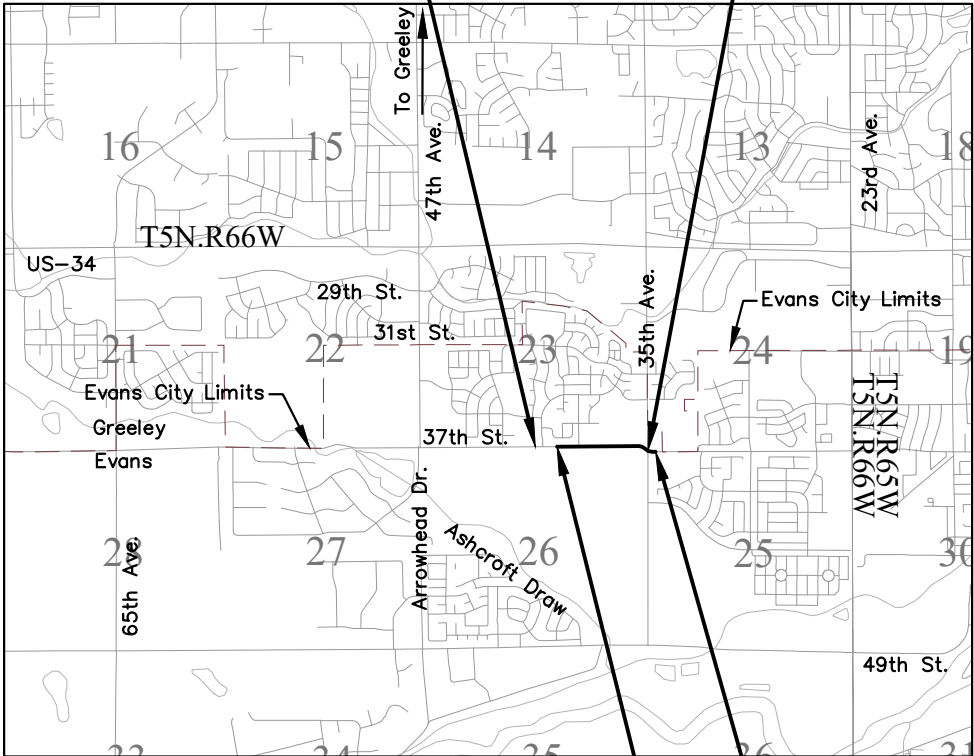

PROJECT LOCATION MAP

STA. 1138+80.93 END PROJECT 37TH STREET

STA. 1138+80.93 TO STA. 1140+87.19
APPROACH TO PROJECT

STA. 1114+96.00 BEGIN PROJECT 37TH STREET


SHEET NO.	INDEX OF SHEETS
1	TITLE SHEET
2	STANDARD PLANS LIST
3	SURVEY CONTROL DIAGRAM
4	SURVEY CONTROL TABULATION
5-9	TYPICAL SECTIONS
10-12	GENERAL NOTES
13-15	SUMMARY OF APPROXIMATE QUANTITIES
16-19	TABULATION SHEETS
20-30A	DETAIL SHEETS
31-36	REMOVAL PLANS
37-40	ROADWAY PLANS
41-43	ROADWAY PROFILES
44-49	ROAD APPROACHES
50	STORM SEWER PLAN AND PROFILE
51	OFFSITE STORM SEWER PLAN AND PROFILE
51A	IRRIGATION TABULATION
51B-E	IRRIGATION PLAN AND PROFILE
52	WATERLINE TABULATION AND NOTES
53	WATERLINE PLAN AND PROFILE
54-55	UTILITY GENERAL NOTES
56-59	UTILITY PLANS
60-80	STORM WATER MANAGEMENT PLAN
81-115	LANDSCAPING PLANS
116-119	CONSTRUCTION PHASING
120-121	SIGNING AND PAVEMENT MARKING TABULATION
122-127	SIGNING AND PAVEMENT MARKING PLANS
200-205	CROSS SECTIONS



Print Date: 4/17/2025


File Name: GN P2B-001 TITLE SHEET.DWG

Horiz. Scale: As Noted Vert. Scale: N/A



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Ph: (303) 962-9300
Fax: (303) 962-9350

	Sheet Revisions		
	Date	Comments	Initials
(R-1)	4/16/25	Added irrigation tabulation, plan and profiles and manhole detail to index	SAH

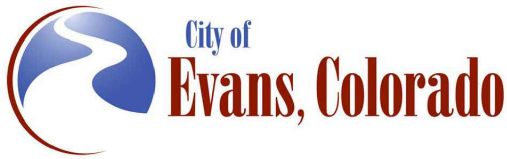

As Constructed	37TH STREET WIDENING PHASE 2B TITLE SHEET			Project No.
	No Revisions:			37TH STREET 2B
Revised:	Designer: T. Tuttle	Structure		Drawing Number GN-001
Void:	Detailer: S. Hemler	Numbers		Sheet Number 1
	Sheet Subset: GENERAL	Subset Sheets: 1 of 2		

Plot Date: 4/17/2025 7:32 AM Plotted By: Sarah Hemler
P:\Q-PROJECTS\WASTE PROJECTS\33001 EVANS 37TH ST AND 47TH AVE PLAN\20 COMPUTER DESIGN FILES\P2 - PHASE 2B\2001 SHEET FILES\GN P2B-001 TITLE SHEET.DWG

FOR CONSTRUCTION 5/1/2025

Plot Date: 5/1/2025 6:35 AM Plotted By: Sarah Hemler
C:\Q-PROJECTS\37TH STREET WIDENING\37TH ST AND 47TH AVE PLAN\302-COMPUTER DESIGN FILES\P2 - PHASE 2B\002-SHEET FILES\GN P2B-002 STANDARD PLANS LIST.DWG

PLAN NUMBER	M STANDARD TITLE	PAGE NUMBER
<input checked="" type="checkbox"/> M-100-1	STANDARD SYMBOLS (3 SHEETS).....	1-3
<input checked="" type="checkbox"/> M-100-2	ACRONYMS AND ABBREVIATIONS (4 SHEETS).....	4-7
<input type="checkbox"/> M-203-1	APPROACH ROADS.....	8
<input type="checkbox"/> M-203-2	DITCH TYPES.....	9
<input type="checkbox"/> M-203-11	SUPERELEVATION CROWNED AND DIVIDED HIGHWAYS (3 SHEETS)	10-12
<input type="checkbox"/> M-203-12	SUPERELEVATION STREETS (2 SHEETS).....	13-14
<input checked="" type="checkbox"/> M-206-1	EXCAVATION AND BACKFILL FOR STRUCTURES (2 SHEETS)	15-16
<input type="checkbox"/> M-206-2	EXCAVATION AND BACKFILL FOR BRIDGES (2 SHEETS).....	17-18
<input checked="" type="checkbox"/> M-208-1	TEMPORARY EROSION CONTROL (11 SHEETS).....	19-29 (REVISED ON MAY 16, 2024)
<input checked="" type="checkbox"/> M-210-1	MAILBOX SUPPORTS (2 SHEETS).....	30-31
<input type="checkbox"/> M-214-1	NURSERY STOCK DETAILS.....	32
<input type="checkbox"/> M-216-1	SOIL RETENTION COVERING (2 SHEETS).....	33-34
<input type="checkbox"/> M-400-1	SAFETYEDGE FOR PAVEMENT (NEW, ISSUED ON DECEMBER 12, 2024)	
<input type="checkbox"/> M-412-1	CONCRETE PAVEMENT JOINTS (9 SHEETS)	35-39 (REVISED ON JANUARY 31, 2022)
<input type="checkbox"/> M-412-2	CONCRETE PAVEMENT CRACK REPAIR (6 SHEETS) (REVISED ON SEPTEMBER 6, 2022)	
<input type="checkbox"/> M-510-1	STRUCTURAL PLATE PIPE H-20 LOADING	40
<input type="checkbox"/> M-601-1	SINGLE CONCRETE BOX CULVERT (CAST-IN-PLACE)	41-42 (2 SHEETS)
<input type="checkbox"/> M-601-2	DOUBLE CONCRETE BOX CULVERT (CAST-IN-PLACE)	43-44 (2 SHEETS)
<input type="checkbox"/> M-601-3	TRIPLE CONCRETE BOX CULVERT (CAST-IN-PLACE)	45-46 (2 SHEETS)
<input type="checkbox"/> M-601-10	HEADWALL FOR PIPES	47
<input type="checkbox"/> M-601-11	TYPE "S" SADDLE HEADWALLS FOR PIPE	48
<input type="checkbox"/> M-601-12	HEADWALLS AND PIPE OUTLET PAVING	49
<input type="checkbox"/> M-601-20	WINGWALLS FOR PIPE OR BOX CULVERTS (2 SHEETS) ...	50-51
<input type="checkbox"/> M-603-1	METAL PIPE (4 SHEETS)	52-55
<input checked="" type="checkbox"/> M-603-2	REINFORCED CONCRETE PIPE	56
<input type="checkbox"/> M-603-3	PRECAST CONCRETE BOX CULVERT	57 (REVISED ON SEPTEMBER 10, 2020)
<input type="checkbox"/> M-603-4	CORRUGATED POLYETHYLENE PIPE (AASHTO M294) AND CORRUGATED POLYPROPYLENE PIPE (AASHTO M330) (2 sheets) (REVISED ON MARCH 7, 2022)	58
<input checked="" type="checkbox"/> M-603-5	POLYVINYL CHLORIDE (PVC) PIPE (AASHTO M304)	59
<input type="checkbox"/> M-603-6	STEEL REINFORCED POLYETHYLENE RIBBED PIPE (AASHTO MP 20)	60
<input type="checkbox"/> M-603-10	CONCRETE AND METAL END SECTIONS	61
<input type="checkbox"/> M-603-12	TRAVERSABLE END SECTIONS AND SAFETY GRATES (3 SHEETS)	62-64
<input type="checkbox"/> M-604-10	INLET, TYPE C	65
<input checked="" type="checkbox"/> M-604-11	INLET, TYPE D	66
<input checked="" type="checkbox"/> M-604-12	CURB INLET TYPE R (2 SHEETS)	67-68
<input type="checkbox"/> M-604-13	CONCRETE INLET TYPE 13	69
<input checked="" type="checkbox"/> M-604-20	MANHOLES (3 SHEETS).....	70-72
<input type="checkbox"/> M-604-25	VANE GRATE INLET (5 SHEETS)	73-77 (REVISED ON FEBRUARY 3, 2023)
<input type="checkbox"/> M-605-1	SUBSURFACE DRAINS	78

PLAN NUMBER	M STANDARD TITLE	PAGE NUMBER
<input type="checkbox"/> M-606-1	MIDWEST GUARDRAIL SYSTEM TYPE 3 W-BEAM.....	79-97 31 INCHES (19 SHEETS) (REVISED ON MARCH 5, 2020)
<input type="checkbox"/> M-606-13	GUARDRAIL TYPE 7 F-SHAPE BARRIER (4 SHEETS).....	98-101
<input type="checkbox"/> M-606-14	PRECAST TYPE 7 CONCRETE BARRIER (4 SHEETS).....	102-104 (REVISED ON FEBRUARY 9, 2023)
<input type="checkbox"/> M-606-15	GUARDRAIL TYPE 9 SINGLE SLOPE BARRIER.....	105-115 (11 SHEETS) (REVISED ON FEBRUARY 17, 2023)
<input type="checkbox"/> M-607-1	WIRE FENCES AND GATES (3 SHEETS).....	116-118
<input type="checkbox"/> M-607-2	CHAIN LINK FENCE (3 SHEETS).....	119-121
<input type="checkbox"/> M-607-3	BARRIER FENCE.....	122
<input type="checkbox"/> M-607-4	DEER FENCE, GATES, AND GAME RAMPS (7 SHEETS).....	123-127 (REVISED ON JULY 13, 2020)
<input type="checkbox"/> M-607-10	PICKET SNOW FENCE	128
<input type="checkbox"/> M-607-15	ROAD CLOSURE GATE (9 SHEETS).....	129-137
<input checked="" type="checkbox"/> M-608-1	CURB RAMPS (10 SHEETS).....	138-147
<input checked="" type="checkbox"/> M-609-1	CURBS, GUTTERS, AND SIDEWALKS (4 SHEETS).....	148-151
<input type="checkbox"/> M-611-1	CATTLE GUARD (2 SHEETS).....	152-153
<input type="checkbox"/> M-611-2	DEER GUARD (2 SHEETS).....	154-155
<input type="checkbox"/> M-614-1	RUMBLE STRIPS (3 SHEETS).....	156-158
<input type="checkbox"/> M-614-2	SAND BARREL ARRAYS (2 SHEETS).....	159-160
<input type="checkbox"/> M-615-1	EMBANKMENT PROTECTOR TYPE 3	161
<input type="checkbox"/> M-615-2	EMBANKMENT PROTECTOR TYPE 5	162
<input type="checkbox"/> M-616-1	INVERTED SIPHON.....	163
<input type="checkbox"/> M-620-1	FIELD LABORATORY CLASS 1.....	164
<input type="checkbox"/> M-620-2	FIELD LABORATORY CLASS 2 (2 SHEETS).....	165-166
<input type="checkbox"/> M-620-11	FIELD OFFICE CLASS 1.....	167
<input type="checkbox"/> M-620-12	FIELD OFFICE CLASS 2.....	168
<input checked="" type="checkbox"/> M-629-1	SURVEY MONUMENTS (2 SHEETS).....	169-170

COLORADO
DEPARTMENT OF TRANSPORTATION

M&S STANDARDS PLANS LIST


July 31, 2019

Revised on December 20, 2024

ALL OF THE M&S STANDARD PLANS, AS SUPPLEMENTED AND REVISED, APPLY TO THIS PROJECT WHEN USED BY DESIGNATED PAY ITEM OR SUBSIDIARY ITEM.

THE M&S STANDARD PLANS USED TO DESIGN THIS PROJECT ARE INDICATED BY A MARKED BOX ☒, AND WILL BE ATTACHED TO THE PLANS. ALL OTHER M&S STANDARD PLANS ARE STILL ELIGIBLE FOR USE IN CONSTRUCTION IF APPROVED BY AN APPROPRIATE CDOT ENGINEER.

PLAN NUMBER	S STANDARD TITLE	PAGE NUMBER
<input type="checkbox"/> S-612-1	DELINEATOR INSTALLATIONS (8 SHEETS).....	171-178 (REVISED ON APRIL 30, 2024)
<input type="checkbox"/> S-613-1	ROADWAY LIGHTING (6 SHEETS)	179-186 (REVISED ON SEPTEMBER 30, 2020)
<input type="checkbox"/> S-613-2	ALTERNATIVE ROADWAY LIGHTING (4 SHEETS) (NEW, ISSUED ON SEPTEMBER 30, 2020)	
<input type="checkbox"/> S-613-3	PULL BOX DETAIL (2 SHEETS) (NEW, ISSUED ON APRIL 4, 2024)	179
<input type="checkbox"/> S-613-4	TRAFFIC SIGNAL ONE-LINE DIAGRAM (6 SHEETS) (NEW, ISSUED ON JUNE 15, 2023)	180
<input checked="" type="checkbox"/> S-614-1	GROUND SIGN PLACEMENT (2 SHEETS)	187-188 (REVISED ON MARCH 1, 2024)
<input checked="" type="checkbox"/> S-614-2	CLASS I SIGNS ... (REVISED ON MARCH 1, 2024)	189
<input type="checkbox"/> S-614-3	CLASS II SIGNS ... (REVISED ON MARCH 1, 2024)	190
<input type="checkbox"/> S-614-4	CLASS III SIGNS (3 SHEETS) ... (REVISED ON MARCH 1, 2024)	191-193
<input type="checkbox"/> S-614-5	BREAK-AWAY SIGN SUPPORT DETAILS	194-195 FOR CLASS III SIGNS (2 SHEETS)
<input type="checkbox"/> S-614-6	CONCRETE FOOTINGS AND SIGN ISLANDS	196-197 FOR CLASS III SIGNS (2 SHEETS)
<input type="checkbox"/> S-614-8	TUBULAR STEEL SIGN SUPPORT DETAILS (7 SHEETS).....	198-204 (REVISED ON MARCH 1, 2024)
S-614-9	PEDESTRIAN PUSH BUTTON POST ASSEMBLY (2 SHEETS)	205-206 (SUPERSEDED ON JANUARY 23, 2020 BY S-614-45)
<input type="checkbox"/> S-614-10	MARKER ASSEMBLY INSTALLATIONS	207
<input type="checkbox"/> S-614-11	MILEPOST SIGN DETAIL FOR HIGH SNOW AREAS	208
<input type="checkbox"/> S-614-12	STRUCTURE NUMBER INSTALLATION (2 SHEETS).....	209-210
<input type="checkbox"/> S-614-14	FLASHING BEACON AND SIGN INSTALLATIONS (4 SHEETS).....	211-214
<input type="checkbox"/> S-614-15	CHAIN STATION SIGNAGE (1 SHEET) (NEW, ISSUED ON APRIL 30, 2024)	
<input type="checkbox"/> S-614-20	TYPICAL POLE MOUNT SIGN INSTALLATIONS	215 (REVISED ON MARCH 1, 2024)
<input type="checkbox"/> S-614-21	CONCRETE BARRIER SIGN POST INSTALLATIONS.....	216-217 (2 SHEETS) (REVISED ON SEPTEMBER 21, 2020)
<input type="checkbox"/> S-614-22	TYPICAL MULTI-SIGN INSTALLATIONS.....	218
<input type="checkbox"/> S-614-23	J-POST SIGN SUPPORT (3 SHEETS)	219-223 (NEW, ISSUED ON MAR. 1, 2024)
<input type="checkbox"/> S-614-40	TYPICAL TRAFFIC SIGNAL 30'-75' DOUBLE MAST ARMS... 65'-75' SINGLE MAST ARMS (5 SHEETS) (REVISED ON JULY 22, 2022)	224-227
<input type="checkbox"/> S-614-40A	ALTERNATIVE TRAFFIC SIGNAL 25'-55' SINGLE MAST ARMS (4 SHEETS) (REVISED ON JULY 22, 2022)	228-240
<input type="checkbox"/> S-614-41	TEMPORARY SPAN WIRE SIGNALS (13 SHEETS)	241-244
<input type="checkbox"/> S-614-42	CABINET FOUNDATION DETAIL (4 SHEETS)	245-252 (REVISED ON APRIL 4, 2024)
<input type="checkbox"/> S-614-43	TRAFFIC LOOP AND MISCELLANEOUS SIGNAL DETAILS.....	253-254
<input type="checkbox"/> S-614-44	PEDESTAL POLE SIGNALS (2 SHEETS).....	255-266
<input type="checkbox"/> S-614-45	PEDESTRIAN PUSH BUTTON POST ASSEMBLY DETAILS (6 SHEETS) (REVISED ON DECEMBER 3, 2020)	267-280
<input type="checkbox"/> S-614-50	STATIC SIGN MONOTUBE STRUCTURES (12 SHEETS).....	281-289
<input type="checkbox"/> S-614-60	DYNAMIC SIGN MONOTUBE STRUCTURES (14 SHEETS)	290-313
<input checked="" type="checkbox"/> S-627-1	PAVEMENT MARKINGS (11 SHEETS) (REV. APRIL 30, 2024)	314
<input checked="" type="checkbox"/> S-630-1	TRAFFIC CONTROLS FOR HIGHWAY CONSTRUCTION (26 SHEETS) (REVISED ON APRIL 30, 2024)	
<input checked="" type="checkbox"/> S-630-2	BARRICADES, DRUMS, CONCRETE BARRIERS (TEMP.) AND VERTICAL PANELS	315
<input type="checkbox"/> S-630-3	FLASHING BEACON (PORTABLE) DETAILS.....	316-317
<input type="checkbox"/> S-630-4	STEEL SIGN SUPPORT (TEMPORARY) INSTALLATION.....	318-319
<input type="checkbox"/> S-630-5	PORTABLE RUMBLE STRIPS (TEMPORARY) (2 SHEETS).....	320
<input type="checkbox"/> S-630-6	EMERGENCY PULL-OFF AREA (TEMPORARY)	321-323
<input type="checkbox"/> S-630-7	ROLLING ROADBLOCKS FOR TRAFFIC CONTROL (3 SHEETS).....	

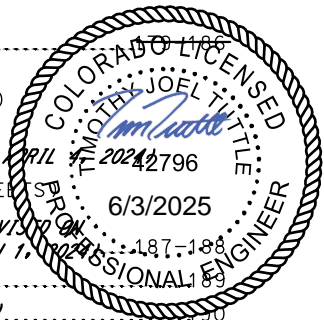

Print Date: 5/2/2025

File Name: GN P2B-002 STANDARD PLANS LIST.DWG

Horiz. Scale: N/A Vert. Scale: N/A


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Fax: (303) 962-9350

Sheet Revisions		
Date	Comments	Initials

As Constructed	37TH STREET WIDENING PHASE 2B STANDARD PLANS LIST			Project No.
No Revisions:				37TH STREET 2B
Revised:	Designer: T. Tuttle	Structure		Drawing Number GN-002
	Detailer: S. Hemler	Numbers		
Void:	Sheet Subset: GENERAL	Subset Sheets: 2 of 2		Sheet Number 2

FOR CONSTRUCTION 5/1/2025

Plot Date: 5/2/2025 6:36 AM Plotted By: Sarah Hemler
R:\Q-PROJECTS\ACTIVE PROJECTS\33001- EVANS 37TH ST AND 47TH AVE PLAN\600-COMPUTER DESIGN FILES.P2 - PHASE 2B\602-SHEET FILES\SC P2B-001 SURVEY CONTROL SHEET.DWG

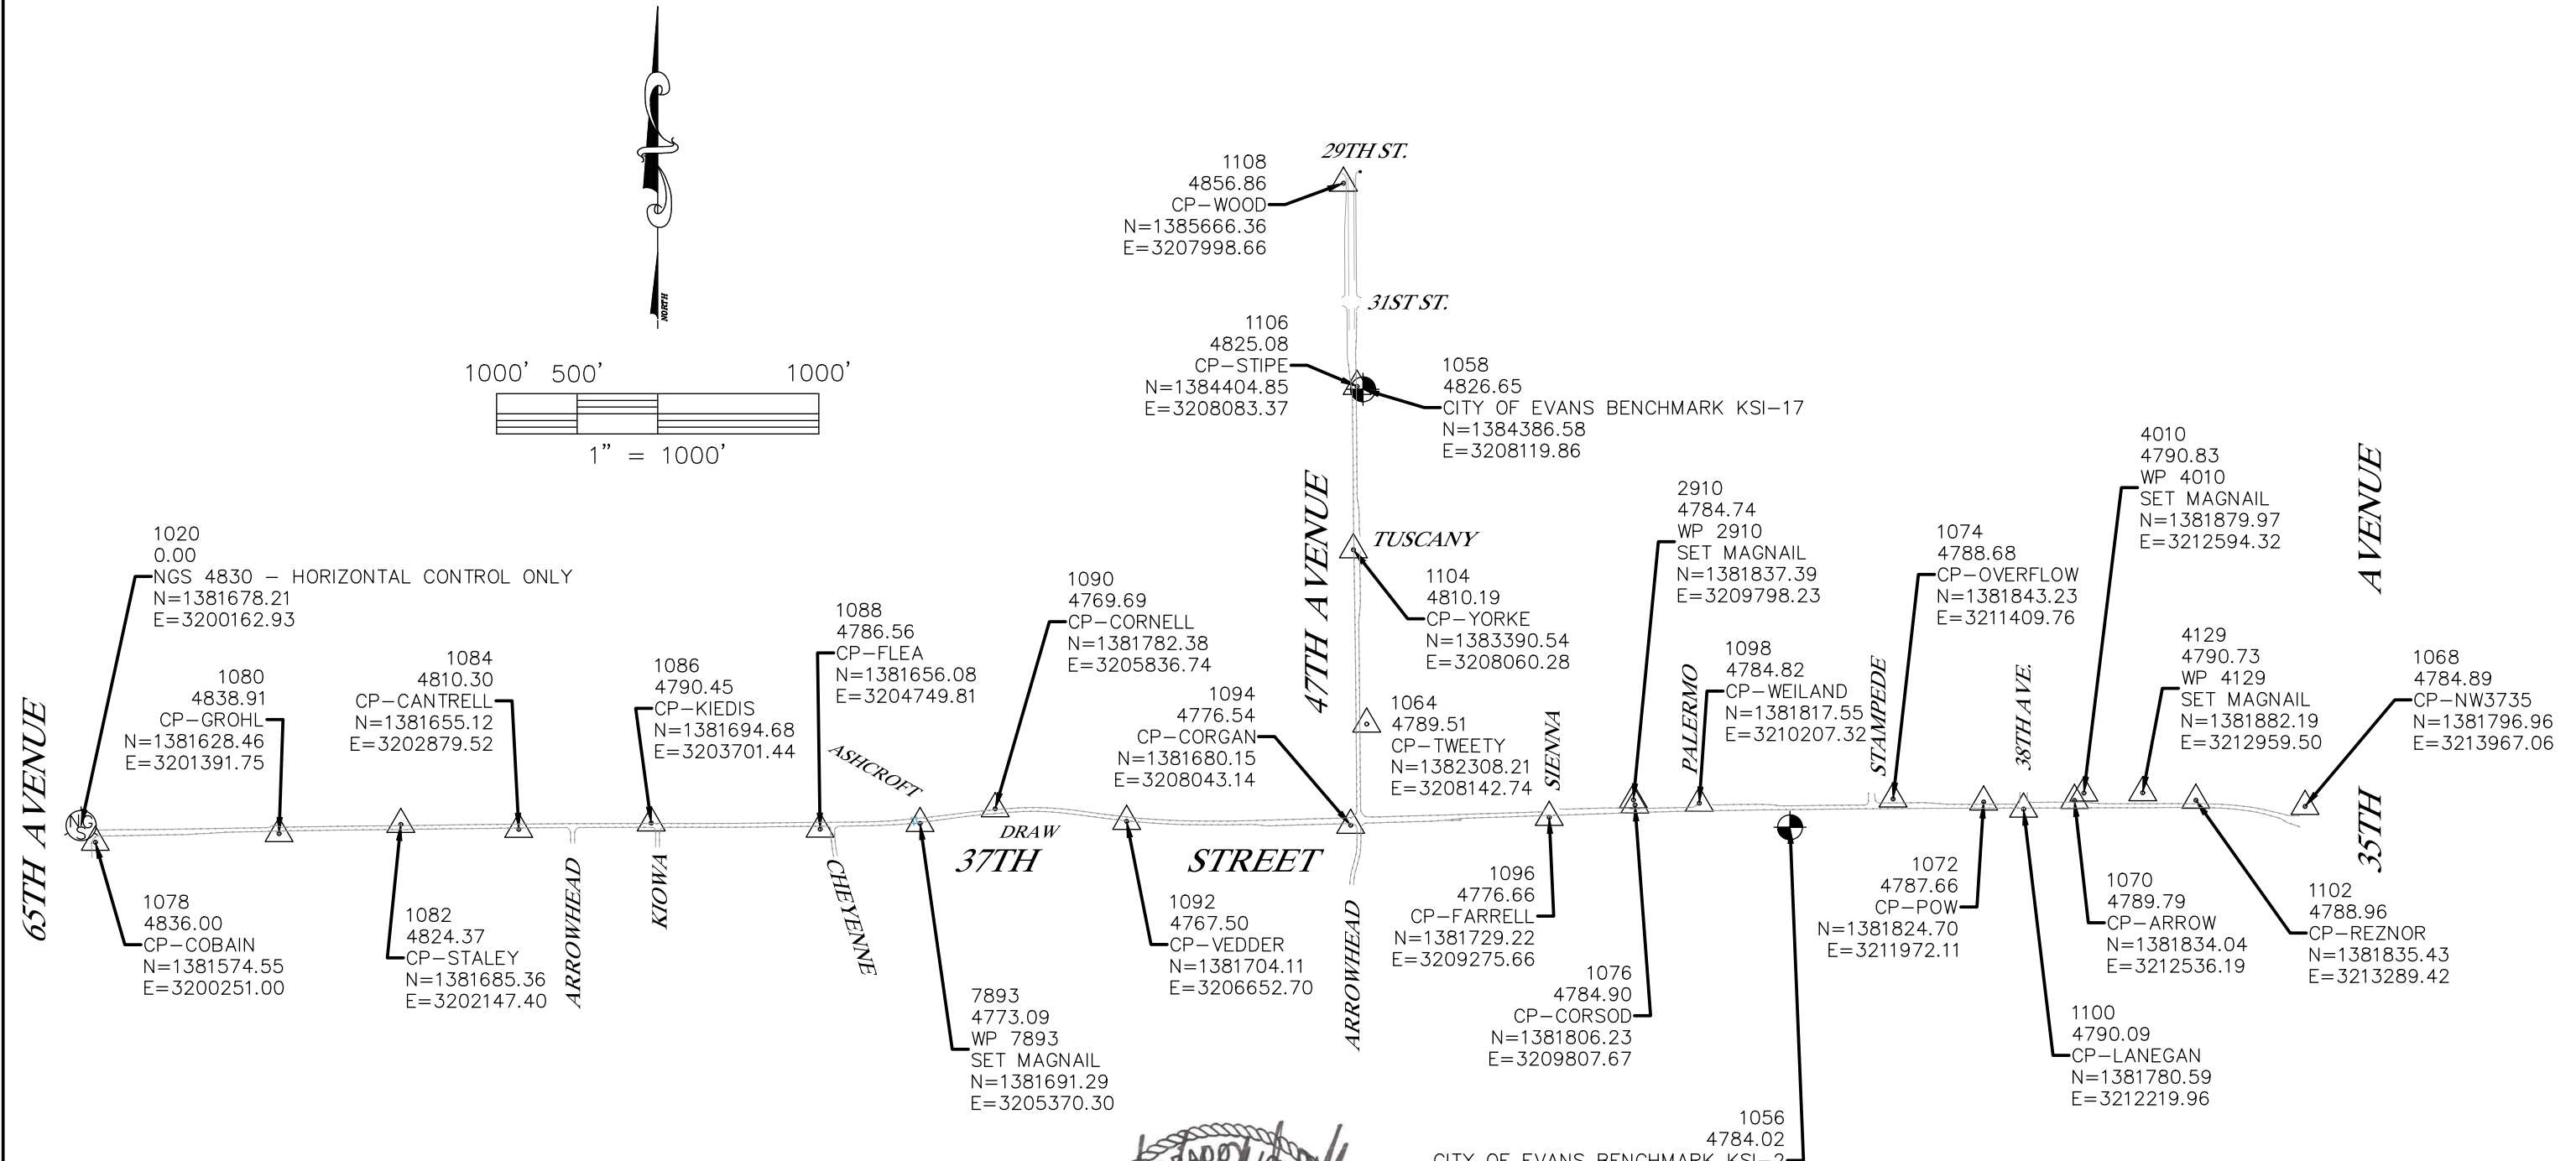

HORIZONTAL DATUM


Project coordinates are Colorado State Plane, North Zone, NAD 83/2011 coordinates that have been scaled to ground using a combined factor of 1.00026824 about an origin of 0,0.
Project Coordinates Northing US Survey Feet = (State Plane Coordinate Northing x 1.00026824).
Scale about an origin of 0,0.
Project Coordinates Easting US Survey Feet = (State Plane Coordinate Easting x 1.00026824).
Scale about an origin of 0,0.

VERTICAL DATUM

Project elevations are based on City of Evans Benchmarks (NAVD88).



Print Date: 5/2/2025		Sheet Revisions			As Constructed	37TH STREET WIDENING PHASE 2B SURVEY CONTROL DIAGRAM			Project No.	
File Name: SC P2B-001 SURVEY CONTROL SHEET.DWG									37TH STREET 2B	
Horiz. Scale: As Noted		Vert. Scale: N/A		<div></div>						
<div><div>12076 Grant Street Thornton, CO 80241 Ph: (303) 962-9300 Fax: (303) 962-9350</div></div>		<div></div>								
		<div></div>								
		<div></div>								
		<div></div>								
<div><div>City of Evans, Colorado</div></div>		<div><div>FREEDOM Parkway</div></div>			No Revisions:					
					Revised:		Designer: AD	Structure		Drawing Number SC-001
					Void:		Detailer: MCD	Numbers		
					Sheet Subset: SURVCON		Subset Sheets: 1 of 1		Sheet Number 3	

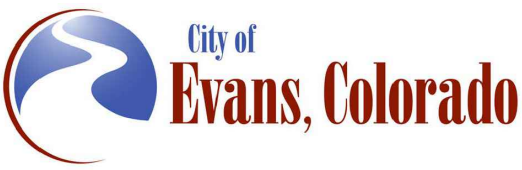

FOR CONSTRUCTION 5/1/2025

TO ESTABLISH GEOMETRIC CONTROL FOR THE CONSTRUCTION OF THIS PROJECT, THE DEPARTMENT HAS PROVIDED THE FOLLOWING INFORMATION:

Format *

☐ 3D Design Modeling Electronic Files _____

☒ Horizontal Control _____

☒ Vertical Control _____

☒ Roadway Alignment _____

☐ Original Terrain Data _____

☐ Other: _____

* Specify the information format, ie., plan sheet, computer disk, computer printout, or other. The information marked is either contained on the plans or is available from the Engineer.

TYPE OF PROJECT

<input checked="" type="checkbox"/> Landscaping	<input checked="" type="checkbox"/> Major Reconstruction
<input type="checkbox"/> Signalization	<input type="checkbox"/> New Roadway Construction
<input type="checkbox"/> Safety Improvement	<input type="checkbox"/> Bridge Replacement
<input type="checkbox"/> Asphalt Overlay	<input type="checkbox"/> Bridge Widening
<input type="checkbox"/> Concrete Overlay	<input type="checkbox"/> New Bridge
<input checked="" type="checkbox"/> Minor Widening	<input type="checkbox"/> Other: _____

SURVEY WORK TO BE PERFORMED BY OTHERS: _____

WORK PERFORMED BY THE CONTRACTOR'S SURVEYOR UNDER SECTION 625:

☐ A complete passing Base Line report (completed within 6 months prior to the start of the project)

☐ An instrument calibration Certification (completed within 6 months prior to the start of the project)

☒ Establish and Maintain Project Centerline or Engineer Approved Offset Line(s)

☒ Verification and Maintenance of Horizontal and Vertical Control

☐ Verify or Determine existing grades and alignments

☐ Verify or Determine existing topography

☐ Clearing and Grubbing Limits (Section 201)

☐ Removal Limits (Section 202)

☒ Reset Items (Section 210)

☐ Excavation and Embankment (Section 203)

☒ Excavation

☐ Unclassified

☐ Stripping

☐ Muck

☐ Rock

☐ Borrow

☐ Other: _____

☐ Potholing

☒ Embankment

☐ Site Grading

☐ Erosion Control (Perm)

☐ Other: _____

☐ As Staked Earthwork Quantities (See General Notes)

☐ Landscaping

☐ Top Soil (Section 207)

☐ Seeding (Section 212)

☐ Mulching (Section 213)

☐ Planting (Section 214)

☐ Herbicide (Section 217)

☐ Other: _____

☐ Erosion Control (Section 208)

☐ Seeding (Temp)

☐ Silt Fence

☐ Erosion Bales

☐ Erosion Logs

☐ Riprap (Temp)

☐ Other: _____

☒ Roadway Bases

☐ Untreated Subgrade

☐ Treated Subgrade

☒ Aggregate Base Course (Section 304)

☒ Reconditioning

☐ PMBB – Plant Mix Bituminous Base

☐ Other: _____

Excavation	Slope Staking (Y/N)	Grid (Y/N)	Grade (Y/N)	Special Interval
	-	-	-	-
	-	-	-	-
	-	-	-	-
	-	-	-	-

Embankment	-	-	-	-
	-	-	-	-
	-	-	-	-
	-	-	-	-

Roadway Bases	Grid (Y/N)	Grade (Y/N)	Special Interval	Special Offset
	-	-	-	-
	-	-	-	-
	-	Y	-	-
	-	Y	-	-
	-	-	-	-

☒ Pavements

☐ HMA – Hot Mix Asphalt (Section 403)

☐ Concrete (Section 412)

☐ Heating & Scarifying Treatment

☐ Prime Coat, Tack Coat & Rejuvenating Agent (Section 407)

☐ Seal Coat or Chip Seal (Section 409)

☐ Other: _____

Pavements	Grid (Y/N)	Special Interval	Special Offset
	-	-	-
	-	-	-
	-	-	-
	-	-	-

☒ Roadway Elements

☐ Curb and Gutter (Section 609)

☐ Drop inlets – alignment and grades (Section 604)

☐ Retaining Walls

☐ Guard Rail (Section 606)

☒ Sidewalk (Section 608)

☐ Overlay Stationing

☐ Other: _____

Curb & Gutter	Tangent Interval	Curve Interval	Special Offset
	-	-	-

Stationing	Left Interval	Center Interval	Right Interval
	-	-	-

☐ Riprap (Perm) (Section 506)

☐ Slope and Ditch Paving (Section 507)

☒ Minor Structures

☐ Structure Excavation limits (Section 206)

☐ Culverts (Section 603)

☐ Culverts w/ Headwalls and Wingwalls (Section 601)

☐ Concrete Box Culverts w/ Headwalls and Wingwalls

☒ Pipes (Section 603)

☐ Sanitary Sewer

☒ Storm Sewer

☐ Water

☒ Irrigation

☐ Miscellaneous

☒ Manholes (Section 604)

☒ Inlets (Section 604)

☐ Permanent Water Quality BMP (Section 208)

☐ Other: _____

☐ Major Structures – Overhead Signs (Section 614), Concrete Box Culverts, Bridges – and all other structures assigned a structure number

☐ Structure Excavation limits (Section 206)

☐ Concrete Box Culverts (Section 603) w/ Headwalls and Wingwalls (Section 601)

☐ Piling locations and cut off elevations (Section 502)

☐ Caisson locations and elevations (Section 503)

☐ Footing locations, alignment, and elevations

☐ Abutment/Pier locations, alignment, and elevations

☐ Wingwall skew angles/offsets

☐ Structural concrete form locations

☐ Substructure As-constructed survey required for Bridges (Subsection 601 .12) and Overhead signs (S-614-50)

☐ Bridge expansion joint(s) alignment and grade (longitudinal and transverse)

☐ Deck grades at Girder 10th or "n" th point locations and elevations

☐ Slope and Ditch Paving (Section 507)

☐ Other: _____

☐ Fencing (Section 607)

☐ Temporary

☐ Permanent

☐ Sound Barrier

☐ Other: _____

☐ Delineators (Section 612)

☐ Temporary

☐ Permanent

☒ Lighting (Section 613) and Traffic Control Devices (Permanent) (Section 614)

☐ Signal pole locations and elevations

☐ Light pole locations and elevations

☒ Sign locations

☒ Field verify sign post locations, elevations, and lengths before fabrication.

☐ Other: _____

☒ Pavement Marking (Section 627)

☐ Striping (Temp)

☒ Striping (Perm)

☒ Symbols

☐ Other: _____

☐ Temporary Lighting and Construction Traffic Control Devices (Section 630)

☐ Signal pole locations and elevations (Temp)

☐ Light pole locations and elevations (Temp)

☐ Sign Locations (Temp)

☐ Other: _____

☒ All Easements (Temp Staking by P.L.S. Only)

☒ Right of Way (Temp Staking by P.L.S. Only)

WORK PERFORMED BY THE CONTRACTOR'S SURVEYOR UNDER SECTION 629:

☒ Monumentation (Section 629)

☐ Control

☐ Right of Way

☐ Land corners, Aliquot corners

☒ Easements

☐ Reference the specified existing monuments: ** _____

☐ Replace the specified existing monuments: ** _____


☐ Locate monuments. It is estimated ____ hours are required.

NOTE: All 629 items shall include adequate research, calculations, and evaluations of evidence for monuments to be set.

** A Tabulation of Survey Monuments may be provided on the plans.

GENERAL NOTES:

- Unless indicated otherwise on this Survey Tabulation Sheet, all survey work and staking intervals shall be done in accordance with the latest edition of the CDOT Survey Manual.
- Adequate information for establishing lines, grades, and locations for all work items have been specified on the plans. Any additional information required to stake the item or element shall be generated by the Contractor's surveyor.
- The Contractor's surveyor shall provide an estimate of the man-hours necessary to complete the work items indicated on this sheet. A copy of this sheet, with the estimated man-hours written on the blank line to the left of the specified items, shall be submitted with the Survey Schedule to the Engineer ____ days prior to the Presurvey Conference – Construction Survey.
- Stakes and Monuments which are damaged or destroyed by the progress of construction shall be replaced by the Contractor at no additional cost to the Department.
- The Contractor shall furnish an As Staked (or 3D Design Modeling Electronic Files) Earthwork Quantity report to the Engineer prior to completion of twenty percent (20%) of the planned earthwork in any phase as per the CDOT Survey Manual. A printed copy of the As Staked (or 3D Design Modeling Electronic Files) Earthwork data report and a computer disk with that information on it, in the specified format shall be submitted to the Engineer. The Contractor shall field verify original ground cross sections at a maximum 500 feet intervals.
- Prior to beginning work on any subsequent operation, such as placing base course or paving, the Contractor shall certify in writing to the Engineer that the final grade is within specified tolerance.
- The Contractor's surveyor shall perform all field surveying and calculations necessary to tie plan grades into field grades.
- The Contractor shall coordinate construction staking on the project with any utility work.
- Fieldbooks shall contain daily records of points set and or measurements observed. The information recorded shall contain: date, crew members' names, point no., description, staking information, and sketches. If the survey information is collected electronically, information recorded shall be provided to the Project Engineer in a hard copy format that is intuitive, clear and related to the supplemental information recorded in the field books. All linear surveys, such as slope stakes and blue tops, shall have the station and offset information related to the measured information. Non-linear surveys such as structures staking shall have sketches relating electronic information, such as point numbers, to the sketch.
- The Contractor's surveyor shall submit the following fieldbooks to the Engineer:
 - ☒ Horizontal Control (Primary & Secondary)
 - ☒ Vertical Control (i.e. Benchmarks)
 - ☐ Property Pin Ties
 - ☒ Horizontal Alignment
 - ☐ Grading
 - ☐ Slope Staking
 - ☒ Minor Structures
 - ☐ Major Structures
 - ☒ One fieldbook for each work category shown on this sheet
 - ☐ Other Fieldbook(s): _____
- The Contractor's surveyor shall submit the following (prior to surveying on the project) to the Engineer:
 - ☐ All required Instrument Calibrations

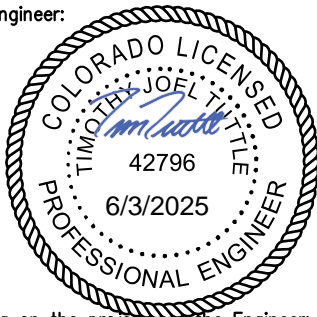

Print Date: 5/2/2025

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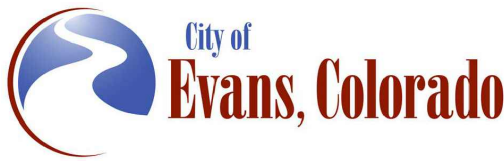
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Sheet Revisions

Date	Comments	Initials



As Constructed

No Revisions:

Revised:

Void:

37TH STREET WIDENING PHASE 2B
SURVEY CONTROL TABULATION

Designer:

T. Tuttle

Detailer:

S. Hemler

Sheet Subset:

SURVCON TAB Subset Sheets: 1 of 1

Structure

Numbers

Project No.

37TH STREET 2B

Drawing Number SCT-001


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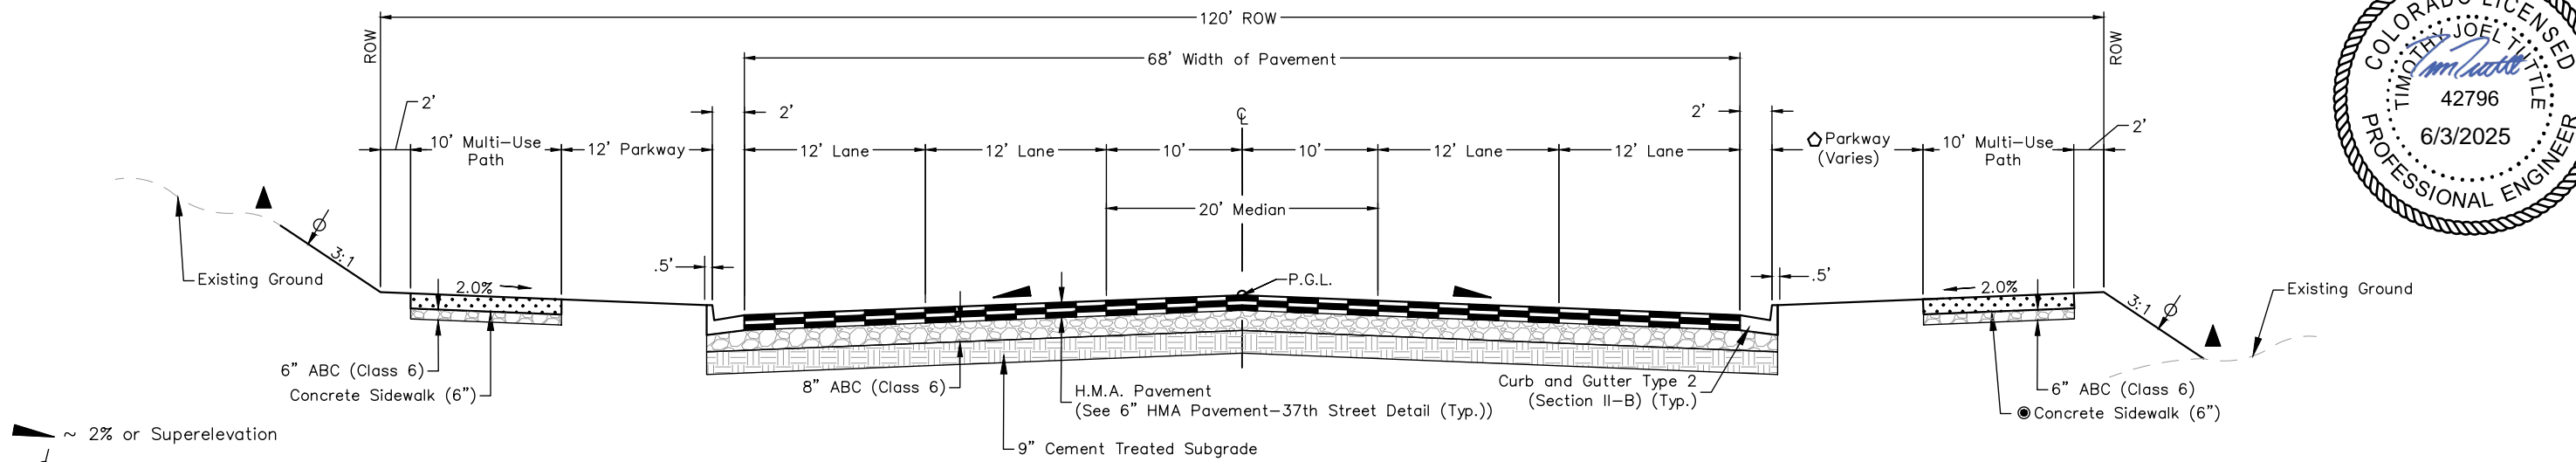
2"
2"
2"
8"
9"

HMA SX (100)
PG 64-28
HMA S (75)
PG 64-22
ABC (Class 6)
Cement Treated Subgrade

Sta. 1114+95.44 to Sta. 1138+80.93




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No Revisions:				37TH STREET 2B
Revised:	Designer: T. Tuttle	Structure		Drawing Number TYP-001
	Detailer: S. Hemler	Numbers		
Void:	Sheet Subset: TYPICALS	Subset Sheets: 1 of 5		Sheet Number 5

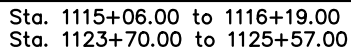

TYPICAL SECTION ROADWAY 37TH STREET
Sta. 1120+78.00 to 1121+56.00
Sta. 1126+54.00 to 1126+77.00

◇ Sta. 1120+78 to Sta. 1121+56 Rt.: 12'
Sta. 1126+54 to Sta. 1126+77 Rt.: 0'

- ~ 2% or Superelevation
- ~ Limits of topsoil placement
- ~ Breakpoints on slopes and in bottoms of ditches shall be rounded during construction for a pleasing appearance. The depth and width of the side ditch shall be varied where necessary in order to provide proper drainage
- The contractor shall apply a layer of Emulsified Asphalt (Slow-Setting) in between each lift of pavement.
- ~ Concrete sidewalk depth to be 8" for all driveways from edge of approach to edge of approach

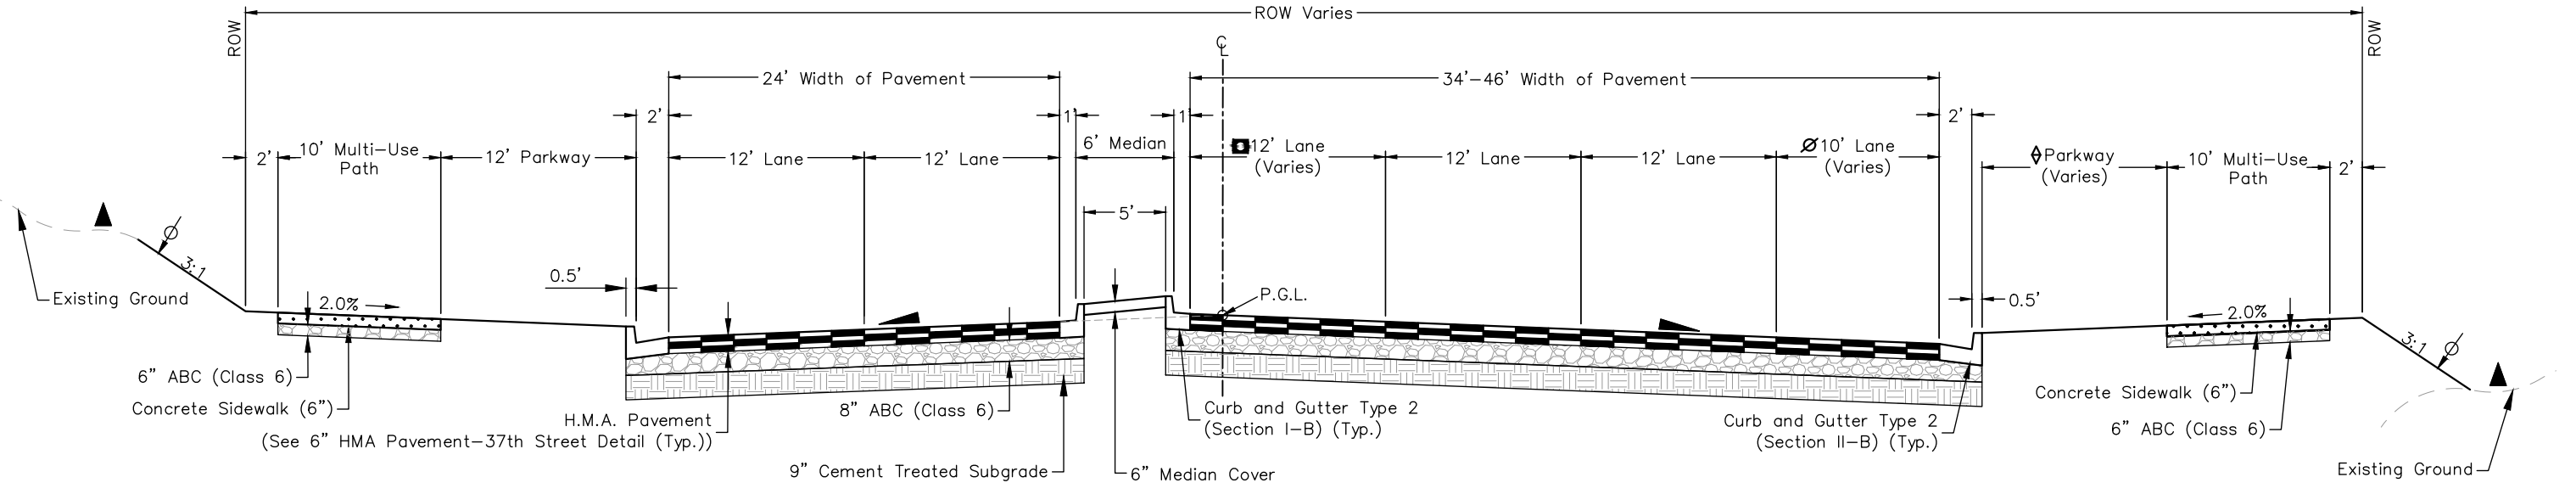

TYPICAL SECTION ROADWAY 37TH STREET
Sta. 1116+56.00 to 1120+78.00

■ Sta. 1116+56 to Sta. 1118+00 Rt.: 0'-12'
Sta. 1118+00 to Sta. 1120+78 Rt.: 12'

◇ Sta. 1116+56 to Sta. 1116+78 Rt.: 0'
Sta. 1116+78 to Sta. 1117+98 Rt.: 0'-10'
Sta. 1117+98 to Sta. 1120+78 Rt.: 10'

◇ Sta. 1116+56 to Sta. 1116+78 Rt.: 12'
Sta. 1116+78 to Sta. 1117+98 Rt.: 12'-0'
Sta. 1117+98 to Sta. 1120+78 Rt.: 0'

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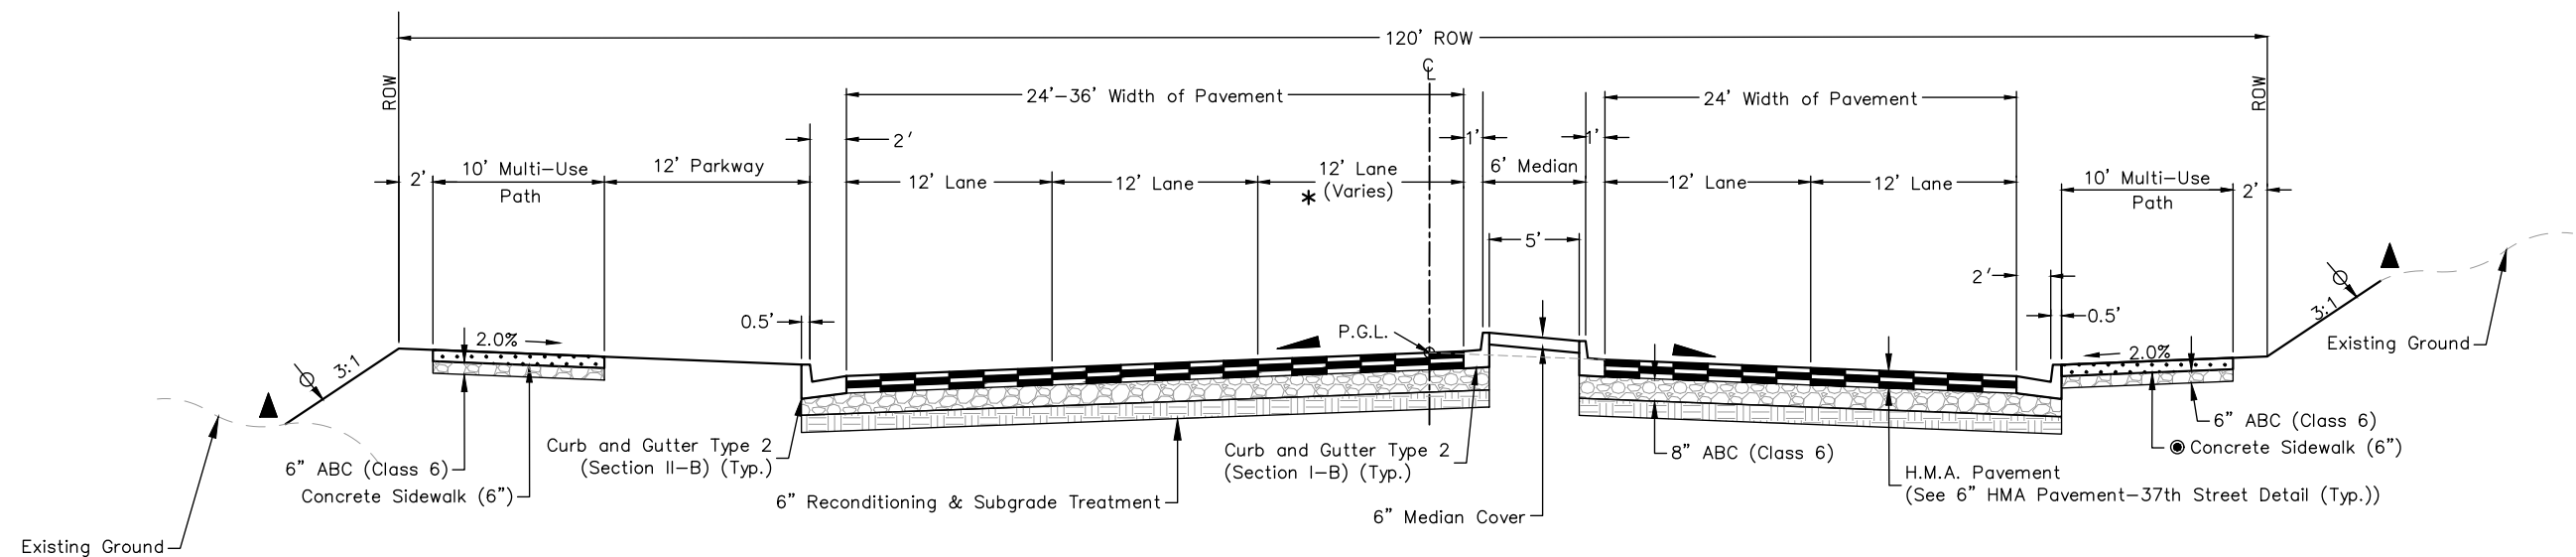
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Vert. Scale: NTS

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	No Revisions:	Designer: T. Tuttle	Structure Numbers	37TH STREET 2B
Revised:		Detailer: S. Hemler		Drawing Number TYP-002
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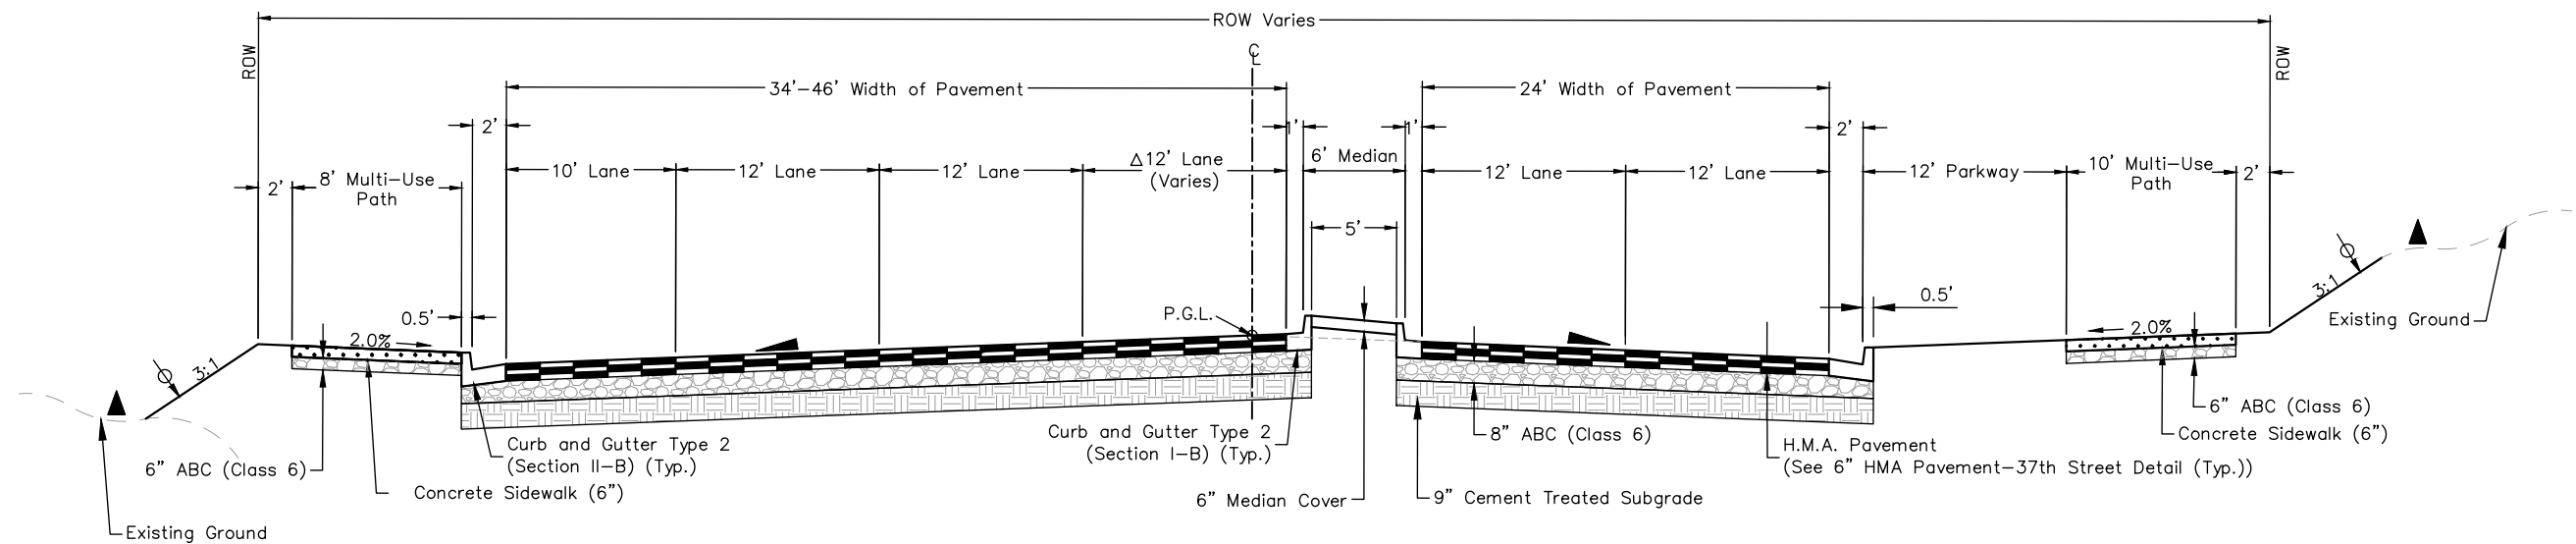
FOR CONSTRUCTION 5/1/2025



*Sta. 1126+77 to Sta. 1127+04 Lt.: 12'
Sta. 1127+04 to Sta. 1128+48 Lt.: 12'-0'


TYPICAL SECTION ROADWAY 37TH STREET
Sta. 1126+77.00 to 1128+48.00

- ~ 2% or Superelevation
- ~ Limits of topsoil placement
- ~ Breakpoints on slopes and in bottoms of ditches shall be rounded during construction for a pleasing appearance. The depth and width of the side ditch shall be varied where necessary in order to provide proper drainage
- The contractor shall apply a layer of Emulsified Asphalt (Slow-Setting) in between each lift of pavement.
- ~ Concrete sidewalk depth to be 8" for all driveways from edge of approach to edge of approach



Δ Sta. 1121+56 to Sta. 1122+26 Lt.: 12'
Sta. 1122+26 to Sta. 1123+70 Lt.: 12'-0'

TYPICAL SECTION ROADWAY 37TH STREET
Sta. 1121+56.00 to 1123+70.00

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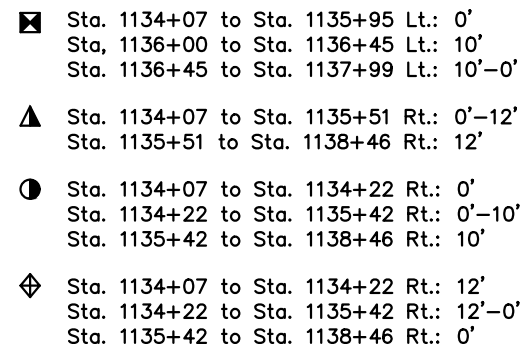
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Date:	Comments	Init.



As Constructed	37TH STREET WIDENING PHASE 2B TYPICAL SECTIONS			Project No.
	No Revisions:			37TH STREET 2B
Revised:	Designer: T. Tuttle	Structure Numbers		Drawing Number TYP-003
Void:	Detailer: S. Hemler			
	Sheet Subset: TYPICALS	Subset Sheets: 3 of 5		Sheet Number 7

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FOR CONSTRUCTION 5/1/2025




- ▲ ~ 2% or Superelevation
- ⌀ ~ Limits of topsoil placement
- ▲ ~ Breakpoints on slopes and in bottoms of ditches shall be rounded during construction for a pleasing appearance. The depth and width of the side ditch shall be varied where necessary in order to provide proper drainage

The contractor shall apply a layer of Emulsified Asphalt (Slow-Setting) in between each lift of pavement.

- ~ Concrete sidewalk depth to be 8" for all driveways from edge of approach to edge of approach




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File Name: TYP P2B-001 TYPICAL SECTIONS.DWG			Date:	Comments	Init.		No Revisions:					37TH STREET 2B		
Horiz. Scale: NTS Vert. Scale: NTS							Revised:		Designer: T. Tuttle		Structure		Drawing Number TYP-004	
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							Sheet Subset: TYPICALS		Subset Sheets: 4 of 5					

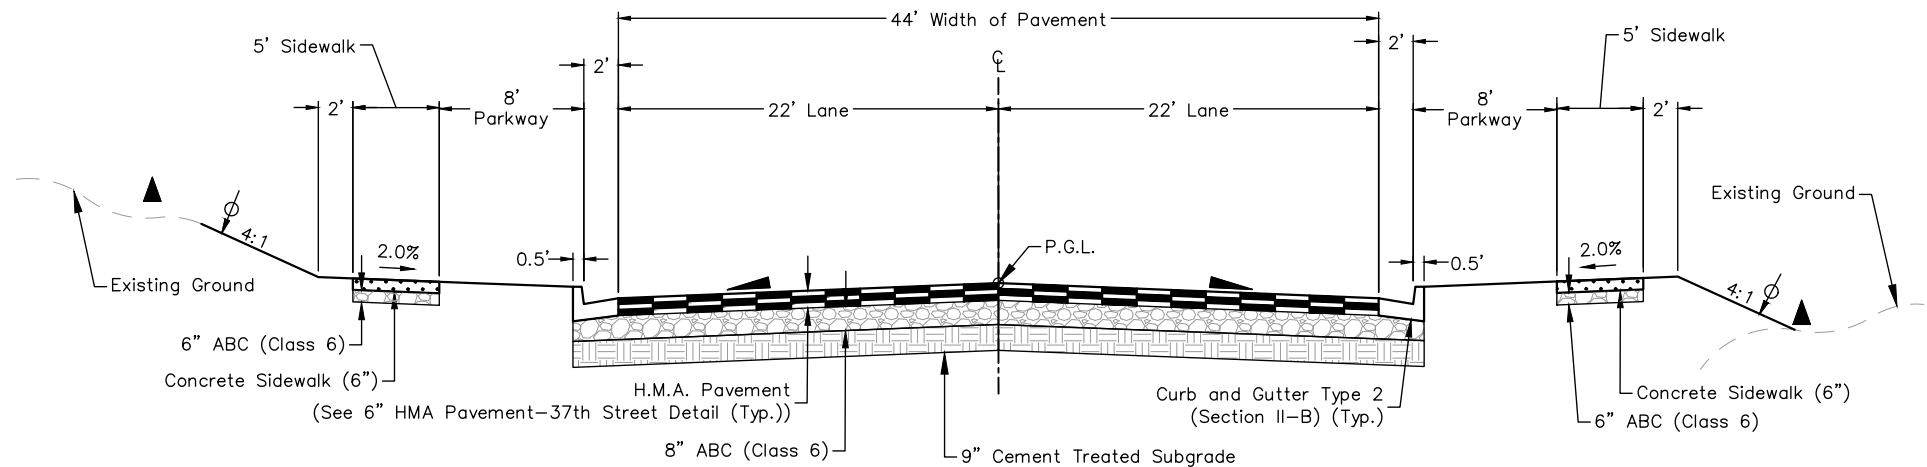


TYPICAL SECTION ROAD APPROACH – 38TH AVENUE
Sta. 1121+19.54 Lt.

- ~ 2% or Superelevation
- ~ Limits of topsoil placement
- ~ Breakpoints on slopes and in bottoms of ditches shall be rounded during construction for a pleasing appearance. The depth and width of the side ditch shall be varied where necessary in order to provide proper drainage

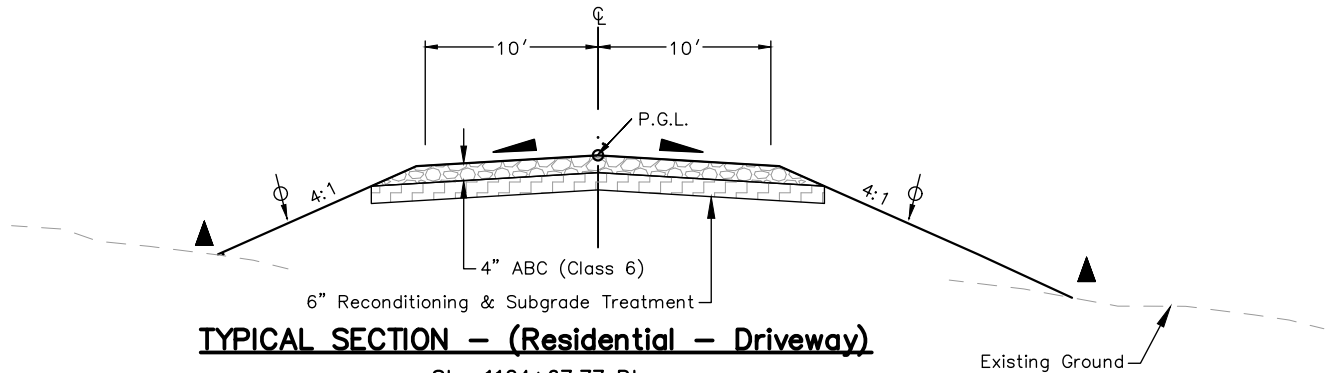

TYPICAL SECTION – (Residential – Driveway)


Sta. 1124+67.77 Rt.
Sta. 1126+54.14 Rt.
Sta. 1128+25.05 Rt.
Sta. 1129+87.09 Rt.
Sta. 1131+60.93 Rt.

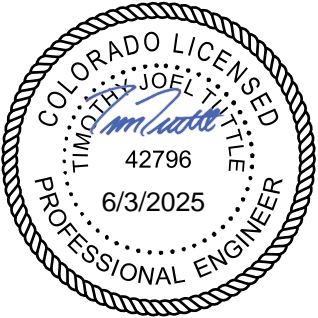

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Date:	Comments	Init.



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	No Revisions:			37TH STREET 2B
Revised:	Designer: T. Tuttle	Structure		Drawing Number TYP-005
Void:	Detailer: S. Hemler	Numbers		Sheet Number 9
Sheet Subset: TYPICALS		Subset Sheets: 5 of 5		

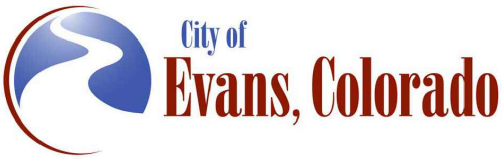FOR CONSTRUCTION 5/1/2025

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GENERAL CONSTRUCTION NOTES

1. The general contractor shall give the City of Evans at least 48 hours advance notice before beginning construction. A pre-construction meeting with the City of Evans is the required method of notifying the City of construction activity.
2. All contractors and subcontractors shall have a set of approved construction documents on site at all times.
3. The general contractor shall call the utility notification center of Colorado (UNCC) at 1-(800)-922-1987, or the nationwide utility contact number (811), to request locates of all underground utilities at least 48 hours prior to commencement of any land disturbing activity.
4. All vertical and horizontal datum information should be obtained using the Evans geodetic survey conducted by Albers, Drexel & Pohly, Inc. January 9, 1998. A copy of final coordinates, elevations, and monument descriptions can be obtained by contacting the City of Evans engineering division at (970) 475 1160.
5. The general contractor shall be responsible for the locations and protection of all existing utilities shown, all existing utilities not shown, and all proposed utilities on these plans.
6. The general contractor shall be responsible for protecting adjacent improvements from damage and erosion. Any adjacent improvements damaged during construction shall, at a minimum, be restored to a state equal to its preconstruction state.
7. The general contractor shall obtain all necessary permits to complete work, and shall comply with all local, state, and federal regulations.
8. Identifying the need for a permit, preparing the application, and paying the submittal and review fees necessary to secure permits will be the total responsibility of the general contractor. A copy of all permits must be on site at all times.
9. All construction activities must comply with the State of Colorado permitting process for storm water discharge, associated with construction activity. For information, contact the Colorado Department of Public Health, and Environment, Water Quality Control Division, SQCD-PE-B2, 4300 Cherry Creek Drive South, Denver, Colorado 80246-1530, attention permits and enforcement section. (303) 692-3500. The water quality permitting page can be accessed at www.cdphe.state.co.us/wq/permitsunit/wqcdpmt.html.
10. If dewatering is to be used, then a state construction dewatering discharge permit is required if discharge is into a storm sewer, channel, irrigation ditch, or any waters of the United States.
11. All work shall be performed in accordance with the recommendations of the geotechnical soils report and pavement design report, produced, or referenced for this project.
12. The general contractor shall perform the work according to all city, county, state, and federal safety and health regulations. In particular, the "trenching" and "open excavation" operations shall comply with all current O.S.H.A. Regulatory requirements.
13. All water line, sanitary sewer, and storm water construction shall conform to the City of Evans standards and specifications latest revision thereof. A current copy can be downloaded from the City of Evans website at www.evanscolorado.gov.
14. All materials and construction shall conform to the City of Evans standards and specifications latest revision thereof. A current copy can be downloaded from the City of Evans website at www.evanscolorado.gov.
15. The City of Evans follows all traffic control standards set forth in the current edition of the "Manual on Uniform Traffic Control Devices" (MUTCD).
16. A traffic control plan must be submitted and approved for any and all utility work performed within the City of Evans right-of-way. Traffic control plans can be emailed to the engineering division attention Mark Oberschmidt at moberschmidt@evanscolorado.gov
17. All street lighting shall conform to the standards and specifications set forth in the City of Evans residential neighborhood design standards.
18. All plantings shall utilize the City of Evans parks and recreation approved landscaping planting list.
19. All seeding shall utilize the City of Evans irrigation design guidelines and the lawn and grass specifications section 02930.

20. All work including warranty work, shall be inspected by a city representative who shall have authority to halt construction when proper construction practices are not being adhered to.
21. There shall be no work performed on the weekends, or holidays except by approval of the City of Evans with a minimum of 24 hours notice.
22. The general contractor shall notify all residents in writing prior to any disruption in service. The notices must have the general contractors phone number and the name of a contact person, and emergency phone number for after hour calls. Notices shall not be left in mailboxes unless properly sent through the U.S. Post office.
23. The general contractor shall be responsible for obtaining their own disposal site for all disposed materials.
24. The engineer who has prepared these plans, by execution and/ or seal hereof does hereby affirm responsibility to the City of Evans, as a beneficiary of said engineer's work, for any errors or omissions contained in these plans. Acceptance of these plans by the City of Evans shall not relieve the engineer who has prepared these plans of such responsibility.
25. It is estimated that 1 sanitary facility will be required on this project.
26. It is estimated that 80 hours will be required for potholing. The contractor shall be responsible for contacting and coordinating with the appropriate utility representatives to be onsite during potholing and shall likewise be responsible for determining the type and location of underground utilities as maybe necessary to avoid damage thereto. The contractor shall refer to the utility specification for additional requirements.

EROSION CONTROL NOTES

1. Erosion control measures must be in place prior to any land disturbing activity commences.
2. A 20' x 20' concrete wash out area or approved equal shall be established near the exit to the site. The area shall be fenced with orange safety fencing on three sides and have an earthen berm, or depression cut into the grade to contain water and concrete from leaving the area. A sign directing all concrete trucks to the washout must be erected at all entrances to the site. The general contractor is responsible for removing all debris from the washout area prior to leaving the site once initial site construction is complete. Burying of the debris is strictly prohibited.
3. Silt fence or approved equal shall be placed along the downgradient perimeter of site.
4. Once final grading is complete, all areas disturbed by construction activities shall be ripped by a grader in corn furrow fashion, or seeded. The furrows shall be perpendicular to the grade of the land. It is the responsibility of the developer/owner to maintain this erosion control measure for the duration of the 2 year warranty period.
5. All areas disturbed by construction activities that will remain as outlots, open space, detention ponds, forebays, or trails shall receive 4 inches of top soil and shall be seeded. Soil preparation, fertilizer, compost, seeding, and mulching will be required. Seed tags will be collected by the City of Evans.
6. All seeding required by either the City of Evans engineering division, or planning division shall utilize the City of Evans irrigation design guidelines, lawn and grass specifications section 02930.
7. Grass seed shall be planted with a grass seed drill (not a grain drill) at a depth of ½" to ¾". Broadcast seeding of grass seed is not acceptable. Straw mulch shall be spread and crimped into the soil at a rate of 4,000 lbs/acre. Hydroseeding and hydromulching is acceptable in lieu of drill seeding and crimping of mulch straw, only in areas that are inaccessible to landscaping equipment, and must be approved by the City of Evans prior to use.
8. The developer/owner is responsible for hiring a contractor to remove all temporary erosion control measures once construction is complete and all open space areas, outlots, detention ponds, forebays, and trail corridors are stabilized with at least 80 percent growth of seeded ground cover.
9. A vehicle tracking control strip 25' x 50'x 6" with 1 ½" to 3" rock is to be placed and maintained by the general contractor at all access points into the construction site.
10. The general contractor shall be responsible for maintaining all erosion control measures and shall be responsible for any and all fines associated with the discharge of sediments, erosion, or pollutants leaving the site as a result of construction activity.



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Sheet Revisions		
Date	Comments	Initials



As Constructed	37TH STREET WIDENING PHASE 2B GENERAL NOTES			Project No.
	No Revisions:			37TH STREET 2B
Revised:	Designer: T. Tuttle	Structure		Drawing Number NT-001
Void:	Detailer: J. Jensen	Numbers		Sheet Number 10
Sheet Subset: NOTES		Subset Sheets: 1 of 3		

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11. No soil stockpile shall exceed 10 feet in height. All soil stockpiles shall be protected from sediment transport by surface roughening, watering, and perimeter silt fencing or earthen berm. Any soil stockpiles remaining after three months from the commencement of construction activities shall be seeded with a temporary cover crop, or removed from the site.

GRADING NOTES

- 1. Grades shown on plans are finished grades. For subgrade elevations, refer to the paving sections and details.
- 2. All work shall be performed in accordance with the recommendations of the geotechnical report produced, or referenced for this project.
- 3. All work shall be performed in accordance with the storm water discharge permit issued for this project.
- 4. Erosion control measures outlined on the erosion control/grading plan must be in place prior to commencement of any land disturbing activity. (stockpiling, stripping, grading, etc.).
- 5. All work shall be performed in accordance with the standards and specifications of the City of Evans, and the approved project construction documents.
- 6. The general contractor is responsible for verifying the plan alignment and grade in all roadways, parcels/lots, open spaces, ditches, swales, detention ponds, and forebays so that all drainage is directed in a positive flow to all drainage structures indicated on the construction plans at the completion of construction.
- 7. All utilities (non-potable water lines, potable water lines, sanitary sewer lines, storm drainage, dry utility crossings (gas, electric, telephone, and cable t.v.), manholes, and inlets) within the road right-of-way shall be installed prior to roadway subgrade preparation.
- 8. Subgrade shall be ripped, compacted, and shaped per City standards and specifications. The City of Evans engineering division shall be notified 24 hours in advance to schedule a proof roll of all subgrade where roadways, sidewalks, pans, aprons, curb and gutter, and other public improvements will be placed.
- 9. All parkways, and properties adjacent to sidewalks, shall be backfilled and compacted in a timely manner to prevent weather related standing water from entering the roadway subgrade. The general contractor shall be held liable for any and all damage caused by failure to backfill these areas in a timely manner.
- 10. Testing data by a third party testing company for compaction of all utility trenches, subgrade, and base material is to be submitted to the City of Evans in a timely manner. Email reports to the engineering division attention Mark Oberschmidt at moberschmidt@evanscolorado.gov
- 11. Moisture Density control will be required for the full depth of those embankments on this project. The base of fill areas should be scarified to a depth of not less than 6 inches and compacted to not less than 95% of maximum density ±2% of optimum moisture content as determined by AASHTO T99 or as recommended by a geotechnical engineer, prior to placement of embankment material.
- 12. The minimum thickness of topsoil shall be 4 inches.

ROADWAY IMPROVEMENT NOTES

- 1. All work shall be performed in accordance with the standards and specifications of the City of Evans, and the approved project documents.
- 2. Improvement projects which do not have a developer’s agreement shall be required by the City of Evans to execute an application and permit for excavation / construction in public right of way.
- 3. Concrete and asphaltic mix design shall be submitted by the supplier and approved by the City of Evans prior to roadway construction.
- 4. All existing curb and gutter, sidewalk, and ADA ramps damaged during construction shall be repaired at the general contractor’s expense, prior to acceptance of completed improvements.
- 5. When an existing street is to be cut, the street must be restored to a condition equal to or better than its original condition. Saw cuts should be a clean straight vertical line parallel or perpendicular to the flow of traffic. Patches shall be 1 inch greater in depth than the existing asphalt material that was removed or as directed by the City.

- 6. All large patches (greater than 10’ wide and 20’ long) shall be paved with by an asphalt lay-down machine. In streets where more than one cut is made, an overlay of the entire street width, including the patched area may be required.
- 7. Street subgrades shall be scarified the top 12 inches and recompact prior to sub-base installation. No base material shall be laid until the subgrade has been inspected by scheduling a proof roll with the City of Evans, and approved by the City of Evans engineering division.
- 8. Prior to pavement installation base material shall be inspected by a proof roll scheduled with the City of Evans, and approved by the City of Evans engineering division.
- 9. Prior to paving an herbicide treatment shall be applied for all new paved areas. It is estimated that 7.9 acres of herbicide treatment will be needed.
- 10. Valve boxes, manholes, cleanouts, and survey monument boxes are required to be brought up to the subgrade level prior to pavement installation. All locations and distances of the valve boxes and manholes should be clearly labeled on the curb and gutter in white paint. Once the pavement is installed all valve boxes, manholes, cleanouts, and survey monument boxes shall be raised to ¼” below asphalt grade and have a one foot concrete collar installed around the outer diameter of the fittings.
- 11. Nuclear gauge testing data by a third party testing company for compaction and moisture content of all utility trenches, subgrade, and base material is to be submitted to the City of Evans in a timely manner. Email reports to moberschmidt@evanscolorado.gov. Engineering division.
- 12. Concrete curb and gutter, sidewalks, and street paving shall not begin until all testing data has been received by the City of Evans, and subgrade proof rolls accepted by the City of Evans engineering division has been completed.
- 13. It is estimated that 100 hours of proof rolling will be required on this project.
- 14. The general contractor shall maintain all necessary barricades, permanent signs, temporary signs, pavement markings, and other traffic control devices daily during construction and between phases of construction.
- 15. The roadway and related work areas shall be left with a clean and finished appearance. In no case shall material removed from the right-of-way be stockpiled and left in such a manner as to pose a hazard to the public. The general contractor shall remove all debris from the sidewalks, curb and gutters, pans, and driveways at the construction site and dispose of the debris in an appropriate location.
- 16. For preliminary plan quantities of pavement materials, the following rates of application were used:
Tack Coat Diluted Emulsified Asphalt.....@ 0.1 Gals./Sq. Yd.(Diluted)
Hot Mix Asphalt.....@ 110 Lbs./Sq. Yd./Inch
Aggregate Base Course.....@ 133 Lbs./Cu. Ft.
- 17. Diluted emulsified asphalt for tack coat shall consist of 1 part emulsified asphalt and 1 part water.
- 18. Water shall be used as a dust palliative where required. Locations shall be as directed by the Engineer.
- 19. The Contractor shall not park any vehicles or equipment in, or disturb any areas not approved by the Engineer.
- 20. Prior to placing bituminous pavement, the paved surface shall be swept and cleaned. This will not be paid for separately but shall be included in the cost of the Hot Mix Asphalt item.
- 21. The Contractor shall coordinate the shouldering operation such that full compliance to existing grades (3:1 or flatter slopes) is obtained on a daily basis following the paving operation for the affected area prior to opening the pavement to normal traffic operations unless otherwise approved by the Engineer.
- 22. Excavation required for compaction of bases of cuts and fills will be considered subsidiary to that operation and will not be paid for separately.
- 23. Where new pavement is to abut existing pavement, the existing pavement shall be removed to a neat vertical line using a cutting saw or other methods as approved by the Engineer, Saw cutting asphalt will not be paid for separately but shall be included in the cost of Removal of Asphalt Mat.



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File Name: NT P2B-001 GENERAL NOTES.DWG

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Sheet Revisions		
Date	Comments	Initials

As Constructed	37TH STREET WIDENING PHASE 2B GENERAL NOTES			Project No.
No Revisions:				37TH STREET 2B
Revised:	Designer: T. Tuttle	Structure	Numbers	Drawing Number NT-002
Void:	Detailer: J. Jensen			Sheet Number 11
		Sheet Subset: NOTES	Subset Sheets: 2 of 3	

FOR CONSTRUCTION 5/1/2025

Plot Date: 5/2/2025 6:36 AM Plotted By: Sarah Hemler
P:\Q-PROJECTS\YORINE PROJECTS\33001\EVANS 37TH ST AND 47TH AVE PLAN\202 COMPUTER DESIGN FILES\P2 - PHASE 2B\202 SHEET FILES\NT P2B-001 GENERAL NOTES.DWG


24. The Contractor shall protect all existing survey monumentation designated to remain from damage during construction operations. Any monuments disturbed by the Contractor that are not designated for relocation shall be reset at the Contractor’s expense. The Contractor and Engineer shall note those monuments in the field prior to construction.
25. The following shall be furnished with each bituminous paver:
- a. A ski type device at least 30 feet in length
 - b. Short ski or shoe
 - c. 1500 feet of control line and stakes
26. Any layer of bituminous pavement that is to have a succeeding layer placed thereon shall be completed full width before succeeding layer is placed
27. Millings shall become the property of the City of Evans and be delivered to 1800 40th Street.

TRAFFIC SIGNING & PAVEMENT MARKING NOTES

- 1. The City of Evans follows all traffic signage standards set forth in the current edition of the “Manual on Uniform Traffic Control Devices” (MUTCD) and CDOT’s M&S standards.
- 2. Roadway
- 3. Locations of existing signs are approximate. The general contractor shall coordinate with the City of Evans to determine if existing signs not shown on the construction plans shall be reset or removed.
- 4. All signs and pavement markings shall be furnished and installed in accordance with MUTCD standards.
- 5. The contractor installing the signs shall be responsible for locating and protecting all underground utilities.
- 6. Street and avenue signs shall be extruded aluminum 6” x 30” minimum, City of Evans standard reflective green background with white block lettering, city logo, and numbering.
- 7. All signs shall be mounted with vandal-proof bolts.
- 8. All signs shall be installed on Unistrut Telespar type perforated posts with anchors at the proper height as per current MUTCD standards.
- 9. Sign posts shall meet or exceed the following:
 - A. Posts – 1 ¾” x 1 ¾”, 12 gauge, ASTM specification number A4446, grade A, drilled on 1” centers.
 - B. Anchors – 2” x 2”, 12 gauge, ASTM specification number A4446, drilled on 1” centers.
 - C. All posts and anchors shall be galvanized to ASTM specification A52 coating designation G90.
- 10. The City of Evans follows all pavement marking standards set forth in the current edition of the “Manual on Uniform Traffic Control Devices” (MUTCD) and CDOT’s M&S Standards.
- 11. All surfaces shall be thoroughly cleaned prior to installation of striping or markings to prepare the pavement surface for proper adhesion. All symbols, including arrows, onlys, crosswalks, stop bars, etc. shall be pre-formed thermoplastic per the City of Evans standards.
- 12. Markings that must be visible at night shall be retroreflective unless ambient illumination assures that the markings are adequately visible.
- 13. Removal of existing pavement markings shall be accomplished by a method that does not materially damage the surface or texture of the pavement. The pavement markings shall be removed to the extent that they will not be visible under day or night conditions. Under no circumstances shall black paint be used to cover existing markings, or mistakes in striping.

ENVIRONMENTAL NOTES:

- 1. CDPS Stormwater Construction Permit
If project activities result in one acre or more of earth disturbance a CDPS permit will be required. The Contractor shall not commence permit-related work until the permit is received. Work performed must be consistent with that detailed in the stormwater management plan.
- 2. Wetlands, Threatened and Endangered Species, and Black-Tailed Prairie Dog Habitat
Work activities including the movement and placement of vehicles and equipment shall not disturb wetlands, threatened and endangered species (or their habitat), or black-tailed prairie dog colonies. If any such sites are encountered, the engineer shall be notified so that all applicable clearances and permits may be obtained. CDOT Specification 240 shall be followed for any prairie dog management requirements.
- 3. Burrowing Owls
Burrowing owls are a state threatened species and are protected under the migratory bird treaty act. No human encroachment or disturbance within 150 feet of the nest site from March 15 through October 31. If project activities are to take place between these times, a burrowing owl survey must be completed by the contractor’s biologist before construction activities take place. If burrowing owls are identified on or adjacent to the project, avoidance measures shall be followed as outlined above.
- 4. MBTA
The Migratory Bird Treaty Act (MBTA) protects migratory birds and their nests and eggs. Wildlife biologist hours have been provided for incidental work described in these notes. For projects that could potentially have an impact, the following conditions apply:
 - A. Tree trimming/removal
Tree trimming and/or removal activities shall be completed before birds begin to nest or after the young have fledged. In Colorado, most nesting and rearing activities occur between April 1 and August 31. A nesting bird survey shall be conducted by the contractor’s biologist before any tree trimming or removal activities begin between April 1 and August 31.
 - B. Bridge/box culvert work
Bridge or box culvert work that may disturb nesting birds shall be completed before birds begin to nest or after the young have fledged. If work activities are planned between April 1 and August 31, nests shall be removed (before nesting begins) and appropriate measures taken to assure no new nests are constructed. Failure to remove and keep nests from becoming established may impact project construction.
 - C. Clearing/grubbing activities
Clearing and grubbing of vegetation that may disturb ground nesting birds shall be completed before birds begin to nest or after the young have fledged. If work activities are planned between April 1 and August 31, vegetation shall be removed and/or trimmed to a height of six (6) inches or less prior to April 1. Once vegetation has been removed and/or trimmed, appropriate measures, i.e. repeated mowing/trimming, shall be implemented to assure vegetation does not grow more than six (6) inches. Failure to maintain vegetation height of six (6) inches or less may impact project construction.
 - D. Deterring nesting of migratory birds
In order to deter migratory birds from returning to nesting sites, all nests should be removed within 50 feet of the limits of construction prior to nesting season and appropriate measures taken to assure no new nests are constructed. In Colorado, nesting and rearing activities occur between April 1 and August 31. If construction begins during this timeframe, a nesting bird survey shall be conducted by the contractor’s biologist up to 7 days before any construction activities begin.
 - E. Birds of prey
For birds of prey that could potentially nest near the project site, please contact and/or refer to Colorado Parks and Wildlife’s "Recommended buffer zones and seasonal restrictions for Colorado raptors" guidelines available at Colorado Parks and Wildlife district offices and at <https://cpw.state.co.us/documents/wildlifespecies/livingwithwildlife/raptorbufferguidelines2008.pdf>.

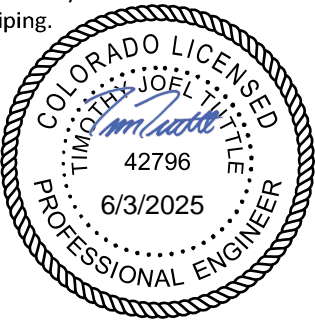

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Sheet Revisions		
Date	Comments	Initials


	As Constructed		37TH STREET WIDENING PHASE 2B GENERAL NOTES		Project No.
	No Revisions:				37TH STREET 2B
	Revised:	Designer: T. Tuttle	Structure		Drawing Number NT-003
	Void:	Detailer: J. Jensen	Numbers		Sheet Number 12
		Sheet Subset: NOTES	Subset Sheets: 3 of 3		

Plot Date: 4/16/2025 3:19 PM Plotted By: Sarah Hemler
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(R-1)

INDEX			CONTRACT ITEM NO.	CONTRACT ITEM	UNIT	ROADWAY				PROJECT TOTALS	
BOOK	PAGE	SHEET				PLAN	AS CONST.			PLAN	AS CONST.
			201-00000	Clearing and Grubbing	LS	1				1	
			202-00010	Removal of Tree	EACH	44				44	
			202-00012	Removal of Tree Stump	EACH	1				1	
			202-00019	Removal of Inlet	EACH	2				2	
			202-00035	Removal of Pipe	LF	1,561				1,561	
			202-00070	Removal of Barricade	EACH	2				2	
			202-00200	Removal of Sidewalk	SY	995				995	
			202-00201	Removal of Curb	LF	580				580	
			202-00220	Removal of Asphalt Mat	SY	11,245				11,245	
			202-00250	Removal of Pavement Marking	SF	175				175	
			202-00300	Removal of Building	LS	1				1	
			202-00810	Removal of Ground Sign	EACH	7				7	
			202-01000	Removal of Fence	LF	172				172	
			203-00010	Unclassified Excavation (Complete In Place)	CY	11,245				11,245	
			203-01100	Proof Rolling	HOUR	100				100	
			203-01500	Blading	HOUR	20				20	
			203-01550	Dozing	HOUR	20				20	
			203-01597	Potholing	HOUR	80				80	
			206-00105	Cement Treated Base	CY	5,405				5,405	
			207-00205	Topsoil	CY	751				751	

INDEX			CONTRACT ITEM NO.	CONTRACT ITEM	UNIT	ROADWAY				PROJECT TOTALS	
BOOK	PAGE	SHEET				PLAN	AS CONST.			PLAN	AS CONST.
			207-00405	Topsoil (Special)	CY	1,317				1,317	
			208-00002	Erosion Log Type 1 (12 Inch)	LF	3,100				3,100	
			208-00035	Aggregate Bag	LF	300				300	
			208-00046	Pre-Fabricated Concrete Washout Structure (Type I)	EACH	2				2	
			208-00053	Storm Drain Inlet Protection (Type I) (84 Inch)	EACH	6				6	
			208-00054	Storm Drain Inlet Protection (Type II)	EACH	3				3	
			208-00075	Pre-fabricated Vehicle Tracking Pad	EACH	4				4	
			208-00103	Removal and Disposal of Sediment (Labor)	HOUR	10				10	
			208-00105	Removal and Disposal of Sediment (Equipment)	HOUR	20				20	
			208-00106	Sweeping (Sediment Removal)	HOUR	20				20	
			208-00107	Removal of Trash	HOUR	10				10	
			208-00207	Erosion Control Management (ECM)	LS	1				1	
			210-00010	Reset Mailbox Structure	EACH	2				2	
			210-00050	Reset Fire Hydrant	EACH	1				1	
			210-00810	Reset Ground Sign	EACH	1				1	
			210-01710	Reset Valve	EACH	4				4	
			210-04010	Adjust Manhole	EACH	5					
			212-00006	Seeding (Type I)	ACRE	1.0					
			212-00022	Seeding (Type II)	ACRE	0.9					
			212-00032	Soil Conditioning	ACRE	1.9					

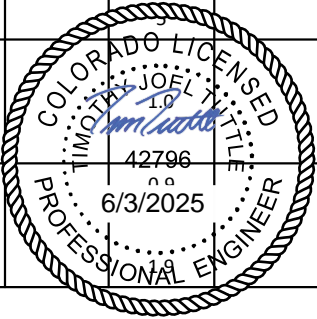

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Sheet Revisions		
Date:	Comments	Init.
4/16/25	Added irrigation items and quantities	SAH

As Constructed

No Revisions:

Revised:

Void:

37TH STREET WIDENING PHASE 2B
SUMMARY OF APPROXIMATE
QUANTITIES

Designer: T. Tuttle

Detailer: S. Hemler

Sheet Subset: SAQ

Structure Numbers

Subset Sheets: 1 of 3

Project No.

37TH STREET 2B

Drawing Number SAQ-001


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INDEX			CONTRACT ITEM NO.	CONTRACT ITEM	UNIT	ROADWAY				PROJECT TOTALS	
BOOK	PAGE	SHEET				PLAN	AS CONST.			PLAN	AS CONST.
			213-00004	Mulching (Weed Free Straw)	ACRE	1.9				1.9	
			213-00005	Wood (Organic) Mulch (Brown Western Red Cedar)(4" Depth)	CY	228				228	
			213-00012	Spray-on Mulch Blanket	ACRE	1.0				1.0	
			213-00061	Mulch Tackifier	LB	420				420	
			213-00067	Inorganic Mulch (1.5" to 3" Tan River Rock)(3" Depth)(Special)	SF	5,324				5,324	
			213-00318	18 Inch Root Barrier	LF	1,280				1,280	
			213-00440	Metal Landscape Border (1/8" x 4")	LF	1,054				1,054	
			213-00705	Landscape Boulder A (Siloam)(4'l. x 2'w. x 2'h.)(Special)	EACH	44				44	
			213-00705	Landscape Boulder B (Siloam)(3'l. x 2'w. x 2'h.)(Special)	EACH	39				39	
			213-00705	Landscape Boulder C (Siloam)(2'l. x 2'w. x 2'h.)(Special)	EACH	54				54	
			214-00220	Deciduous Tree (2" Cal.)	EACH	35				35	
			214-00230	Deciduous Ornamental Tree (1.5" Cal.)	EACH	18				18	
			214-00350	Deciduous Shrub (5 Gal.)	EACH	118.0				118.0	
			214-00650	Evergreen Shrub (5 Gal.)	EACH	27				27	
			214-00908	Ornamental Grasses and Perennials (1 Gal.)	EACH	209.0				209.0	
			217-00000	Herbicide Treatment	ACRE	3.2				3.2	
			240-00000	Wildlife Biologist	HOURL	8				8	
			304-06007	Aggregate Base Course (Class 6)	CY	5,577				5,577	
			403-33741	Hot Mix Asphalt (Grading S)(75)(PG 64-22)	TON	4,154				4,154	
			403-34851	Hot Mix Asphalt (Grading SX)(100)(PG 64-28)	TON	2,077				2,077	

INDEX			CONTRACT ITEM NO.	CONTRACT ITEM	UNIT	ROADWAY				PROJECT TOTALS	
BOOK	PAGE	SHEET				PLAN	AS CONST.			PLAN	AS CONST.
			411-10255	Emulsified Asphalt (Slow Setting)	GAL	1,642				1,642	
			412-00800	Concrete Pavement (8 Inch)	SY	174				174	
			603-01185	18 Inch Reinforced Concrete Pipe (Complete In Place)	LF	280				280	
			603-01215	24 Inch Reinforced Concrete Pipe (Complete In Place)	LF	502				502	
			603-01305	30 Inch Reinforced Concrete Pipe (Complete In Place)	LF	93				93	
			603-50012	12 Inch Plastic Pipe	LF	1,141				1,141	
			604-00310	Inlet Type C (Modified)	EACH	2				2	
			604-00505	Inlet Type D (5 Foot)	EACH	1				1	
			604-19205	Inlet Type R L 10 (5 Foot)	EACH	1				1	
			604-19210	Inlet Type R L 10 (10 Foot)	EACH	3				3	
			604-196XX	Inlet (Filter System)	EACH	3				3	
			604-30010	Manhole Slab Base (10 Foot)	EACH	5				5	
			604-XXXXX	Concrete Sidewalk Culvert	EACH	1				1	
			607-11525	Fence (Plastic)	LF	50				50	
			608-00006	Concrete Sidewalk (6 Inch)	SY	4,845				4,845	
			608-00008	Concrete Sidewalk (8 Inch)	SY	159				159	
			608-00010	Concrete Curb Ramp	SY	206					
			609-21010	Curb and Gutter Type 2 (Section I-B)	LF	4,491					
			609-21020	Curb and Gutter Type 2 (Section II-B)	LF	4,687					
			609-24008	Gutter Type 2 (8 Foot)	LF	74					



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(R-1)	Sheet Revisions		
	Date:	Comments	Init.
	4/16/25	Added irrigation items and quantities	SAH

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No Revisions:

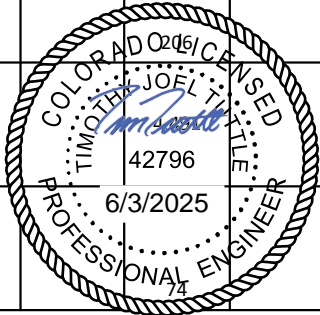Revised:

Void:

37TH STREET WIDENING PHASE 2B
SUMMARY OF APPROXIMATE
QUANTITIES

Designer: T. Tuttle

Detailer: S. Hemler

Sheet Subset: SAQ

Structure Numbers

Subset Sheets: 2 of 3

Project No.

37TH STREET 2B

Drawing Number SAQ-002

Sheet Number 14

Plot Date: 4/16/2025 3:25 PM Plotted By: Sarah Hemler
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INDEX			CONTRACT ITEM NO.	CONTRACT ITEM	UNIT	ROADWAY				PROJECT TOTALS	
BOOK	PAGE	SHEET				PLAN	AS CONST.			PLAN	AS CONST.
			610-00026	Median Cover Material (6 Inch Patterned Concrete)	SF	10,400				10,400	
			614-00011	Sign Panel (Class 1)	SF	112				112	
			614-00214	Steel Sign Post (1.75x1.75 Inch Tubing)	LF	171				171	
			619-00007	Connect to Existing Waterline	EACH	4				4	
			619-50640	8 Inch PVC C900 DR18	LF	88				88	
			619-50800	10 Inch PVC C900 DR18	LF	570				570	
			619-75064	8 Inch Gate Valve	EACH	2				2	
			619-75080	10 Inch Gate Valve	EACH	2				2	
			620-00020	Sanitary Facility	EACH	1				1	
			623-07006	3/4 Inch Water Meter	EACH	2				2	
			623-09900	Irrigation System	LS	1				1	
			625-00000	Construction Surveying	LS	1				1	
			626-00000	Mobilization	LS	1				1	
			626-01104	Public Information Services (Tier IV)	LS	1				1	
			627-00008	Modified Epoxy Pavement Marking	GAL	15				15	
			627-30405	Preformed Thermoplastic Pavement Marking (Word-Symbol)	SF	251				251	
			627-30410	Preformed Thermoplastic Pavement Marking (Xwalk-Stop Line)	SF	618				618	
			629-01004	Survey Monument (Type 4)	EACH	6				6	
			630-00000	Flagging	HOUR	1,000				1,000	
			630-00007	Traffic Control Inspection	DAY	36				36	

INDEX			CONTRACT ITEM NO.	CONTRACT ITEM	UNIT	ROADWAY				PROJECT TOTALS	
BOOK	PAGE	SHEET				PLAN	AS CONST.			PLAN	AS CONST.
			630-00012	Traffic Control Management	DAY	90				90	
			630-80337	Barricade (Type 3M-C) (Temporary)	EACH	6				6	
			630-80341	Construction Traffic Sign (Panel Size A)	EACH	40				40	
			630-80350	Vertical Panel	EACH	50				50	
			630-80356	Advance Warning Flashing or Sequencing Arrow Panel (A Type)	EACH	2				2	
			630-80360	Drum Channelizing Device	EACH	200				200	
			630-80380	Traffic Cone	EACH	100				100	
			700-	F/A Irrigation	F A	1				1	



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37TH STREET WIDENING PHASE 2B
SUMMARY OF APPROXIMATE
QUANTITIES

Designer: T. Tuttle

Detailer: S. Hemler

Sheet Subset: SAQ

Structure Numbers

Subset Sheets: 3 of 3

Project No.

37TH STREET 2B

Drawing Number SAQ-003

Sheet Number 15

Plot Date: 4/16/2025 3:22 PM Plotted By: Sarah Hemler
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SUMMARY OF EARTHWORK QUANTITIES	
UNCLASSIFIED EXCAVATION (COMPLETE IN PLACE) (NET)	CUBIC YARDS
FOR ROADWAY	9,780
ROAD APPROACHES	145
FOR MANHOLES/INLETS/PIPES	238
FOR IRRIGATION	593
CUT SLOPE TREATMENT	489
TOTAL	11,245
FOR INFORMATION ONLY	
EMBANKMENT MATERIAL	CUBIC YARDS
FOR ROADWAY	6,576
FOR ROAD APPROACHES	180
FOR MANHOLES/INLETS/PIPES	515
FOR IRRIGATION	615
TOTAL	7,886
EARTHWORK QUANTITIES BALANCE	
UNCLASSIFIED EXCAVATION	CUBIC YARDS
TOTAL UNCLASSIFIED EXCAVATION	11,245
TOTAL	11,245
EMBANKMENT (NET)	
TOTAL	7,886
*TOTAL EXCESS MATERIAL	3,360

A minimum R-value for all imported embankemnt will be 45.
* Excess embankment material will become property of City of Evans


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TABULATION OF PAVEMENT ITEMS				
STATION	HOT MIX ASPHALT PAVING		EMULSIFIED ASPHALT (SLOW-SETTING)	AGGREGATE BASE COURSE (CLASS 6)
	HOT MIX ASPHALT (GRADING SX) (100) (PG 64-28)	HOT MIX ASPHALT (GRADING S) (75) (PG 64-22)		
	TONS	TONS	GAL	CY
Stampede Drive to 35th Avenue				
1115+05.78 - 1138+80.00			1,584	4,858
1st Lift	1,742			
2nd Lift		1,742		
3rd Lift		1,742		
Road Approaches				
38th Ave. - 1121+19.54 Lt.			41	108
1st Lift	45			
2nd Lift		45		
3rd Lift		45		
1124+67.77 Rt.				4
1126+54.14 Rt.				16
1128+25.05 Rt.				7
1129+87.09 Rt.				14
1131+60.93 Rt.				13
Murphy Oil - 1135+82.63 Lt.			17	50
1st Lift	19			
2nd Lift		19		
3rd Lift		19		
SUBTOTALS	1,806	3,612	1,642	5,070
Irregularities (15%)	271	542		
Irregularities (10%)				507
TOTALS	2,077	4,154	1,642	5,577



Print Date: 4/16/2025	
File Name: TAB P2B-001 TABULATION.DWG	
Horiz. Scale: N/A	Vert. Scale: N/A
	12076 Grant Street
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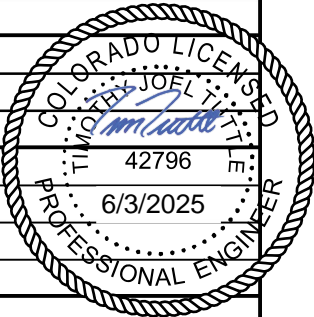
Sheet Revisions		
Date	Comments	Initials
4/16/25	Updated earthwork to include irrigation line work	SAH



As Constructed	37TH STREET WIDENING PHASE 2B TABULATIONS			Project No.
No Revisions:				37TH STREET 2B
Revised:	Designer: T. Tuttle	Structure		Drawing Number TAB-001
Void:	Detailer: S. Hemler	Numbers		Sheet Number 16
Sheet Subset: TABS		Subset Sheets: 1 of 4		

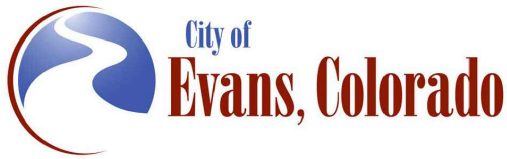Plot Date: 5/1/2025 6:36 AM Plotted By: Sarah Hemler
C:\Q-PROJECTS\37TH STREET WIDENING\37TH ST AND 47TH AVE PLAN\3700-COMPUTER DESIGN FILES\TAB P2B-001 TABULATION.DWG

TABULATION OF REMOVALS, RESETS, AND ADJUSTMENTS																	
STATION	SIDE	REMOVAL OF TREE	REMOVAL OF TREE STUMP	REMOVAL OF INLET	REMOVAL OF PIPE	REMOVAL OF FENCE	REMOVAL OF SIDEWALK	REMOVAL OF CURB	* REMOVAL OF ASPHALT MAT	REMOVAL OF PAVEMENT MARKING	RESET MAILBOX STRUCTURE	RESET FIRE HYDRANT	RESET VALVE	ADJUST MANHOLE	REMOVAL OF BUILDING	REMOVAL OF BARRICADE	REMARKS
		EA	EA	EA	LF	LF	SY	LF	SY	SF	EA	EA	EA	EA	LS	EA	
1110+74.45	Rt.									58							
1114+93.00	Rt.									58							
1115+04.10	Rt. & Lt.															2	Includes removal of sign panel
1115+05.78 - 1138+90.44	Rt. & Lt.								10290								
1116+61.92 - 1117+13.59	Rt.	6															
1117+06.24	Rt.													1			
1117+99.50 - 1119+09.10	Rt.	4															
1120+94.60	Lt.							37									
1121+05.80	Lt.													1			
1121+38.70	Lt.												1				Water Valve
1121+43.21	Lt.							38									
1121+52.11 - 1131+75.59	Lt.						913										
1117+13.88 - 1127+61.02	Rt.				1053												
1123+81.14 - 1124+03.95	Rt.				33												
1124+58.54	Rt.							60									From Driveway
1124+76.95	Rt.							55									From Driveway
1124+84.40 - 1126+65.09	Rt.	22															
1125+05.75	Lt.													1			
1126+20.30 - 1126+93.50	Rt.							202									From Driveway
1127+30.72	Lt.												1				Water Valve
1127+37.00	Lt.	1															
1127+37.67	Lt.											1					
1127+40.80	Lt.												1				Water Valve
1127+66.63	Rt.			1	445												Relative Appurtences Included in the
1127+67.91	Lt.			1	30												Work. 12" & 18" CMP, 18" PVC, and One
																	Unknown Diameter and Type. 18" PVC is 47
1127+76.55 - 1128+48.55	Rt.	5															
1127+92.75	Lt.	1															
1128+12.49	Rt.							35									
1128+35.61	Rt.							69									From Driveway
1128+41.35	Rt.										1						
1128+75.26	Lt.													1			
1128+94.14	Rt.		1														
1129+07.31	Lt.													1			
1130+69.25 - 1132+07.26	Rt.	5															
1131+43.14	Rt.										1						
1132+76.18	Rt.														1		
1133+10.13 - 1134+11.15	Rt.					172											
1135+72.87	Lt.												1				Water Valve
1138+29.04	Lt.						51	65									
1138+50.02	Rt.						30	19									
1139+68.46 - 1140+87.19	Lt.									59							
TOTALS		44	1	2	1561	172	995	580	10,290	175	2	1	4	5	1	2	



Print Date: 5/2/2025

File Name: TAB P2B-001 TABULATION.DWG

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Vert. Scale: N/A

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Sheet Revisions		
Date	Comments	Initials

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No Revisions:

Revised:

Void:

37TH STREET WIDENING PHASE 2B
TABULATIONS

Designer: T. Tuttle

Detailer: G. Garramone

Sheet Subset: TABS

Structure Numbers

Subset Sheets: 2 of 4

Project No.

37TH STREET 2B

Drawing Number TAB-002

Sheet Number 17

FOR CONSTRUCTION 5/1/2025

TABULATION OF CONCRETE ITEMS										
STATION	SIDE	CONCRETE SIDEWALK (6 INCH)	CONCRETE SIDEWALK (8 INCH)	CONCRETE CURB RAMP	CURB AND GUTTER TYPE 2 (SECTION I-B)	CURB AND GUTTER TYPE 2 (SECTION II-B)	GUTTER TYPE 2 (8 FOOT)	MEDIAN COVER MATERIAL (6 INCH PATTERNED CONCRETE)	CONCRETE PAVEMENT (8 INCH)	REMARKS
		SY	SY	SY	LF	LF	LF	SF	SY	
Stampede Dr. to 38th Ave.										
1115+05.78 - 1121+20.00	Lt.	622				592				
	Rt.	664				561				
	Total				1,168			3,085		
38th Ave. to 35th Ave.										
1121+20.00 - 1138+80	Lt.	1,809		68		1,620				
	Rt.	1,730		18		1,683				
	Total				3,323			7,315		
Road Approaches										
1121+19.54	Lt.	20		82		134	45		22	38th Avenue
1124+67.77	Rt.		34						27	
1126+54.14	Rt.		34							
1128+25.05	Rt.		34						27	
1129+87.09	Rt.		22						26	
1131+60.93	Rt.		35						27	
1135+82.63	Lt.			38		97	29		44	Murphy Oil Access
TOTAL		4,845	159	206	4,491	4,687	74	10,400	174	



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Print Date: 5/2/2025

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Date	Comments	Initials

As Constructed	37TH STREET WIDENING PHASE 2B TABULATIONS			Project No.
	No Revisions:			37TH STREET 2B
Revised:	Designer: T. Tuttle	Structure		Drawing Number TAB-003
Void:	Detailer: G. Garramone	Numbers		Sheet Number 18
	Sheet Subset: TABS	Subset Sheets: 3 of 4		

FOR CONSTRUCTION 5/1/2025

Plot Date: 5/2/2025 6:36 AM Plotted By: Sarah Hemler
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TABULATION OF STRUCTURE QUANTITIES															
NOTE NO.	STATION AND OFFSET	*STRUCTURE EXCAVATION	**UNCLASSIFIED EXCAVATION	*STRUCTURE BACKFILL (SQUEEGEE SAND)	STRUCTURE BACKFILL (NATIVE MATERIAL)	**EMBANKMENT (NATIVE MATERIAL)	REINFORCED CONCRETE PIPE (CIP)		INLET TYPE R L 10 (5 FOOT)	INLET TYPE R L 10 (10 FOOT)	INLET TYPE D (5 FOOT)	CONCRETE SIDEWALK CULVERT	INLET (FILTER SYSTEM)	MANHOLE SLAB BASE (10 FOOT)	REMARKS
		CY	CY	CY	CY	CY	LF		EACH	EACH	EACH	EACH	EACH	EACH	
								18"	24"						
IN-3	1117+06.17, 36.00' Lt.									1			1		
Pipe 5		41.43	36.58	14.21	20.31	24.34	67								
Pipe 6		7.10	3.75	1.91	2.73	3.34	11								
IN-4	1117+06.59, 36.00' Rt.								1				1		
CSC	60+41.55											1			
IN-2	59+97.09										1				Offsite Storm Sewer
Pipe 28		55.34	47.50	19.20	27.44	45.98	91								Offsite Storm Sewer
MH-24	59+43.61													1	Offsite Storm Sewer, 4-Foot Diameter
IN-2	59+20.31									1			1		Offsite Storm Sewer
Pipe 26		67.47	58.13	23.55	33.65	30.32	111								Offsite Storm Sewer
IN-1	58+33.05									1					Offsite Storm Sewer
Pipe 25		143.44	17.84	46.93	64.93	117.14		177							Offsite Storm Sewer
MH 23	56+61.24													1	Offsite Storm Sewer, 4-Foot Diameter
Pipe 24		320.24	73.90	105.05	141.83	294.25		325							Offsite Storm Sewer
TOTALS		635	238	211	291	515	280	502	1	3	1	1	3	2	


*For Information Only
**Carried to Summary of Earthwork



Print Date: 5/2/2025


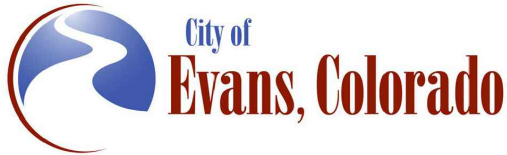
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	Sheet Revisions		
	Date	Comments	Initials



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Revised:

Void:

37TH STREET WIDENING PHASE 2B
TABULATIONS

Designer: T. Tuttle

Detailer: S. Hemler

Sheet Subset: TABS

Structure Numbers


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Project No.

37TH STREET 2B


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Sheet Number 19




SLEEVE FOR DESIGN POST OR DELINEATOR POST IN CONCRETE DETAIL

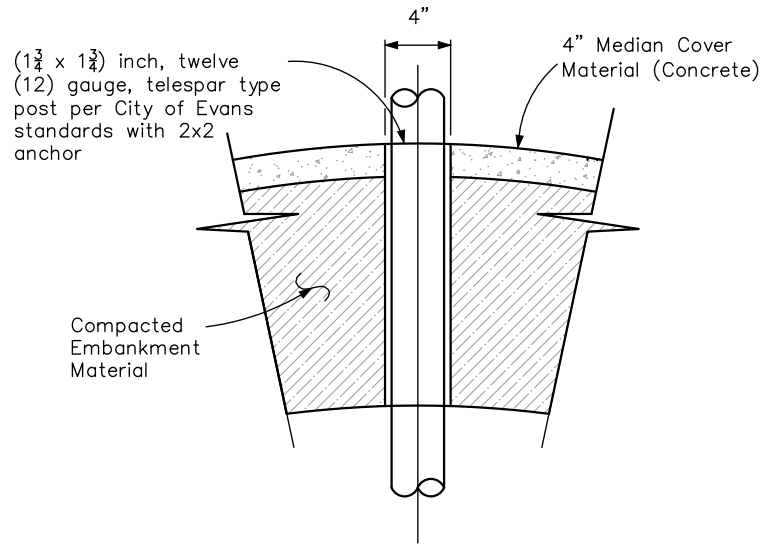
Cost of sleeve will not be paid for separately, but will be included in the cost of Median Cover Material (Concrete). Location of posts are as shown on tabulation of signs and delineator tabulation.

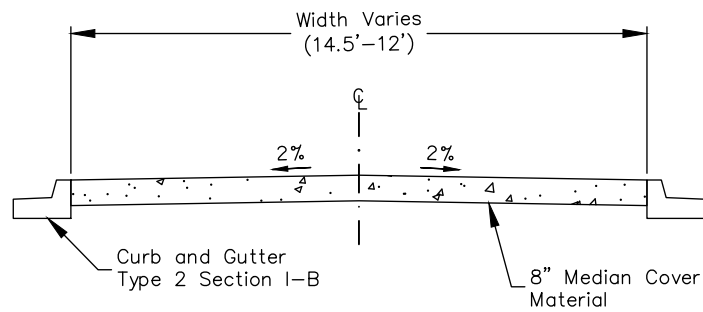

Section C-C

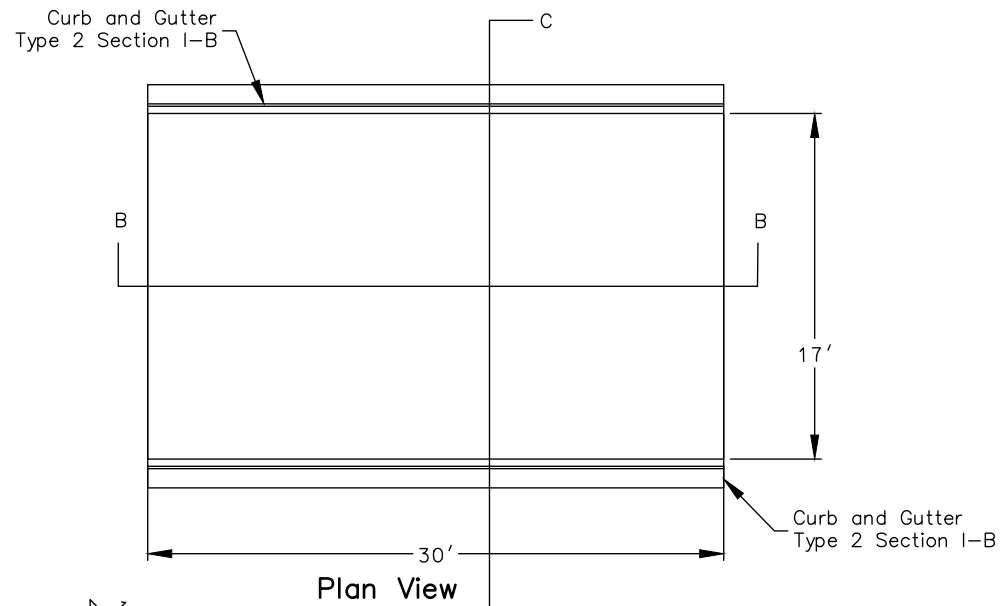


Plan View

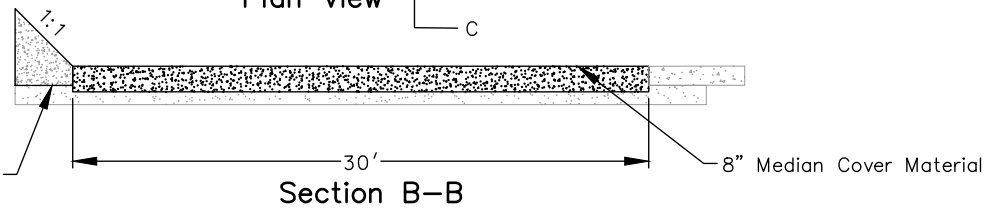

Section B-B


PAVED MAINTENANCE PULLOUT SPACE DETAIL

Sta. 1116+86.00 to Sta. 1117+16.00
Sta. 1134+38.00 to Sta. 1134+68.00

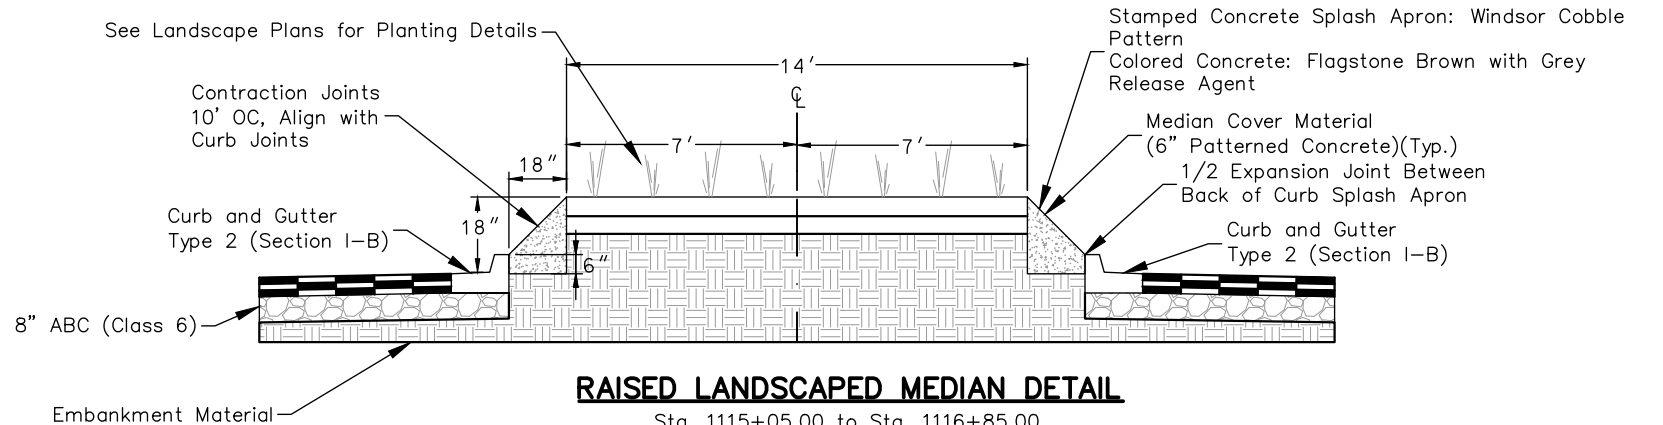


RAISED LANDSCAPED MEDIAN DETAIL

Sta. 1115+05.00 to Sta. 1116+85.00
Sta. 1121+69.00 to Sta. 1126+47.00
Sta. 1127+85.00 to Sta. 1134+38.00

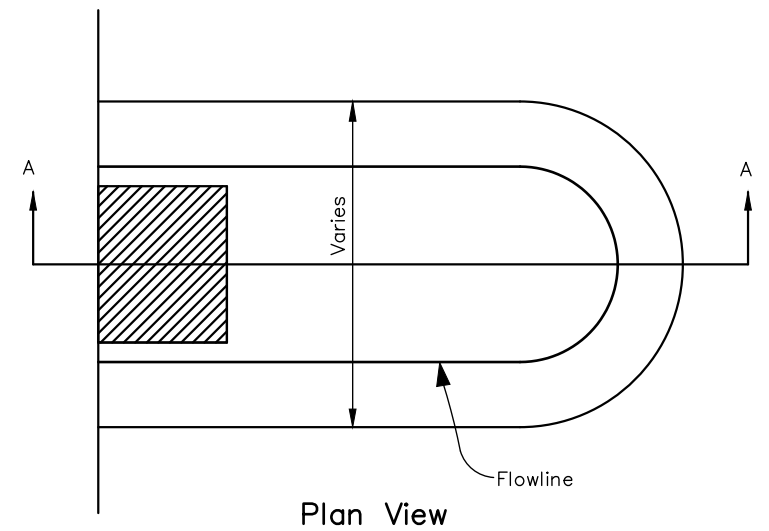

Plan View

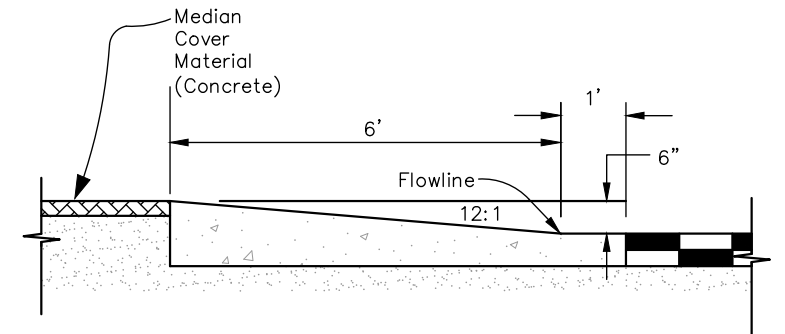


Section A-A MEDIAN ISLAND NOSE DETAIL

Sta. 1120+78.00
Sta. 1121+56.00
Sta. 1126+76.00
Sta. 1138+46.00

Median nose detail will be included in the cost of curb and gutter.

Print Date: 5/2/2025	
File Name: DT P2B-001 DETAILS.DWG	
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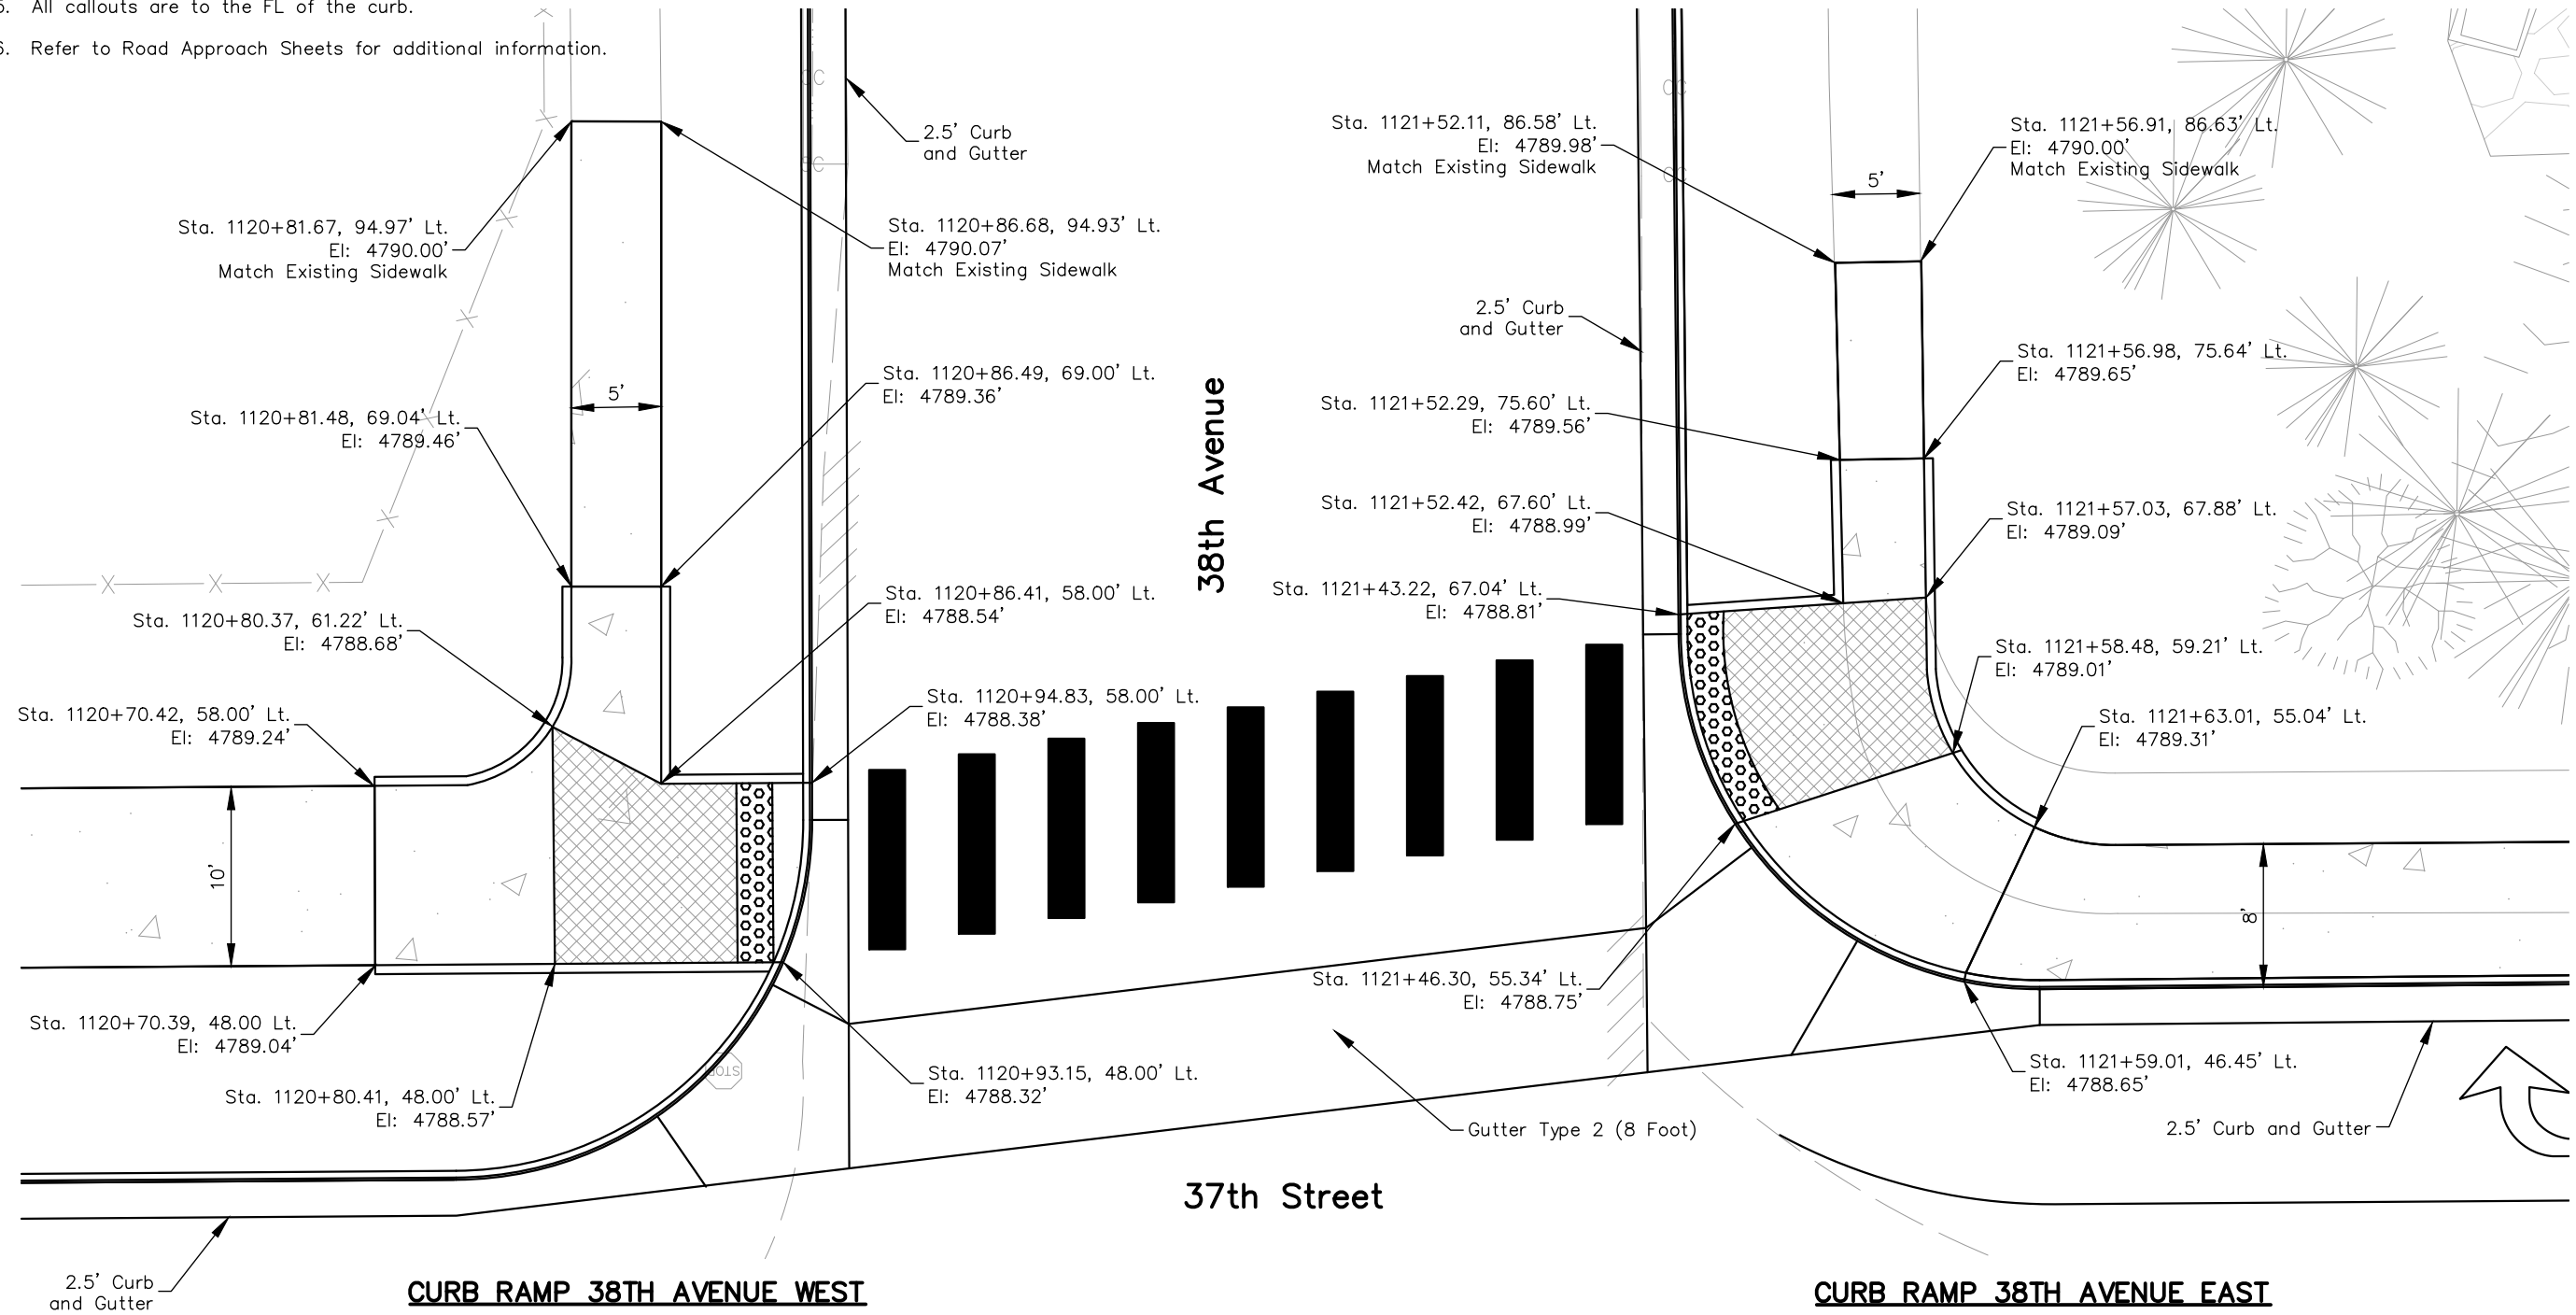
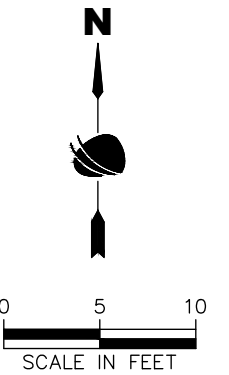
Sheet Revisions		
Date	Comments	Initials

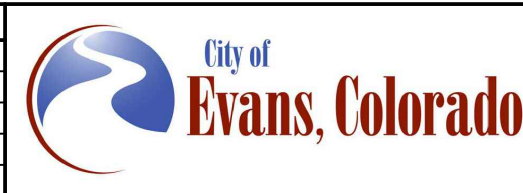

As Constructed		37TH STREET WIDENING PHASE 2B DETAILS		Project No.
No Revisions:				37TH STREET 2B
Revised:		Designer: T. Tuttle	Structure Numbers	Drawing Number DT-001
Void:		Detailer: S. Hemler		Sheet Number 20
		Sheet Subset: DETAILS	Subset Sheets: 1 of 11	

 Turning Space

1. If any field adjustments for ADA Ramps are required, ramp design must adhere to the latest CDOT M-608-1 standard.
2. Detectable warnings shall be cast iron.
3. It is estimated that 5 DWS panels (2' x 2') will be needed for the west ramp.
4. It is estimated that 6 DWS panels (2' x 2') will be needed for the east ramp.
5. All callouts are to the FL of the curb.
6. Refer to Road Approach Sheets for additional information.




Know what's **below**.
Call **811** before you dig.

FOR CONSTRUCTION 5/1/2025


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Plot Date: 5/2/2025 6:37 AM Plotted By: Sarah Hemler

LEGEND

 Turning Space

- NOTES:
1. If any field adjustments for ADA Ramps are required, ramp design must adhere to the latest CDOT M-608-1 standard.
 2. Detectable warnings shall be cast iron.
 3. It is estimated that 12 DWS panels (2' x 2') will be needed for the north ramp.
 4. It is estimated that 3 DWS panels (2' x 2') will be needed for the south ramp.
 5. All callouts are to the FL of the curb.

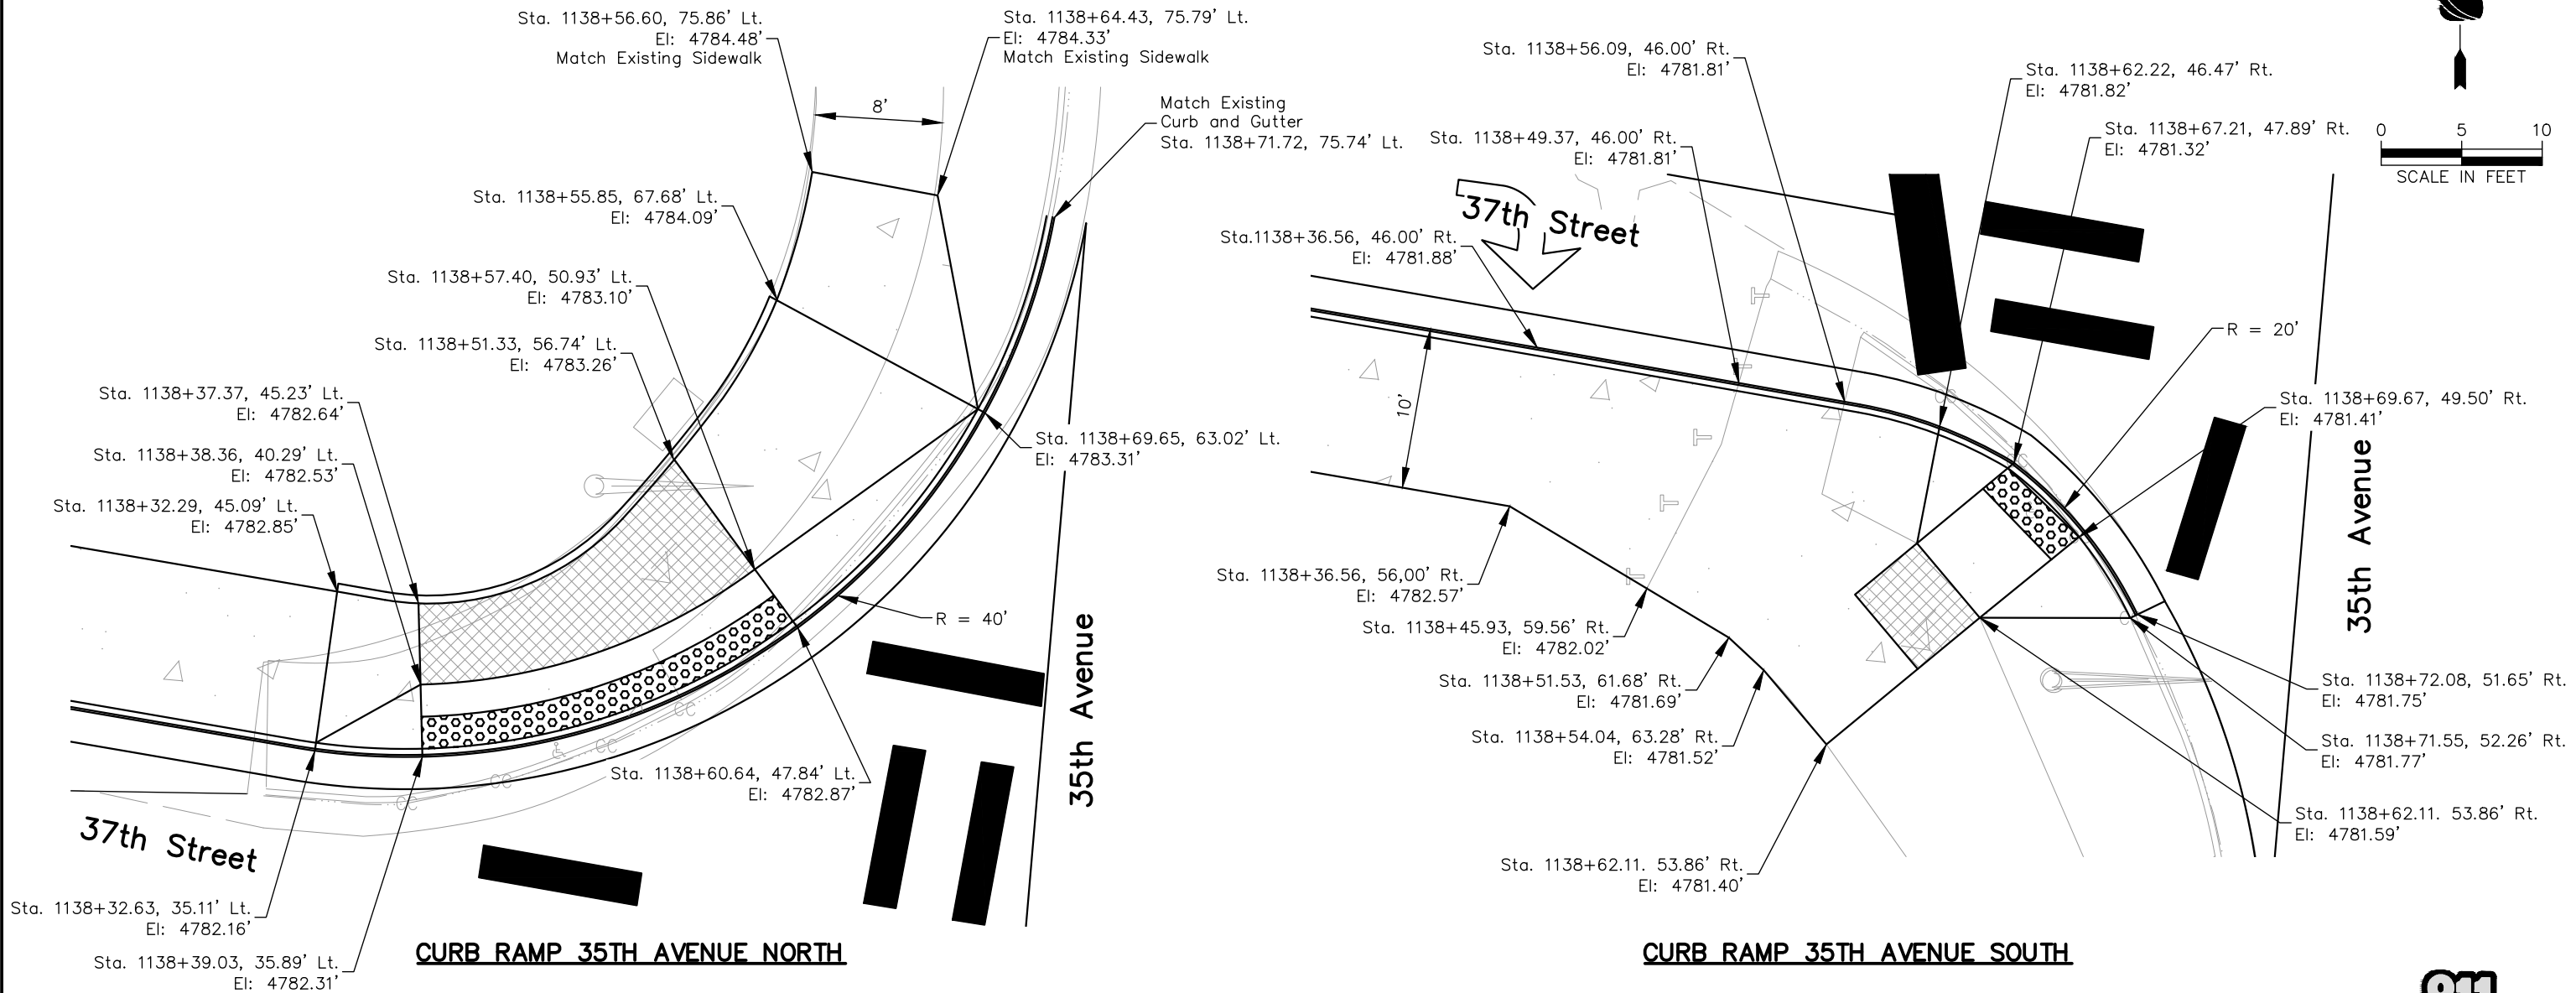


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Know what's below.
Call before you dig.


Print Date: 5/2/2025		<div><div></div><div></div><div></div><div></div><div></div></div>	Sheet Revisions			<div><div><div></div><div></div></div><div>City of Evans, Colorado</div><div><div><div></div><div></div><div></div></div><div>FREEDOM Parkway</div></div></div>	As Constructed		37TH STREET WIDENING PHASE 2B DETAILS			Project No.		
File Name: DT P2B-001 DETAILS.DWG			Date	Comments	Initials		No Revisions:		Designer: T. Tuttle Detailer: S. Hemler			37TH STREET 2B		
Horiz. Scale: As Noted Vert. Scale: N/A							Revised:					Structure Numbers		
<div><div><div></div><div></div></div><div>RockSol Consulting Group, Inc.</div></div> <div>12076 Grant Street Thornton, CO 80241 Ph: (303) 962-9300 Fax: (303) 962-9350</div>							Void:		Sheet Subset: DETAILS		Subset Sheets: 3 of 11		Drawing Number DT-003	
													Sheet Number 22	



Granular Bedding

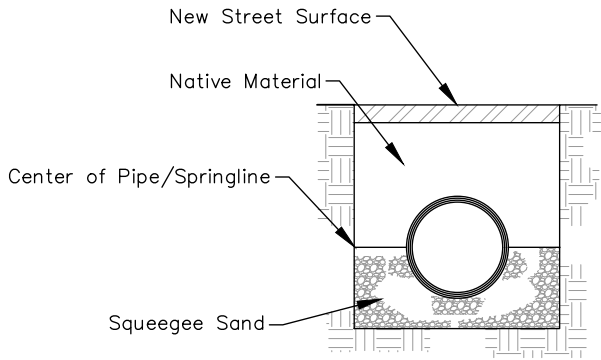
- Notes:
1. Pipe must be RCP only.
 2. Native material as backfill up to grade compacted to 95% \pm 2%.
 3. Squeegee from 6" below the pipe and up to the springline of the pipe.
 4. Squeegee sand is defined as material in which 100% passes through a $\frac{3}{8}$ " sieve and only 0% to 5% passes through a #200 sieve.
 5. All trenching shall meet OSHA requirements, including trench boxes and/or shoring when appropriate.
 6. An over-excavated trench shall be refilled and thoroughly compacted under the direction of the public works department.
 7. Under no circumstances will pipe be laid in a proposed fill area prior to it being completely filled. The fill will be placed first to proposed grade and compacted as required. A trench then will be excavated and the pipe installed per City of Evans Standards.

STORM SEWER BACKFILL DETAIL
NTS

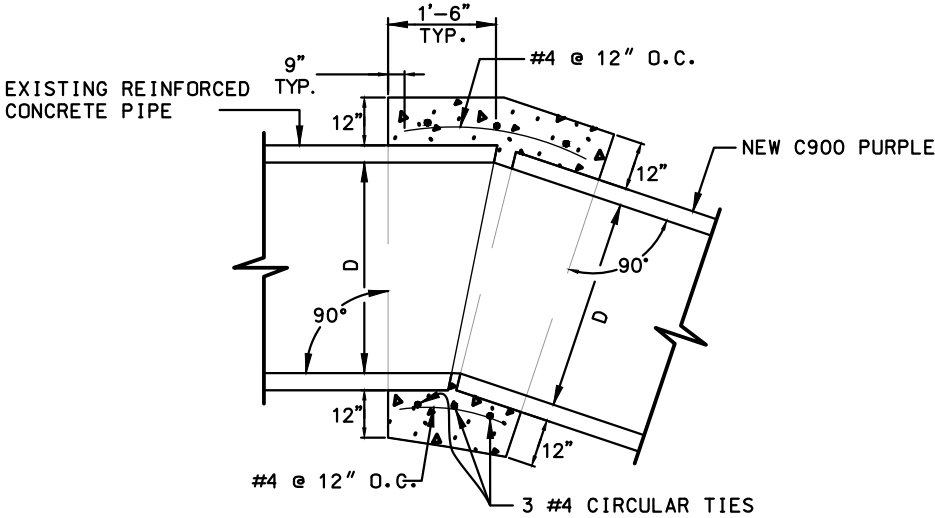

CONCRETE COLLAR
N.T.S.

- Notes:
1. Collar shall be formed with plywood (Remove prior to backfill).
 2. Contractor shall form to prevent concrete from entering the pipes.
 3. Concrete shall be vibrated during placement.
 4. Pipe shall be cleaned of loose dirt etc.
 5. Rebar 3" clear of formed surface
 6. A Concrete Collar is required where the maximum permissible pull at the joint, as specified by the Manufacturer, is exceeded.
 7. Omit reinforcing on all pipes less than 24" in diameter with minimum 2' cover and substitute with wire mesh.
 8. Concrete shall be CDOT Class B.
 9. Concrete Pipe Collars will not be paid for separately but shall be included in the work.
 10. The interior surface of the Concrete Collar shall be finished smooth to match the adjoining pipe surfaces. If the proposed pipe deflection creates a gap which prohibits a smooth interior finish, a mitered cut to each pipe shall be required.

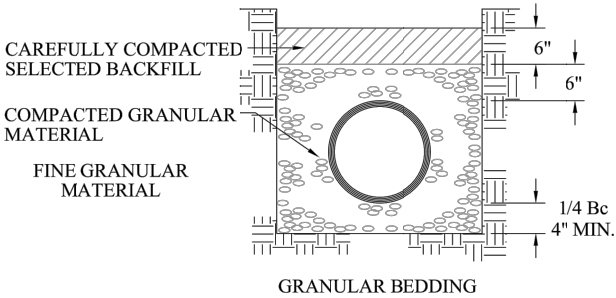

- NOTES:
1. MINIMUM DENSITY FOR CAREFULLY COMPACTED SELECT BACKFILL SHALL BE 95% OF MAXIMUM OR AS SPECIFIED FOR THE TRENCH BACKFILL - WHICHEVER IS GREATER
 2. COMPACT GRANULAR MATERIAL BY SLICING WITH A SHOVEL AROUND PIPE. WHEN BEDDING IS 6" OVER PIPE, COMPACT WITH VIBRATING COMPACTOR



NONPOTABLE IRRIGATION LINE
BEDDING DETAIL


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Print Date: 5/2/2025
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Horiz. Scale: NTS Vert. Scale: NTS

RockSol
Consulting Group, Inc.

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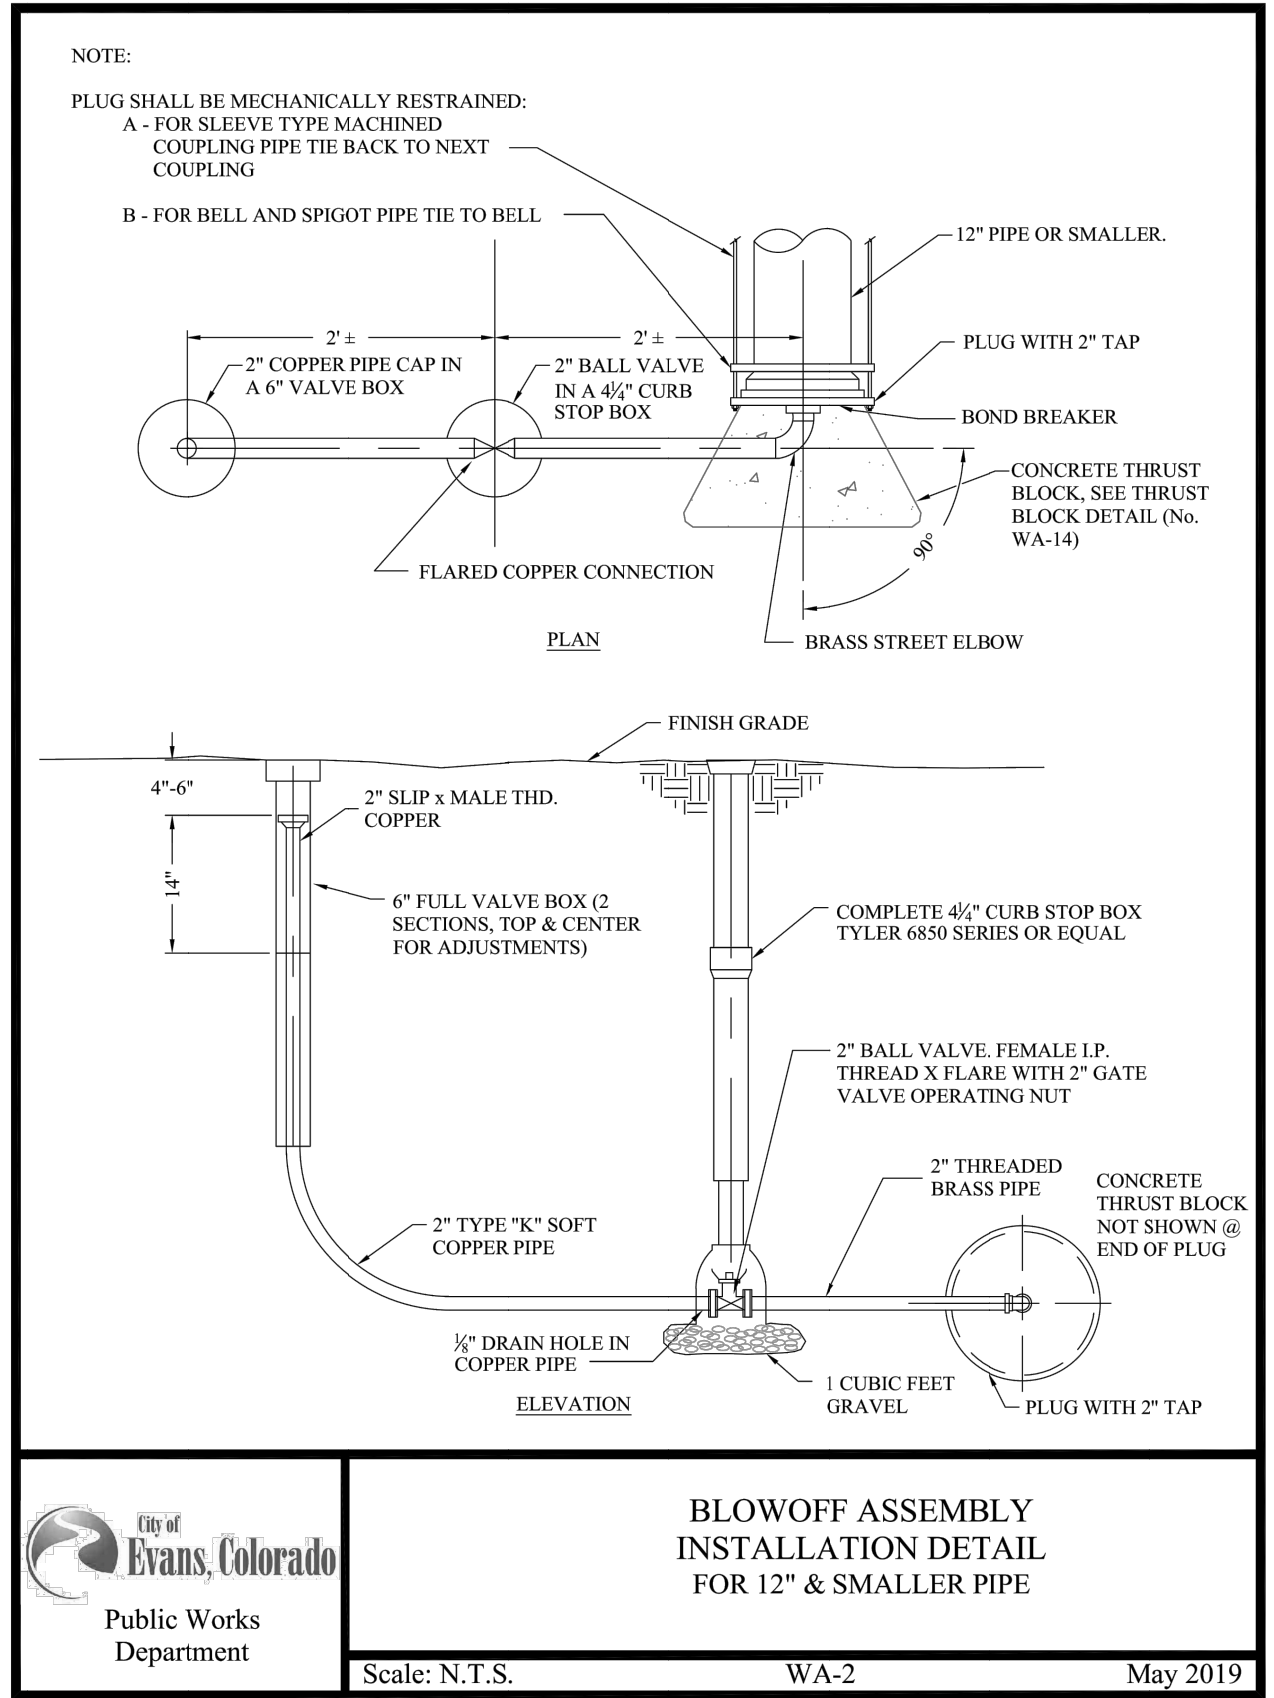
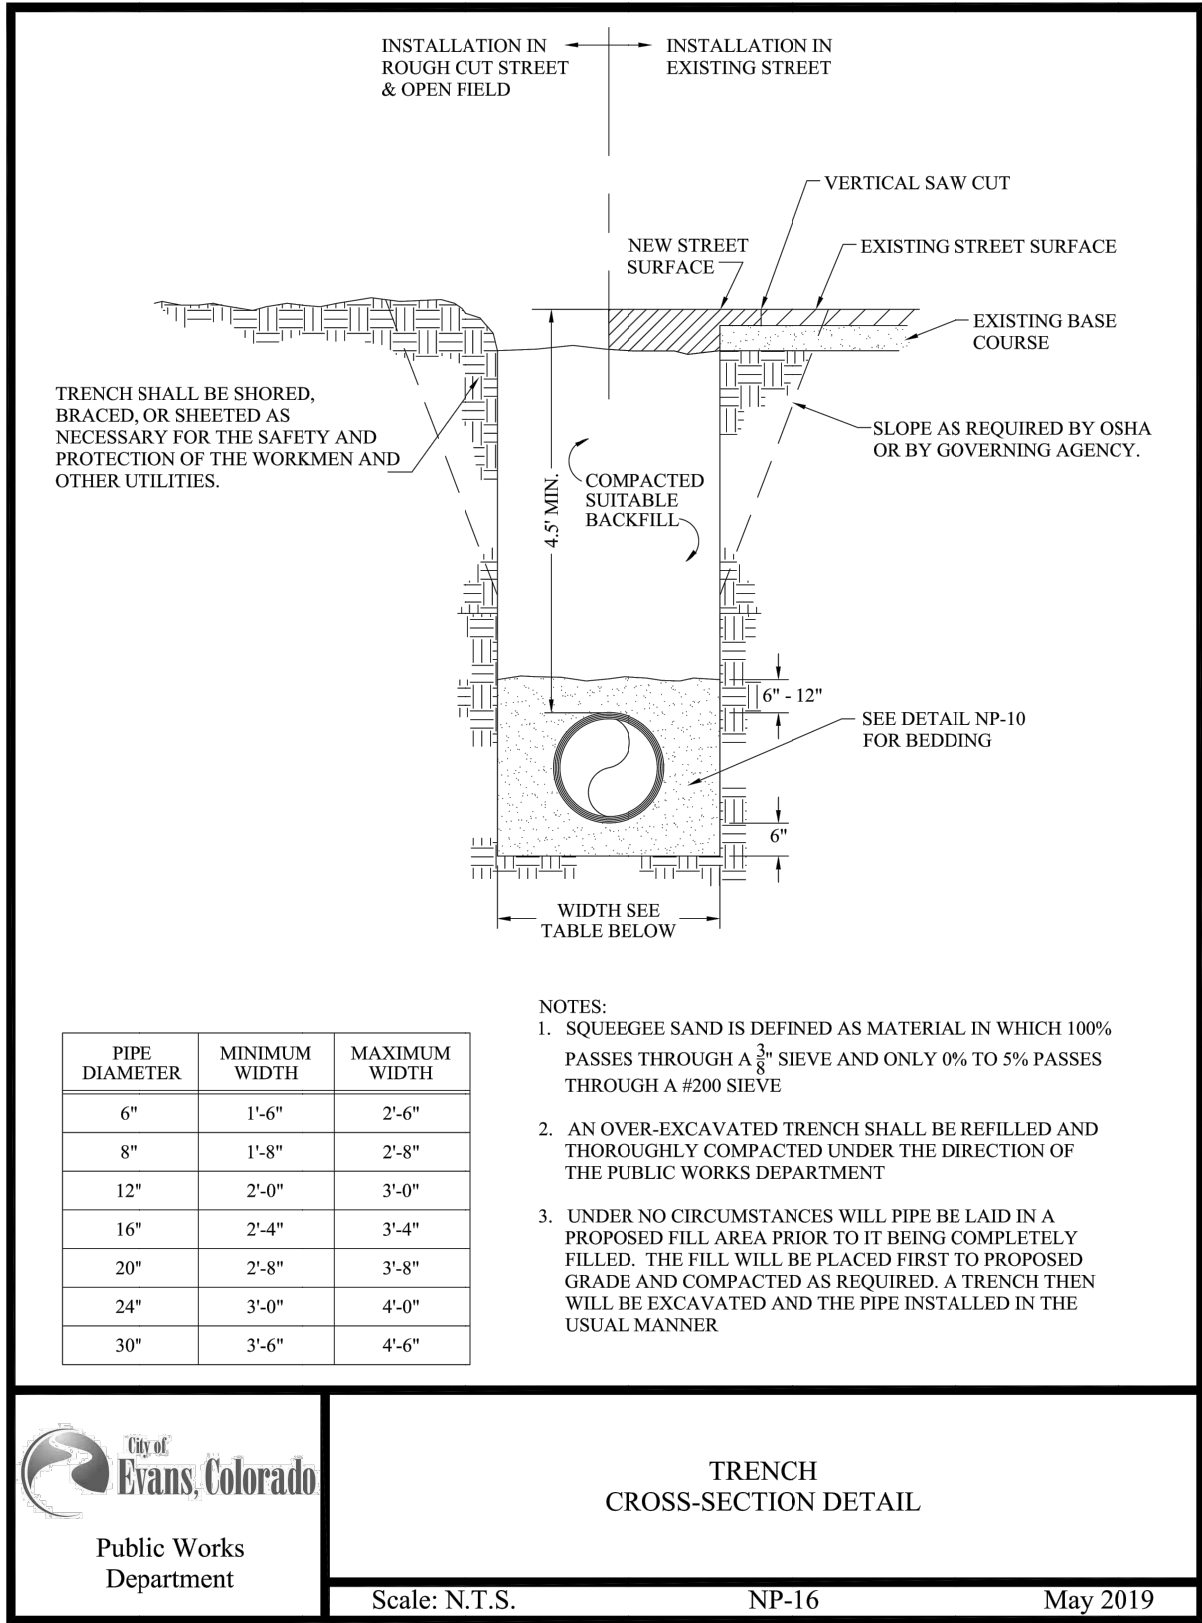


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	No Revisions:	Designer: T. Tuttle	Structure Numbers	37TH STREET 2B
Revised:	Detailer: S. Hemler			Drawing Number DT-004
Void:	Sheet Subset: DETAILS	Subset Sheets: 4 of 11		Sheet Number 23

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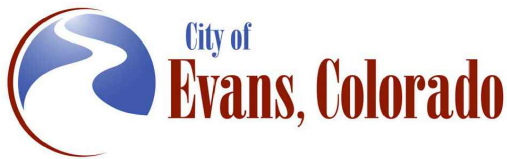
FOR CONSTRUCTION 5/1/2025
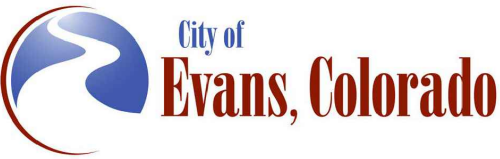
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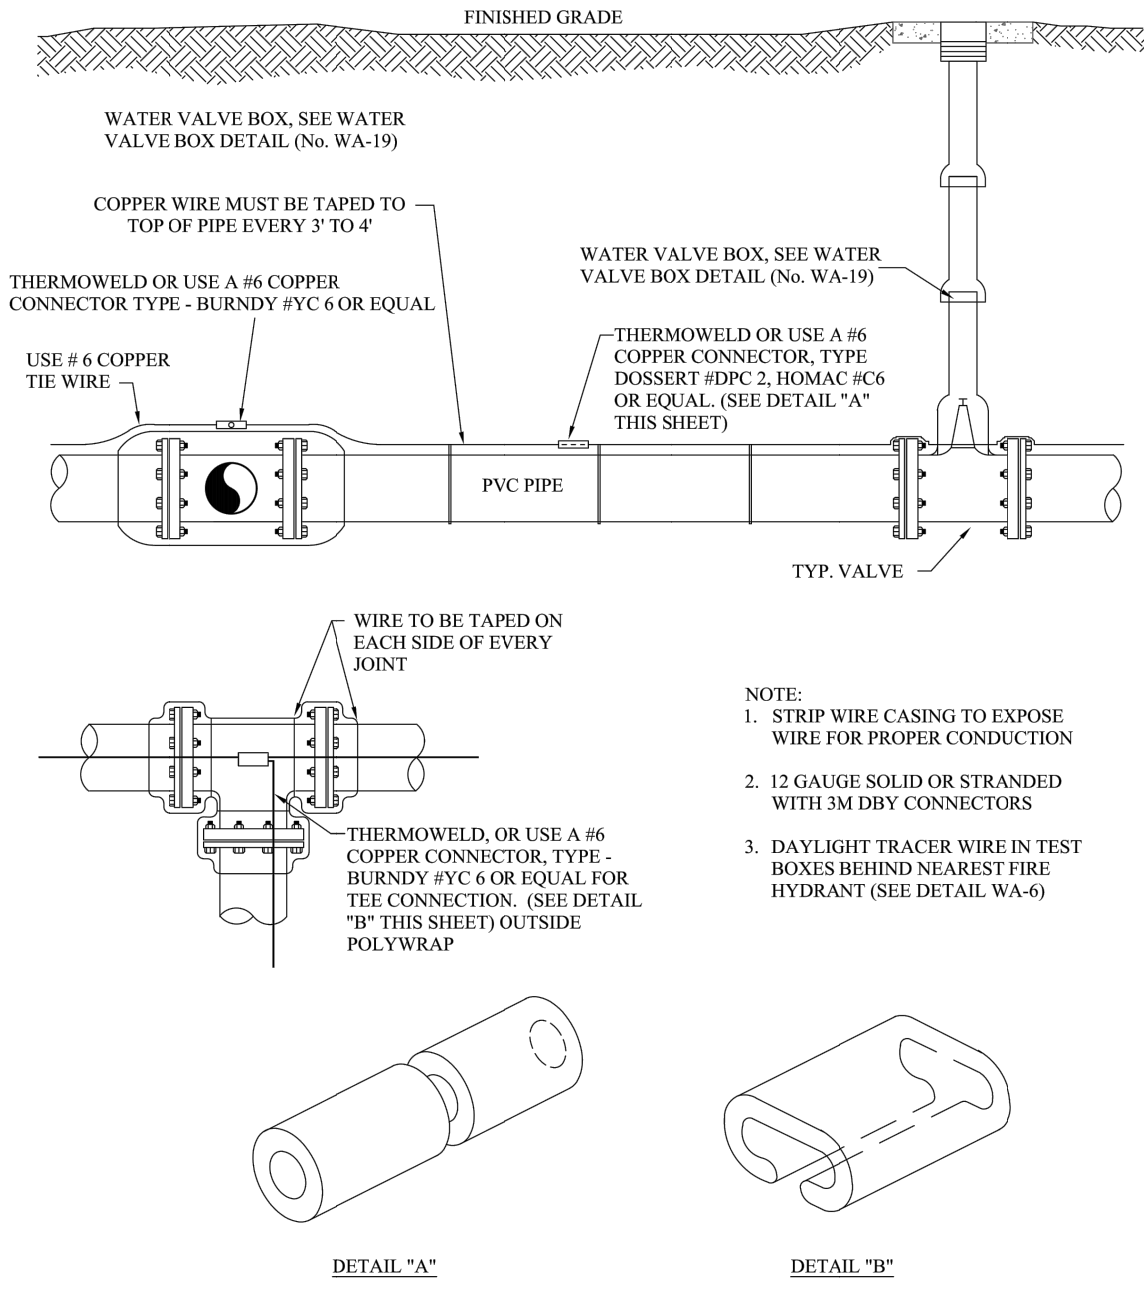



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Sheet Revisions		
Date	Comments	Initials



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	No Revisions:		37TH STREET 2B
Revised:	Designer: T. Tuttle	Structure Numbers	Drawing Number DT-005
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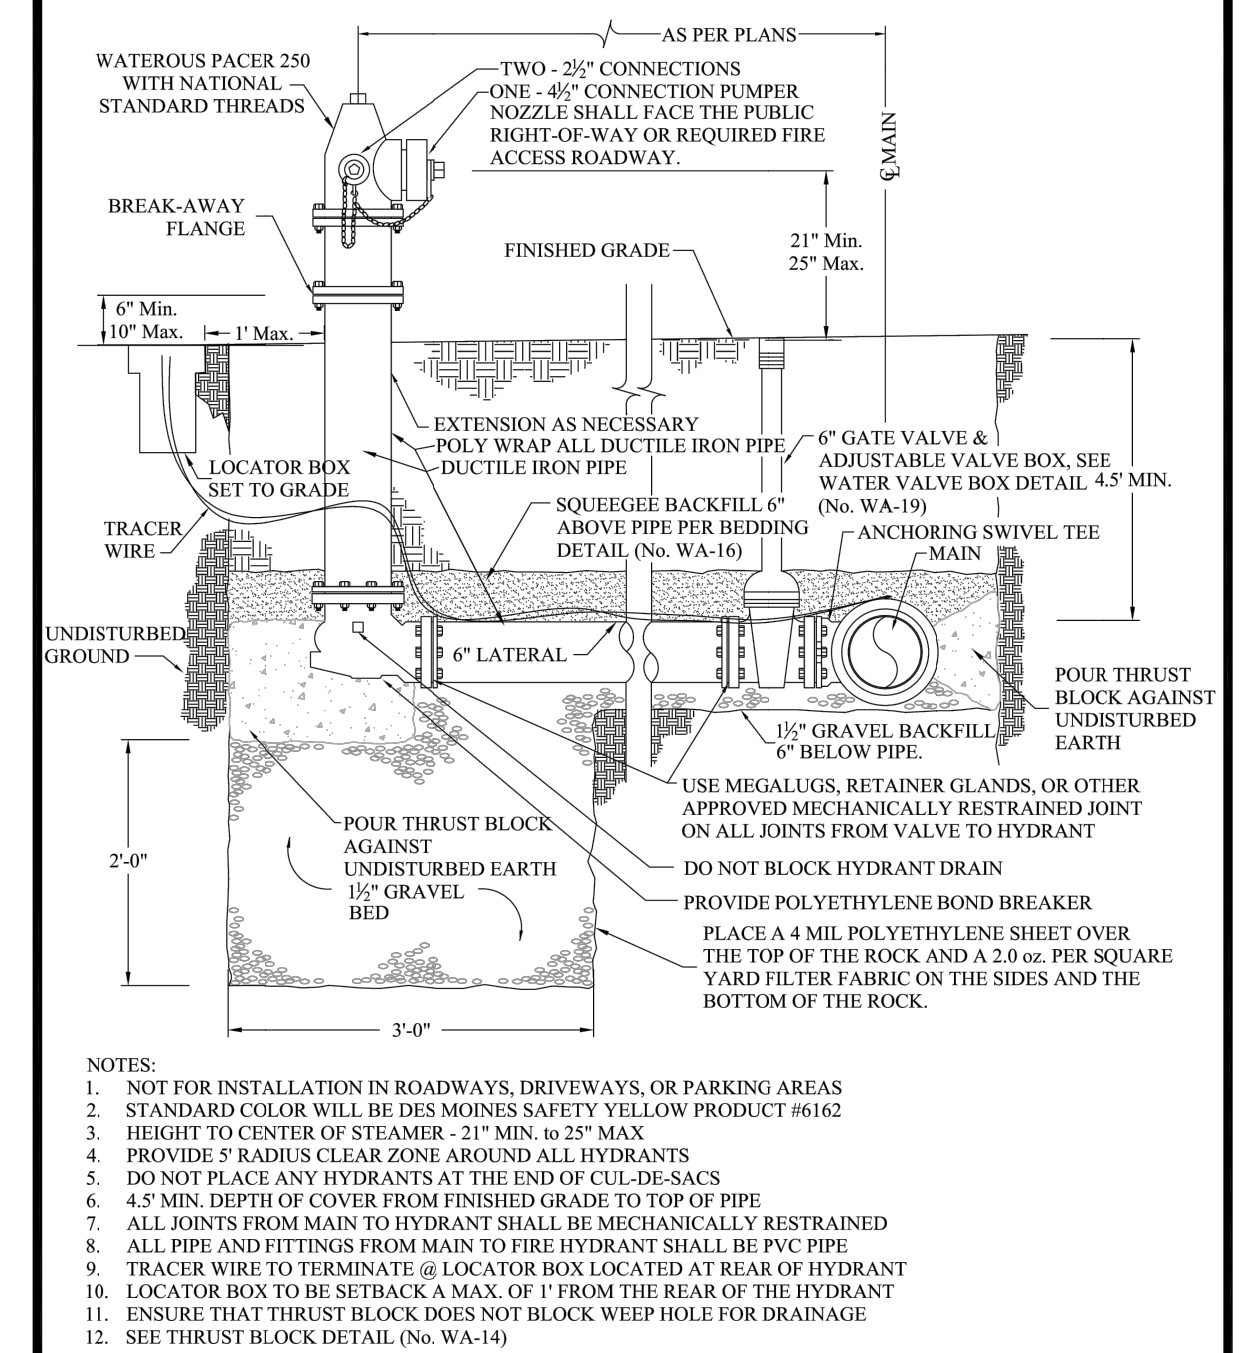





Public Works
Department

COPPER TRACER
WIRE DETAIL
ON PVC PIPE

Scale: N.T.S. WA-5 May 2019





Public Works
Department


FIRE HYDRANT DETAIL
WATEROUS PACER 250
WITH NATIONAL STANDARD THREADS

Scale: N.T.S. WA-6 May 2019

Plot Date: 5/2/2025 6:37 AM Plotted By: Sarah Hemler
C:\Q-PROJECTS\37TH STREET WIDENING\37TH ST AND 47TH AVE PLAN\2025\COMPUTER DESIGN FILES\DT P2B-001 DETAILS.DWG

Print Date: 5/2/2025		<div><div></div><div></div><div></div><div></div></div>	Sheet Revisions					As Constructed		37TH STREET WIDENING PHASE 2B DETAILS			Project No.		
File Name: DT P2B-001 DETAILS.DWG			Date	Comments	Initials			No Revisions:		Designer: T. Tuttle Detailer: S. Hemler Structure Numbers			37TH STREET 2B		
Horiz. Scale: NTS Vert. Scale: NTS								Revised:					Drawing Number DT-006		
 <p>12076 Grant Street Thornton, CO 80241 Ph: (303) 962-9300 Fax: (303) 962-9350</p>								Void:		Sheet Subset: DETAILS		Subset Sheets: 6 of 11		Sheet Number 25	

FOR CONSTRUCTION 5/1/2025

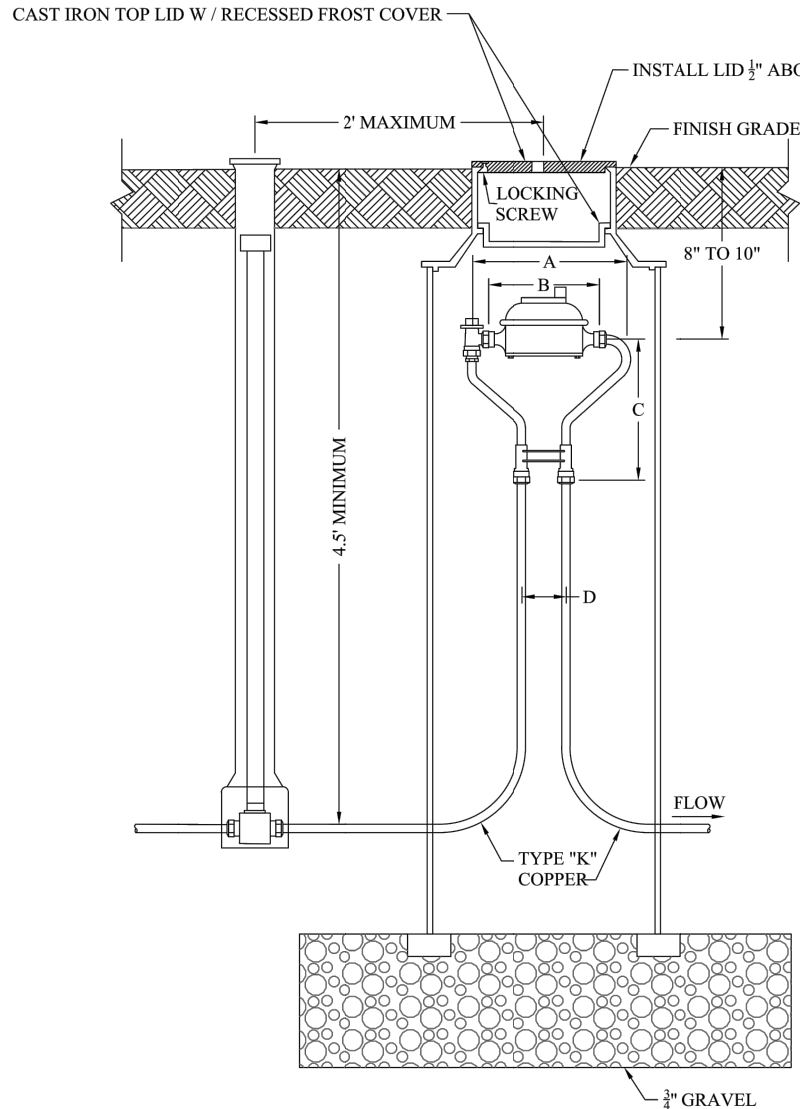

METER SIZE	A	B	C	D
3/4-INCH	14 1/2-INCH	7 1/2-INCH	8 1/2-INCH	5-INCH
1-INCH	17 1/4-INCH	10 3/4-INCH	11 1/4-INCH	6-INCH

NOTES:

1. NOT FOR INSTALLATION IN ROADWAYS, DRIVEWAYS, OR PARKING AREAS
2. IF SURFACE IS NOT TO FINAL GRADE AT TIME OF INSTALLATION METER LID SHALL BE 2" ABOVE GRADE
3. METER LID SHALL BE CAST IRON. IT SHALL HAVE A 1 7/8 INCH HOLE FOR ANTENNA ATTACHMENT AND LOCK WITH A PENTAGON BOLT WITH WORMLOCK. METER FROST PLATE SHALL BE RECESSED DISH TYPE
4. METER YOKE SHALL BE LOCATED NOT LOWER THAN 12" BELOW THE TOP LID. IN THE EVENT THE METER PIT IS ADJUSTED TO FINAL GRADE, OWNER SHALL ENSURE THAT THE YOKE BE RAISED/LOWER AS REQUIRED
5. METER TO BE LOCATED A MINIMUM OF 2' FROM THE CURB STOP AND WITHIN THE UTILITY EASEMENT ADJACENT TO FRONT SIDEWALK, UNLESS OTHERWISE APPROVED BY THE DIRECTOR OF PUBLIC WORKS
6. METER PIT SHALL BE PLACED ON FREE-DRAINING GRAVEL BASE, CONCRETE SHALL NOT BE PERMITTED
7. METER PIT SHALL BE 20" INSIDE DIAMETER AND 48" DEEP DUROPIPE BITUMINIZED FIBER BY METRO-STATES PLASTICS OR APPROVED EQUAL
8. SPRINKLER SYSTEM CONNECTIONS SHALL BE LOCATED A MINIMUM OF 5' DOWNSTREAM FROM THE METER PIT. UNDER NO CIRCUMSTANCES ARE SPRINKLER CONNECTIONS PERMITTED IN THE METER PIT
9. NO STRUCTURES ARE TO BE LOCATED WITHIN 4' OF METER PIT. LANDSCAPING IS PERMITTED, HOWEVER ACCESS TO THE METER PIT MUST BE MAINTAINED
10. IF PRESSURE REDUCING VALVE IS REQUIRED BY THE PLUMBING CODE, IT SHALL BE INSTALLED INSIDE THE BUILDING IMMEDIATELY FOLLOWING THE MAIN SHUT OFF VALVE
11. SERVICE BOX FOR CURB STOP SHALL BE OF THE MUELLER TYPE WITH A COMBINATION LID AND PENTAGON PLUG (MODEL #H-10334) AND AN EXTENSION TYPE CURB BOX WITH ARCH PATTERN BASE AND SHUT-OFF ROD
12. CURB STOPS SHALL BE STRAIGHT AND CLEAN OF ANY DEBRIS




Public Works
Department

METER SETTING DETAIL
FOR 3/4" AND 1" METERS


Scale: N.T.S.

WA-7


May 2019

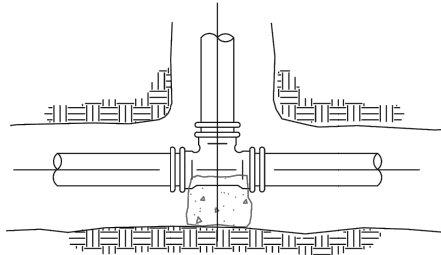

TEE

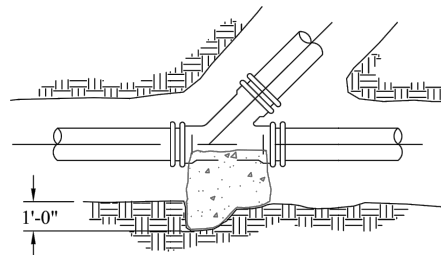


Y

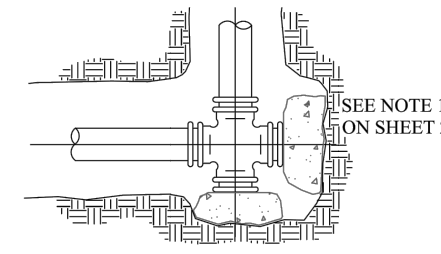


CROSS WITH

DEAD END BRANCHES


PLUG OR LINE CAP
SEE NOTE 1 ON
SHEET 2

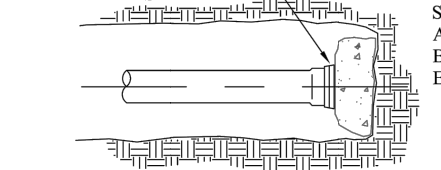


DEAD END

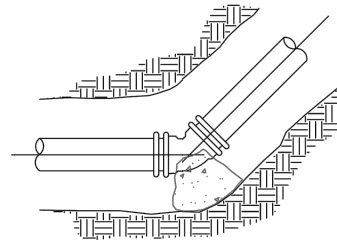

BEND-HORIZONTAL OR
BOTTOM OF VERTICAL

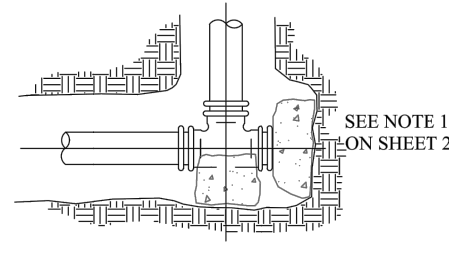


TEE W/DEAD END ON RUN

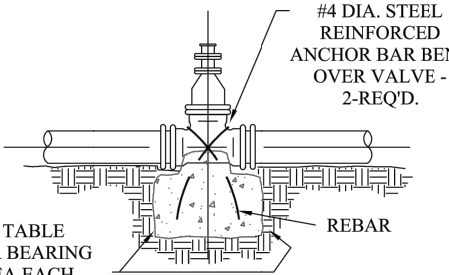

SEE TABLE
FOR BEARING
AREA EACH
SIDE - SHEET 3

VALVE
(GATE OR BUTTERFLY)

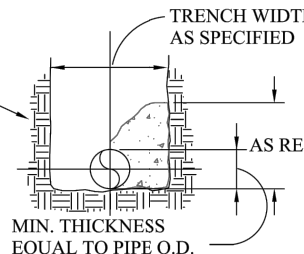

SECTION (TYPICAL)



Public Works
Department

THRUST BLOCK DETAIL
SHEET 1 OF 3

Scale: N.T.S.

WA-14A

May 2019

Print Date: 5/2/2025

File Name: DT P2B-001 DETAILS.DWG

Horiz. Scale: NTS


Vert. Scale: NTS



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Sheet Revisions

Date	Comments	Initials

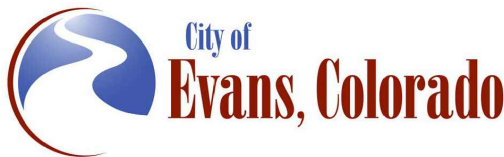

As Constructed

No Revisions:

Revised:

Void:

37TH STREET WIDENING PHASE 2B
DETAILS

Designer: T. Tuttle

Detailer: S. Hemler

Sheet Subset: DETAILS

Structure

Numbers

Subset Sheets: 7 of 11

Project No.

37TH STREET 2B

Drawing Number DT-007

Sheet Number 26

FOR CONSTRUCTION 5/1/2025

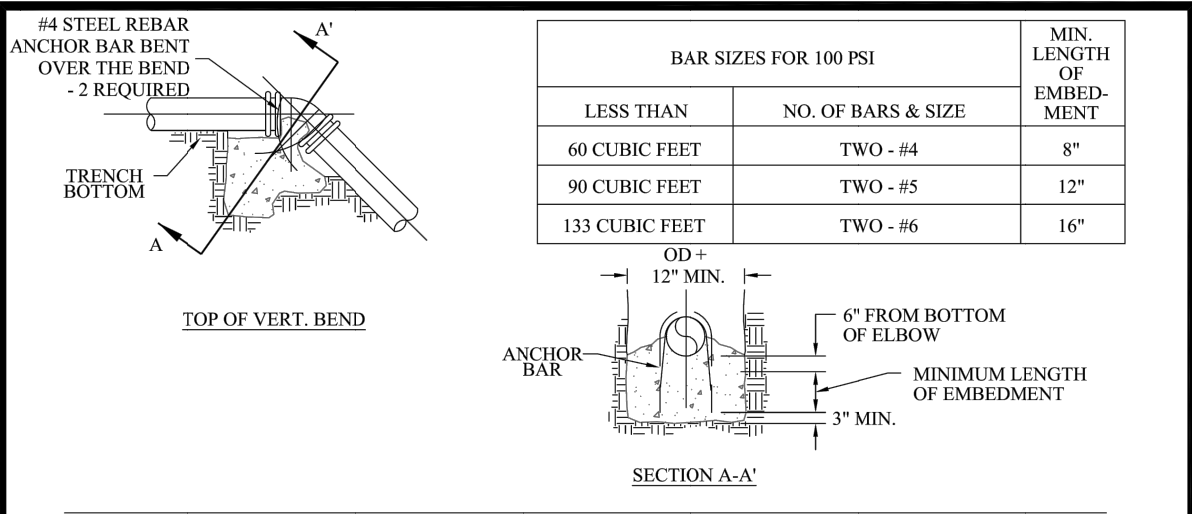


TABLE OF VOLUMES OF CONCRETE (IN CU. FT.)

REQ'D FOR VERT. BEND ANCHOR BLOCKS FOR 100 P.S.I. PRESSURE
ADJUST VOLUMES BY MULTIPLYING TABULATED VALUES BY A CORRECTION
FACTOR "F".

$$F = \frac{\text{ACTUAL SPECIFIED TEST PRESSURE}}{100}$$

PIPE SIZE (INCHES)	BENDS		
	45°	22 1/2°	11 1/4°
3	3.7	1.9	1.4
4	6.5	3.3	1.7
6	14.6	7.5	3.7
8	26.0	13.2	6.6
10	40.5	20.7	10.3
12	58.5	30.0	14.8
14	79.5	40.7	20.2
15	91.0	46.6	23.2
16	104.0	53.0	26.5
18	SPECIAL DESIGN REQ'D.	67.3	33.4
20		83.0	41.0
21			45.5
22			50.0
24			59.5
30			
36			

NOTES FOR DRAWINGS:


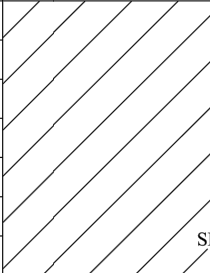

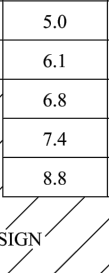
1. AT DEAD ENDS, WRAP FITTINGS WITH TAR PAPER, FELT, OR HEAVY KRAFT PAPER TO PROVIDE BOND BREAK BETWEEN CONCRETE AND FITTINGS
2. ALL THRUST BLOCKING SHALL BE CAST-IN-PLACE CONCRETE HAVING A MINIMUM YIELD STRENGTH OF 3000 P.S.I. NO HAND MIXING OF CONCRETE ALLOWED
3. THRUST BLOCKING SHALL BE CAST AGAINST UNDISTURBED EARTH. FORMS SHALL BE USED AS REQUIRED TO OBTAIN ADEQUATE BEARING AREA AND TO CONFINE THE CONCRETE. THRUST BLOCKING SHALL BEAR ON THE FITTING OR END CAP ONLY AND SHOULD NOT BE ALLOWED TO SPILL OVER THE JOINT OR AGAINST THE PIPE
4. MEGA-LUGS OR OTHER JOINT RESTRAINT MAY BE USED ALONG WITH OR IN PLACE OF CONCRETE THRUST BLOCKS WITH DESIGN SUBMITTED BY PROFESSIONAL ENGINEER AND APPROVED BY PUBLIC WORKS DEPARTMENT
5. PIPE INSTALLED UNDER CONDITIONS DIFFERENT FROM THOSE NORMALLY ENCOUNTERED SHALL REQUIRE THRUST BLOCKS DESIGNED FOR THOSE PARTICULAR CONDITIONS



Public Works
Department

THRUST BLOCK DETAIL
SHEET 2 OF 3

Scale: N.T.S. WA-14B May 2019

TABLE OF BEARING AREAS IN SQ. FT. FOR CONCRETE THRUST BLOCKING FOR 100 P.S.I. INTERNAL STATIC PRESSURE AND 1000 LBS. PER SQ. FT. SOIL BEARING CAPACITY							
PIPE SIZE (INCHES)	BENDS				TEES *	GATE VALVES	DEADENDS AND CROSSES WITH ONE OR TWO BRANCHES PLUGGED
	90°	45°	22 1/2°	11 1/4°			
3	1.0	0.6	0.3	0	0.7	0.5	0.7
4	1.8	1.0	0.5	0	1.3	0.5	1.3
6	4.0	2.2	1.1	0	2.8	0.7	2.8
8	7.1	3.8	2.0	1.0	5.0	2.4	5.0
10	11.1	6.0	3.0	1.5	7.8	4.5	7.8
12	16.0	8.6	4.4	2.2	11.3	7.3	11.3
14	21.7	11.8	6.0	3.0	15.4	11.0	15.4
15	25.0	13.5	7.0	3.5	17.6		17.6
16	28.4	15.3	8.0	4.0	20.0		20.0
18			10.0	5.0	25.4		25.4
20			12.2	6.1	31.4		31.4
21				6.8	34.6		34.6
22				7.4	38.0		38.0
24				8.8	45.0		45.0
30				SPECIAL DESIGN			
36							102.0

* PIPE SIZES ARE THE SIZE OF THE BRANCH SIZE

BEARING AREAS FOR ANY PRESSURE AND SOIL BEARING CAPACITY MAY BE OBTAINED BY MULTIPLYING THE TABULATED VALUES BY A CORRECTION FACTOR "F"

$$F = \frac{\text{ACTUAL SPECIFIED TEST PRESSURE IN HUNDREDS OF LBS./SQ. IN.}}{\text{ACTUAL SOIL BEARING CAPACITY IN THOUSANDS OF LBS.}}$$

EXAMPLE:
- TO FIND BEARING AREA FOR 8"-90° BEND WITH A STATIC INTERNAL PRESSURE OF 150 P.S.I. AND WITH A SOIL BEARING CAPACITY OF 3000 LBS. PER SQ. FT.
- $F = \frac{1.5}{3} = 0.5$
- TABULATED VALUE = 7.1 SQ. FT.
- $0.5 * 7.1 = 3.56$ OR ~ 4 SQ. FT. OR 2 FT. LONG BY 2 FT. HIGH

IN THE ABSENCE OF SOIL BEARING CAPACITY INFORMATION, USE ABOVE TABLE



Public Works
Department

THRUST BLOCK DETAIL
SHEET 3 OF 3

Scale: N.T.S. WA-14C May 2019

Plot Date: 5/1/2025 6:37 AM Plotted By: Sarah Hemler
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Print Date: 5/2/2025


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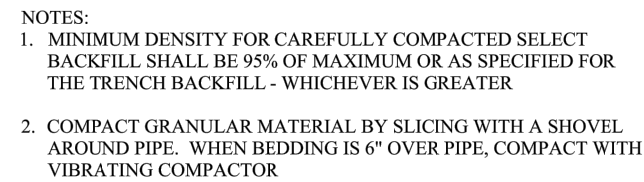


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As Constructed	37TH STREET WIDENING PHASE 2B DETAILS			Project No.
	No Revisions:			37TH STREET 2B
Revised:	Designer: T. Tuttle	Structure		Drawing Number DT-008
Void:	Detailer: S. Hemler	Numbers		Sheet Number 27
	Sheet Subset: DETAILS	Subset Sheets: 8 of 11		



May 2019

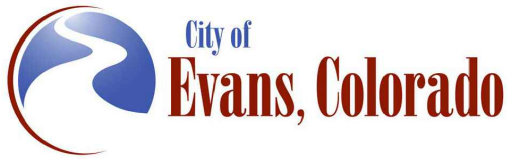

	CAST IRON					DUCTILE IRON					PVC C-900	
PIPE SIZE	3/4"	1"	1-1/2"	2"	3"& 4"	3/4"	1"	1-1/2"	2"	3" & 4"	< 2"	> 2"
3"	S	NO	NO	NO	TSV	NO	NO	NO	NO	TSV	S	TSV
4"	DT	S	NO	NO	TSV	S	S	NO	NO	TSV	S	TSV
6"	DT	DT	S	S	TSV	DT	S	S	S	TSV	S	TSV
8"	DT	DT	S	S	TSV	DT	DT	S	S	TSV	S	TSV
12"	DT	DT	S	S	TSV	DT	DT	S	S	TSV	S	TSV
16"	DT	DT	S	S	TSV	DT	DT	S	S	TSV		
20"	DT	DT	S	S	TSV	DT	DT	S	S	TSV		

NOTE:

1. ALL TAPPING SADDLES 2" AND SMALLER, SHALL CONSIST OF A BRONZE BODY WITH TWO (2) BRONZE STRAPS
2. EXISTING STEEL MAINS 12" IN DIAMETER OR LESS, SHALL BE TAPPED USING AN APPROVED TAPPING SADDLE
3. ALL TAPS SHALL BE MADE WITH AN APPROVED TAPPING TOOL
4. NO COUPLINGS ARE ALLOWED BETWEEN CURB STOP AND METER SETTER. SEE STANDARDS FOR ADDITIONAL REQUIREMENTS
5. SERVICE SHALL BE TYPE K COPPER FROM MAIN TO METER





July 2019

Sheet Revisions		
Date	Comments	Initials



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No Revisions:				37TH STREET 2B
Revised:	Designer: T. Tuttle	Structure		Drawing Number DT-009
	Detailer: S. Hemler	Numbers		
Void:	Sheet Subset: DETAILS	Subset Sheets: 9 of 11		Sheet Number 28

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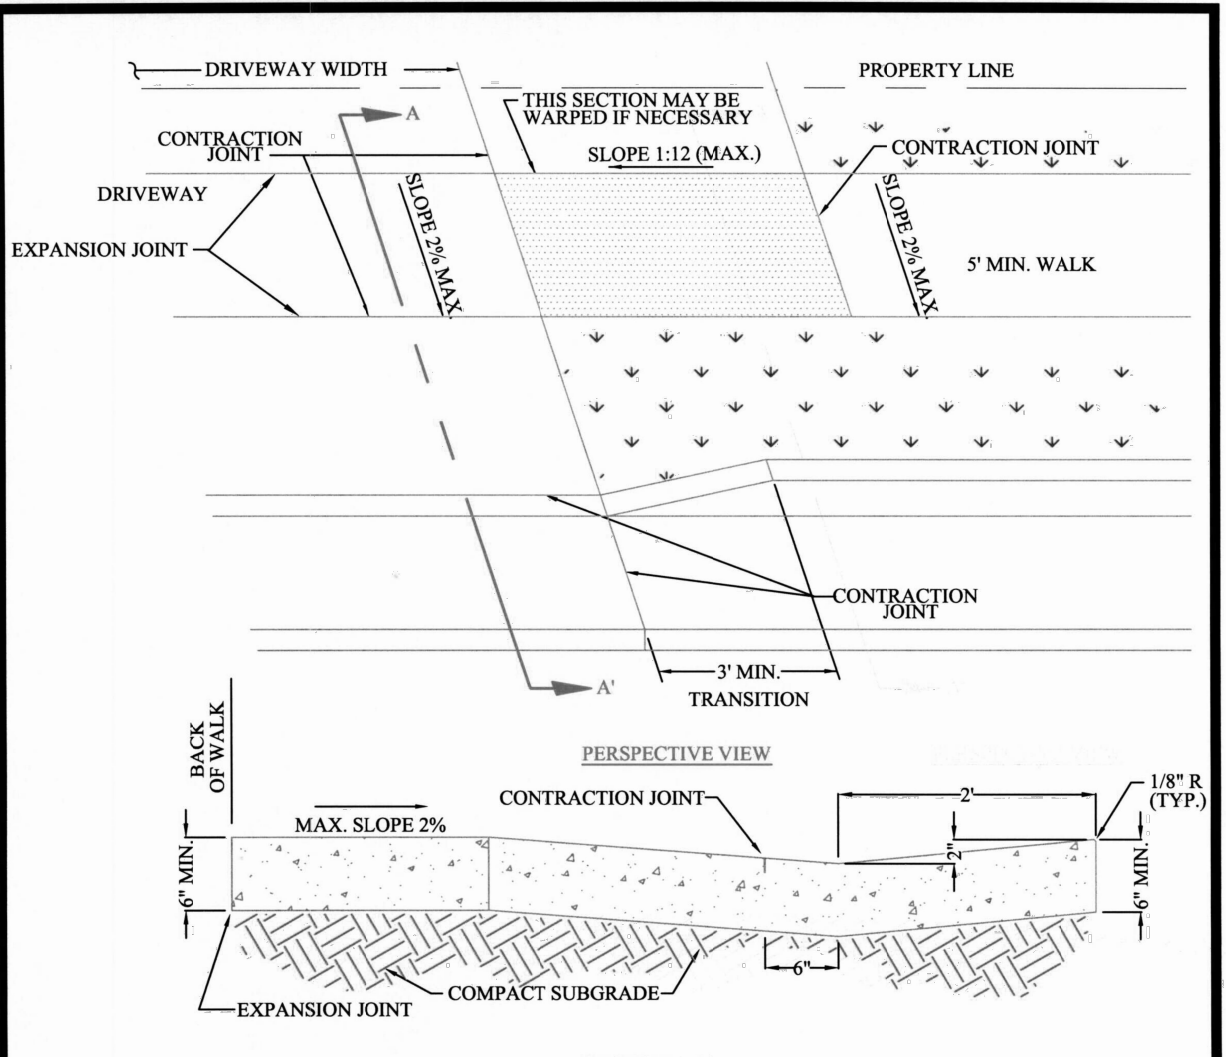

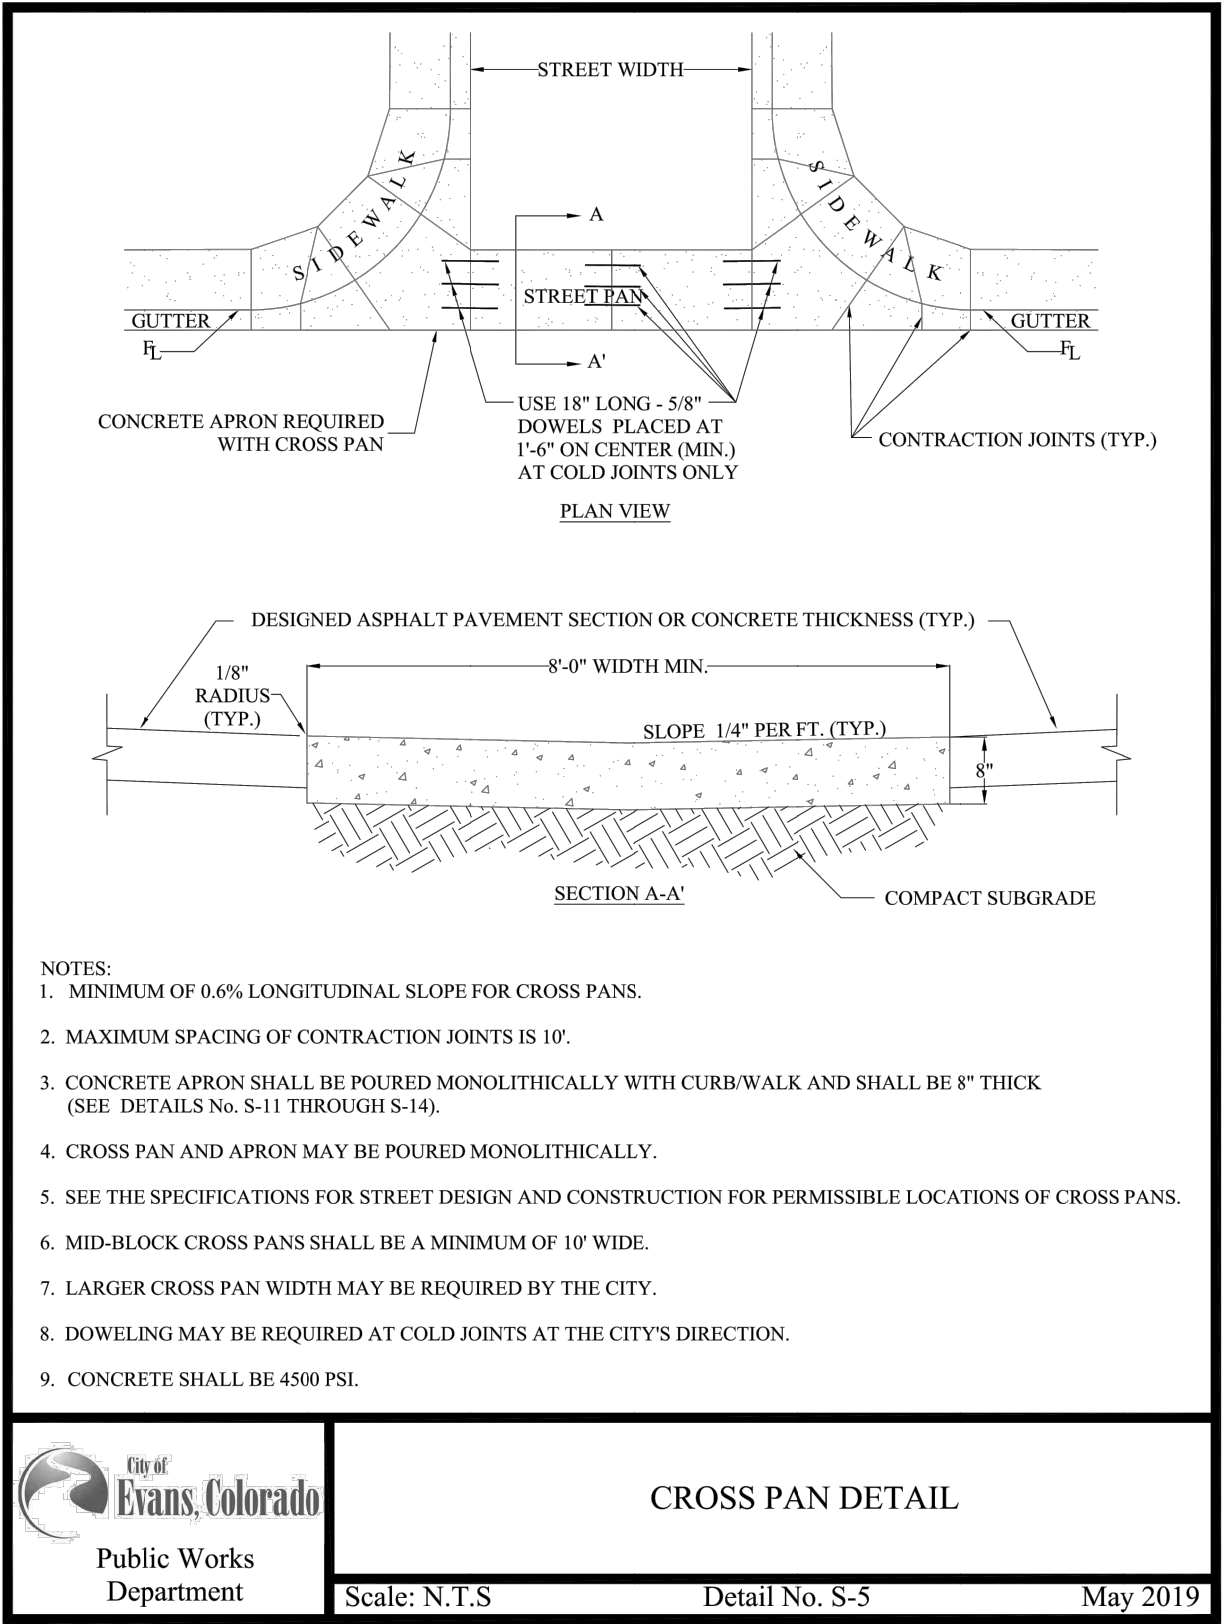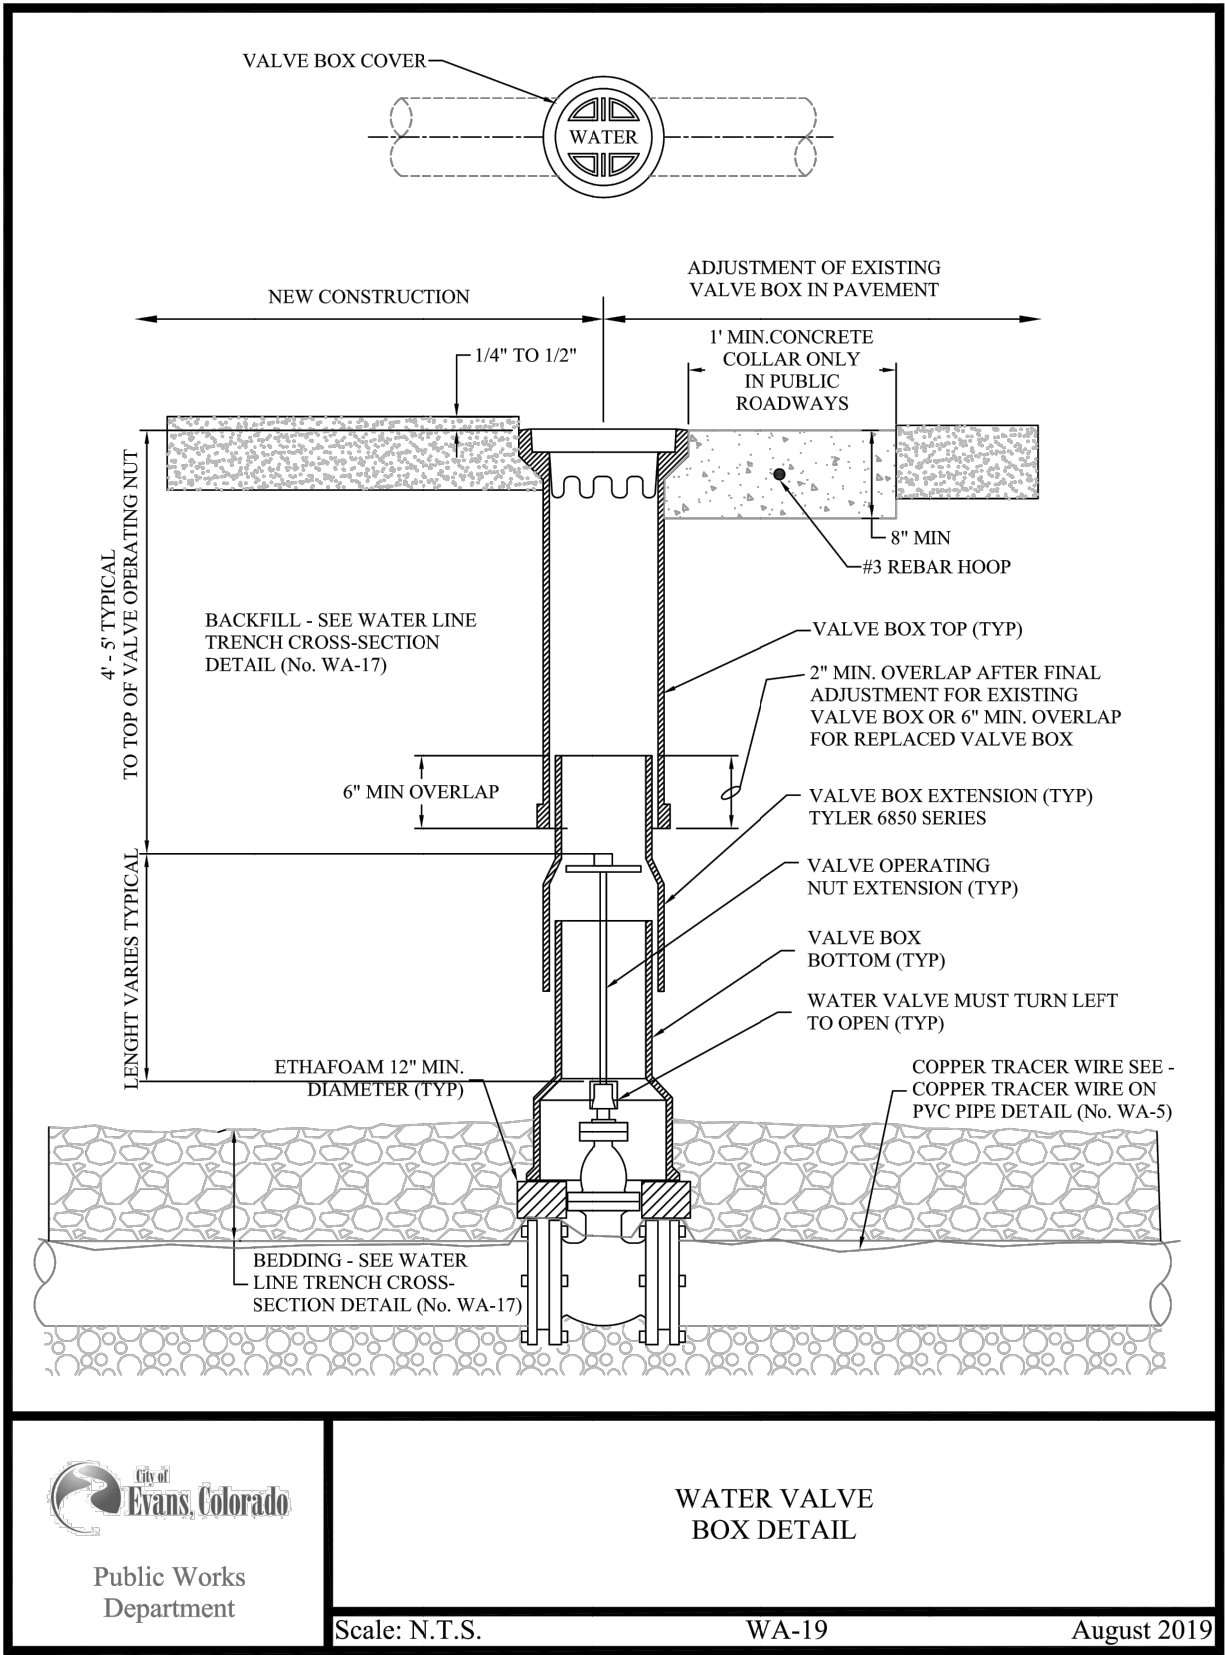
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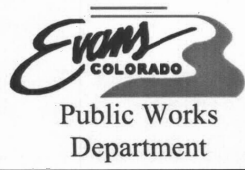
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Date	Comments	Initials

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	No Revisions:		Designer: T. Tuttle		37TH STREET 2B
	Revised:		Detailer: S. Hemler		Drawing Number DT-010
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FOR CONSTRUCTION 5/1/2025




- NOTES:
- CONTRACTION JOINTS ARE REQUIRED AT EACH END OF WARPED SECTION & SHOULD BE EVENLY SPACED.
 - APPLY BROOM FINISH TO SURFACE.
 - DRIVEWAY SECTION SHALL BE 6" THICK ON ALL RESIDENTIAL, MULTIFAMILY RESIDENTIAL, & 8" THICK ON ALL COMMERCIAL, INDUSTRIAL & ALLEY DRIVEWAYS.
 - DRIVEWAY WIDTHS: 10' (MIN.) & 20' (MAX.)
 - DRIVEWAY WIDTHS FOR COMMERCIAL/ INDUSTRIAL AREAS AS APPROVED BY THE CITY.
 - SHOW DIMENSIONS OF DRIVEWAY ON DETAILED CONSTRUCTION PLANS.
 - RETROFIT DRIVE APPROACHES SHALL MATCH EXISTING CONDITIONS EXCEPT CONCRETE THICKNESSES SHALL CONFORM TO THIS DETAIL.



**DRIVEWAY APPROACH DETAIL
DETACHED SIDEWALK
FOR VERTICAL CURB & GUTTER**

Scale: N.T.S Detail No. S-18 April 2004

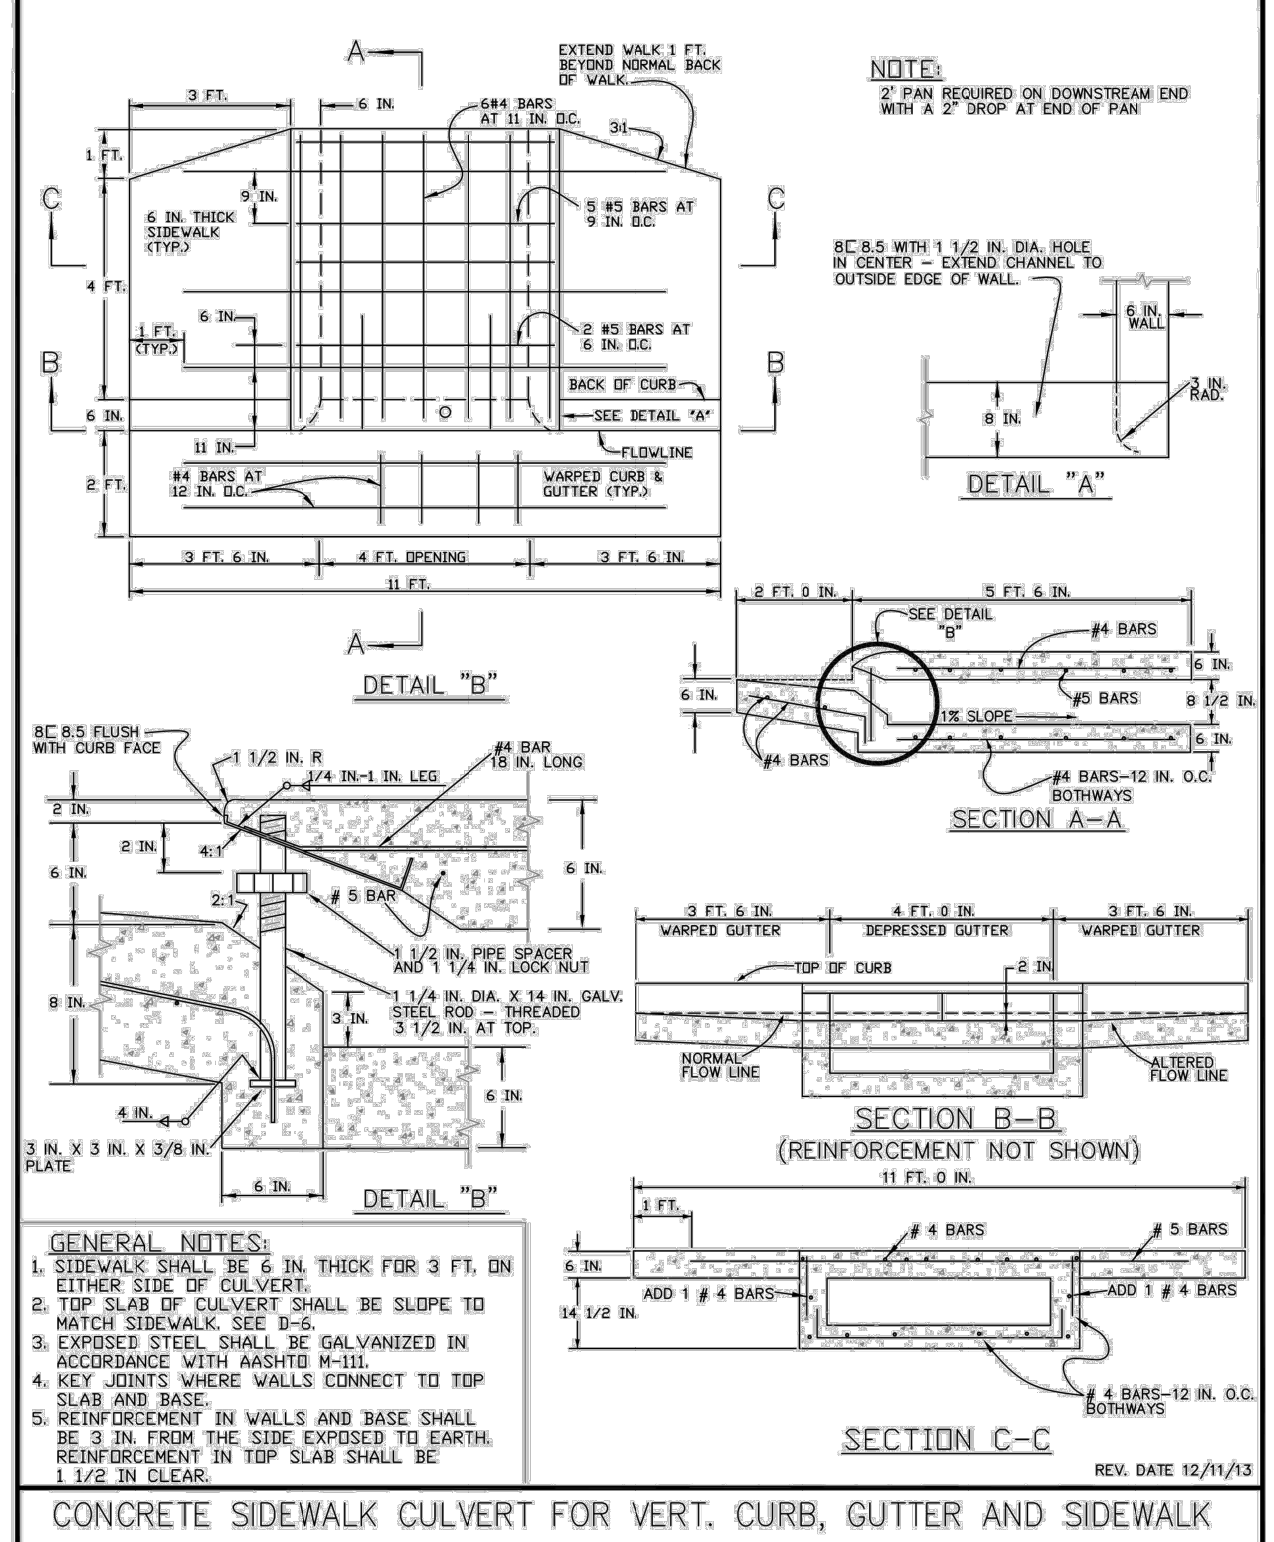

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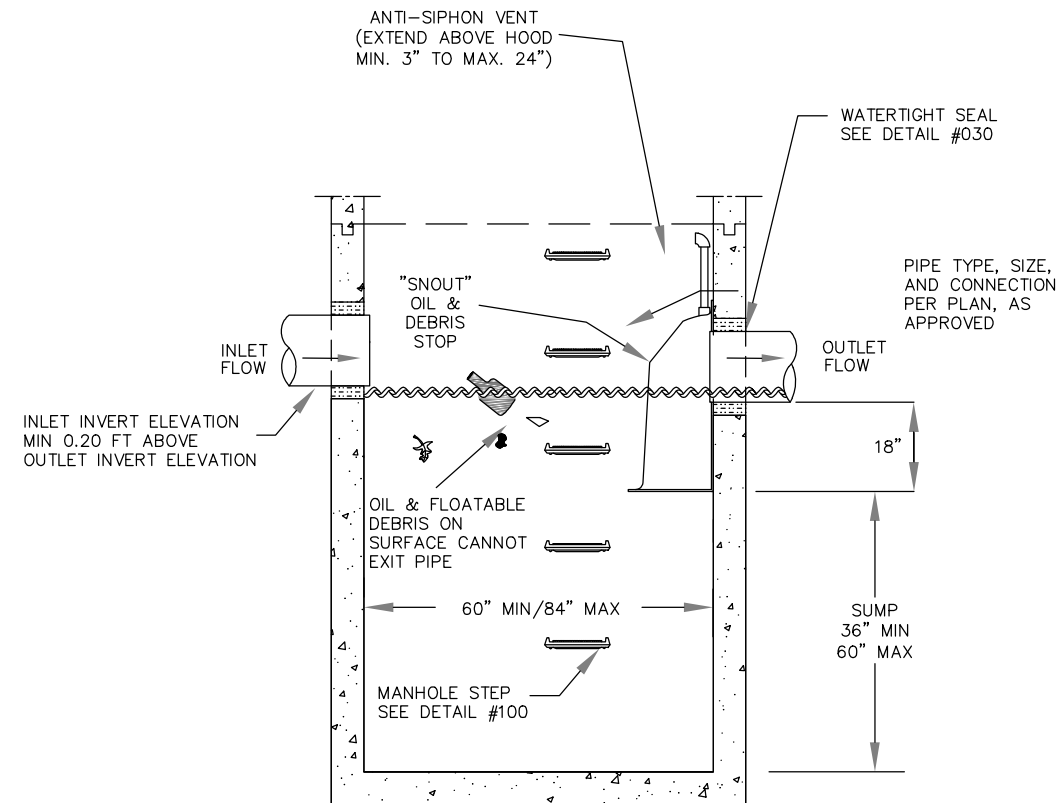
Print Date: 5/2/2025		<div><div></div><div>Sheet Revisions</div><table><thead><tr><th>Date</th><th>Comments</th><th>Initials</th></tr></thead><tbody><tr><td></td><td></td><td></td></tr><tr><td></td><td></td><td></td></tr><tr><td></td><td></td><td></td></tr><tr><td></td><td></td><td></td></tr></tbody></table></div>	Date	Comments	Initials													<div>As Constructed</div> <div>No Revisions:</div> <div>Revised:</div> <div>Void:</div>		<div>37TH STREET WIDENING PHASE 2B DETAILS</div> <table><tr><td>Designer:</td><td>T. Tuttle</td><td>Structure Numbers</td><td></td></tr><tr><td>Detailer:</td><td>S. Hemler</td><td></td><td></td></tr><tr><td>Sheet Subset:</td><td>DETAILS</td><td>Subset Sheets:</td><td>11 of 11</td></tr></table>			Designer:	T. Tuttle	Structure Numbers		Detailer:	S. Hemler			Sheet Subset:	DETAILS	Subset Sheets:	11 of 11	<div>Project No.</div> <div>37TH STREET 2B</div> <div>Drawing Number DT-011</div> <div>Sheet Number 30</div>	
Date	Comments		Initials																																	
Designer:	T. Tuttle	Structure Numbers																																		
Detailer:	S. Hemler																																			
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City of
Evans, Colorado



FOR CONSTRUCTION 5/1/2025



NOTES:

1. ALL MANHOLE SECTIONS SHALL CONFORM TO THE REQUIREMENTS OF ASTM C-478 AND APPLICABLE PROVISIONS OF STD. MANHOLE DRAWING NO. 010.
2. INLET AND OUTLET PIPE NOT TO EXCEED 18"DIA.
3. PROVIDE SPECIAL DETAIL FOR SNOOT 18" DIA.
4. THE SIZE AND POSITION OF THE HOOD SHALL BE DETERMINED BY THE OUTLET PIPE SIZE AS PER MANUFACTURER'S RECOMMENDATIONS.
5. ANCHORING HARDWARE FOR THE HOOD SHALL BE EMBEDDED INTO CONCRETE; ANCHORING INTO GROUT IS NOT AUTHORIZED.
6. THE SURFACE OF THE STRUCTURE WHERE THE HOOD IS MOUNTED SHALL BE FINISHED SMOOTH AND FREE OF LOOSE MATERIAL.
7. INSTALL PER MANUFACTURER'S INSTRUCTION AND USING MANUFACTURER'S INSTALLATION KIT.

SUMP VOLUME AVAILABLE PER DEPTH OF SUMP		
	36" MINIMUM	60" MAXIMUM
60" M.H.=	58.9 CF	98.1 CF
72" M.H.=	84.8 CF	141.3 CF
84" M.H.=	115.4 CF	192.4 CF


PROVIDE SPECIAL DETAIL FOR VOLUME REQUIREMENTS EXCEEDING 192.4 CF

SUMP VOLUME REQUIREMENTS	
20 CF/1.0 CFS OF INFLOW	
58.9 CF MINIMUM REQUIRED	

WATER QUALITY MANHOLE (SNOOT)

DRAWING NO. 250

REVISED 12-16

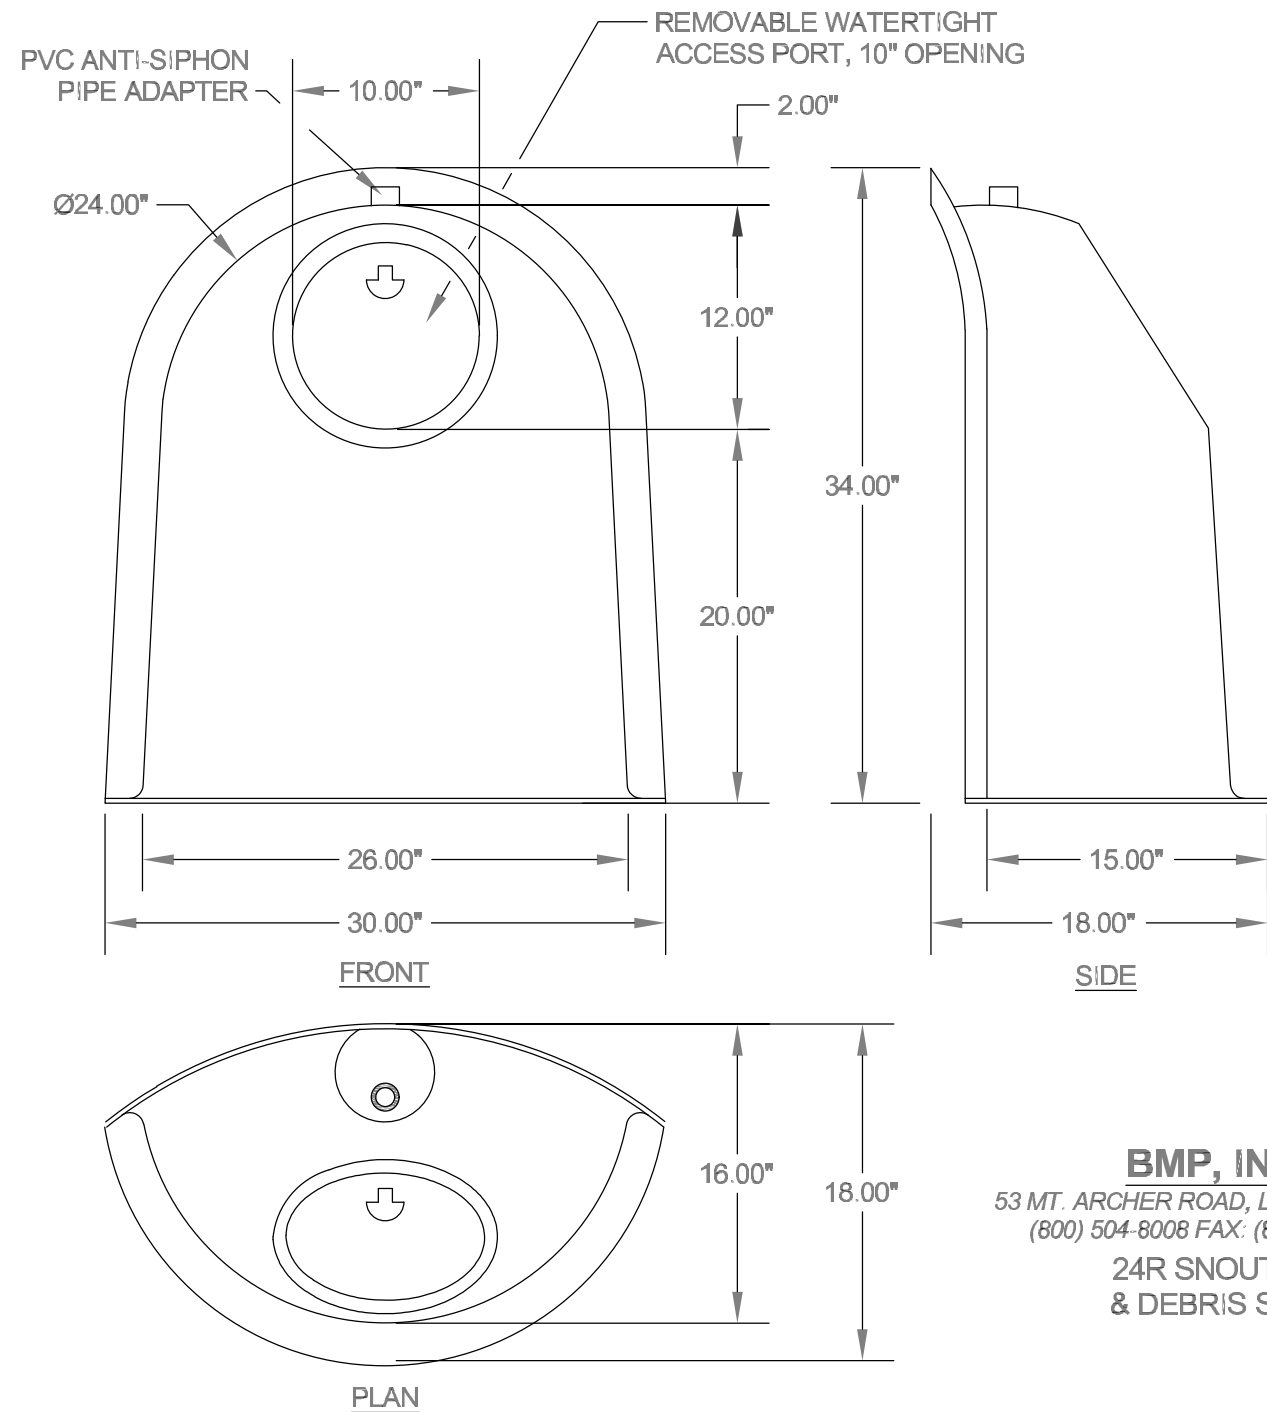

DESIGNED TO FIT
48"-60" DIAM.
STRUCTURES

BMP, INC.

53 MT. ARCHER ROAD, LYME, CT. 06371
(800) 504-8008 FAX: (860) 434-3195

24R SNOOT OIL
& DEBRIS STOP

Manhole (Snout & 4' Sump)
Sta. 59+07.02

Print Date: 4/17/2025


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Horiz. Scale: NTS

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Sheet Revisions

Date	Comments	Initials
4/16/25	Added details for storm sewer manhole	SAH



As Constructed

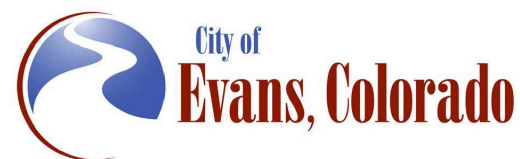No Revisions:

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37TH STREET WIDENING PHASE 2 DETAILS

Designer: T. Tuttle

Detailer: J. Jensen

Sheet Subset: DETAILS

Structure

Numbers

Subset Sheets: 12 of 12

Project No.

37TH STREET

Drawing Number DT-012

Sheet Number 30A



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Know what's below.
Call before you dig.



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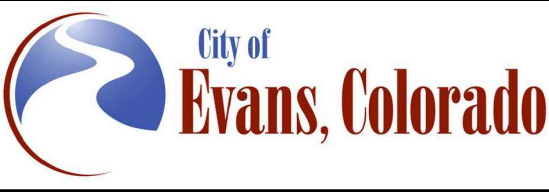
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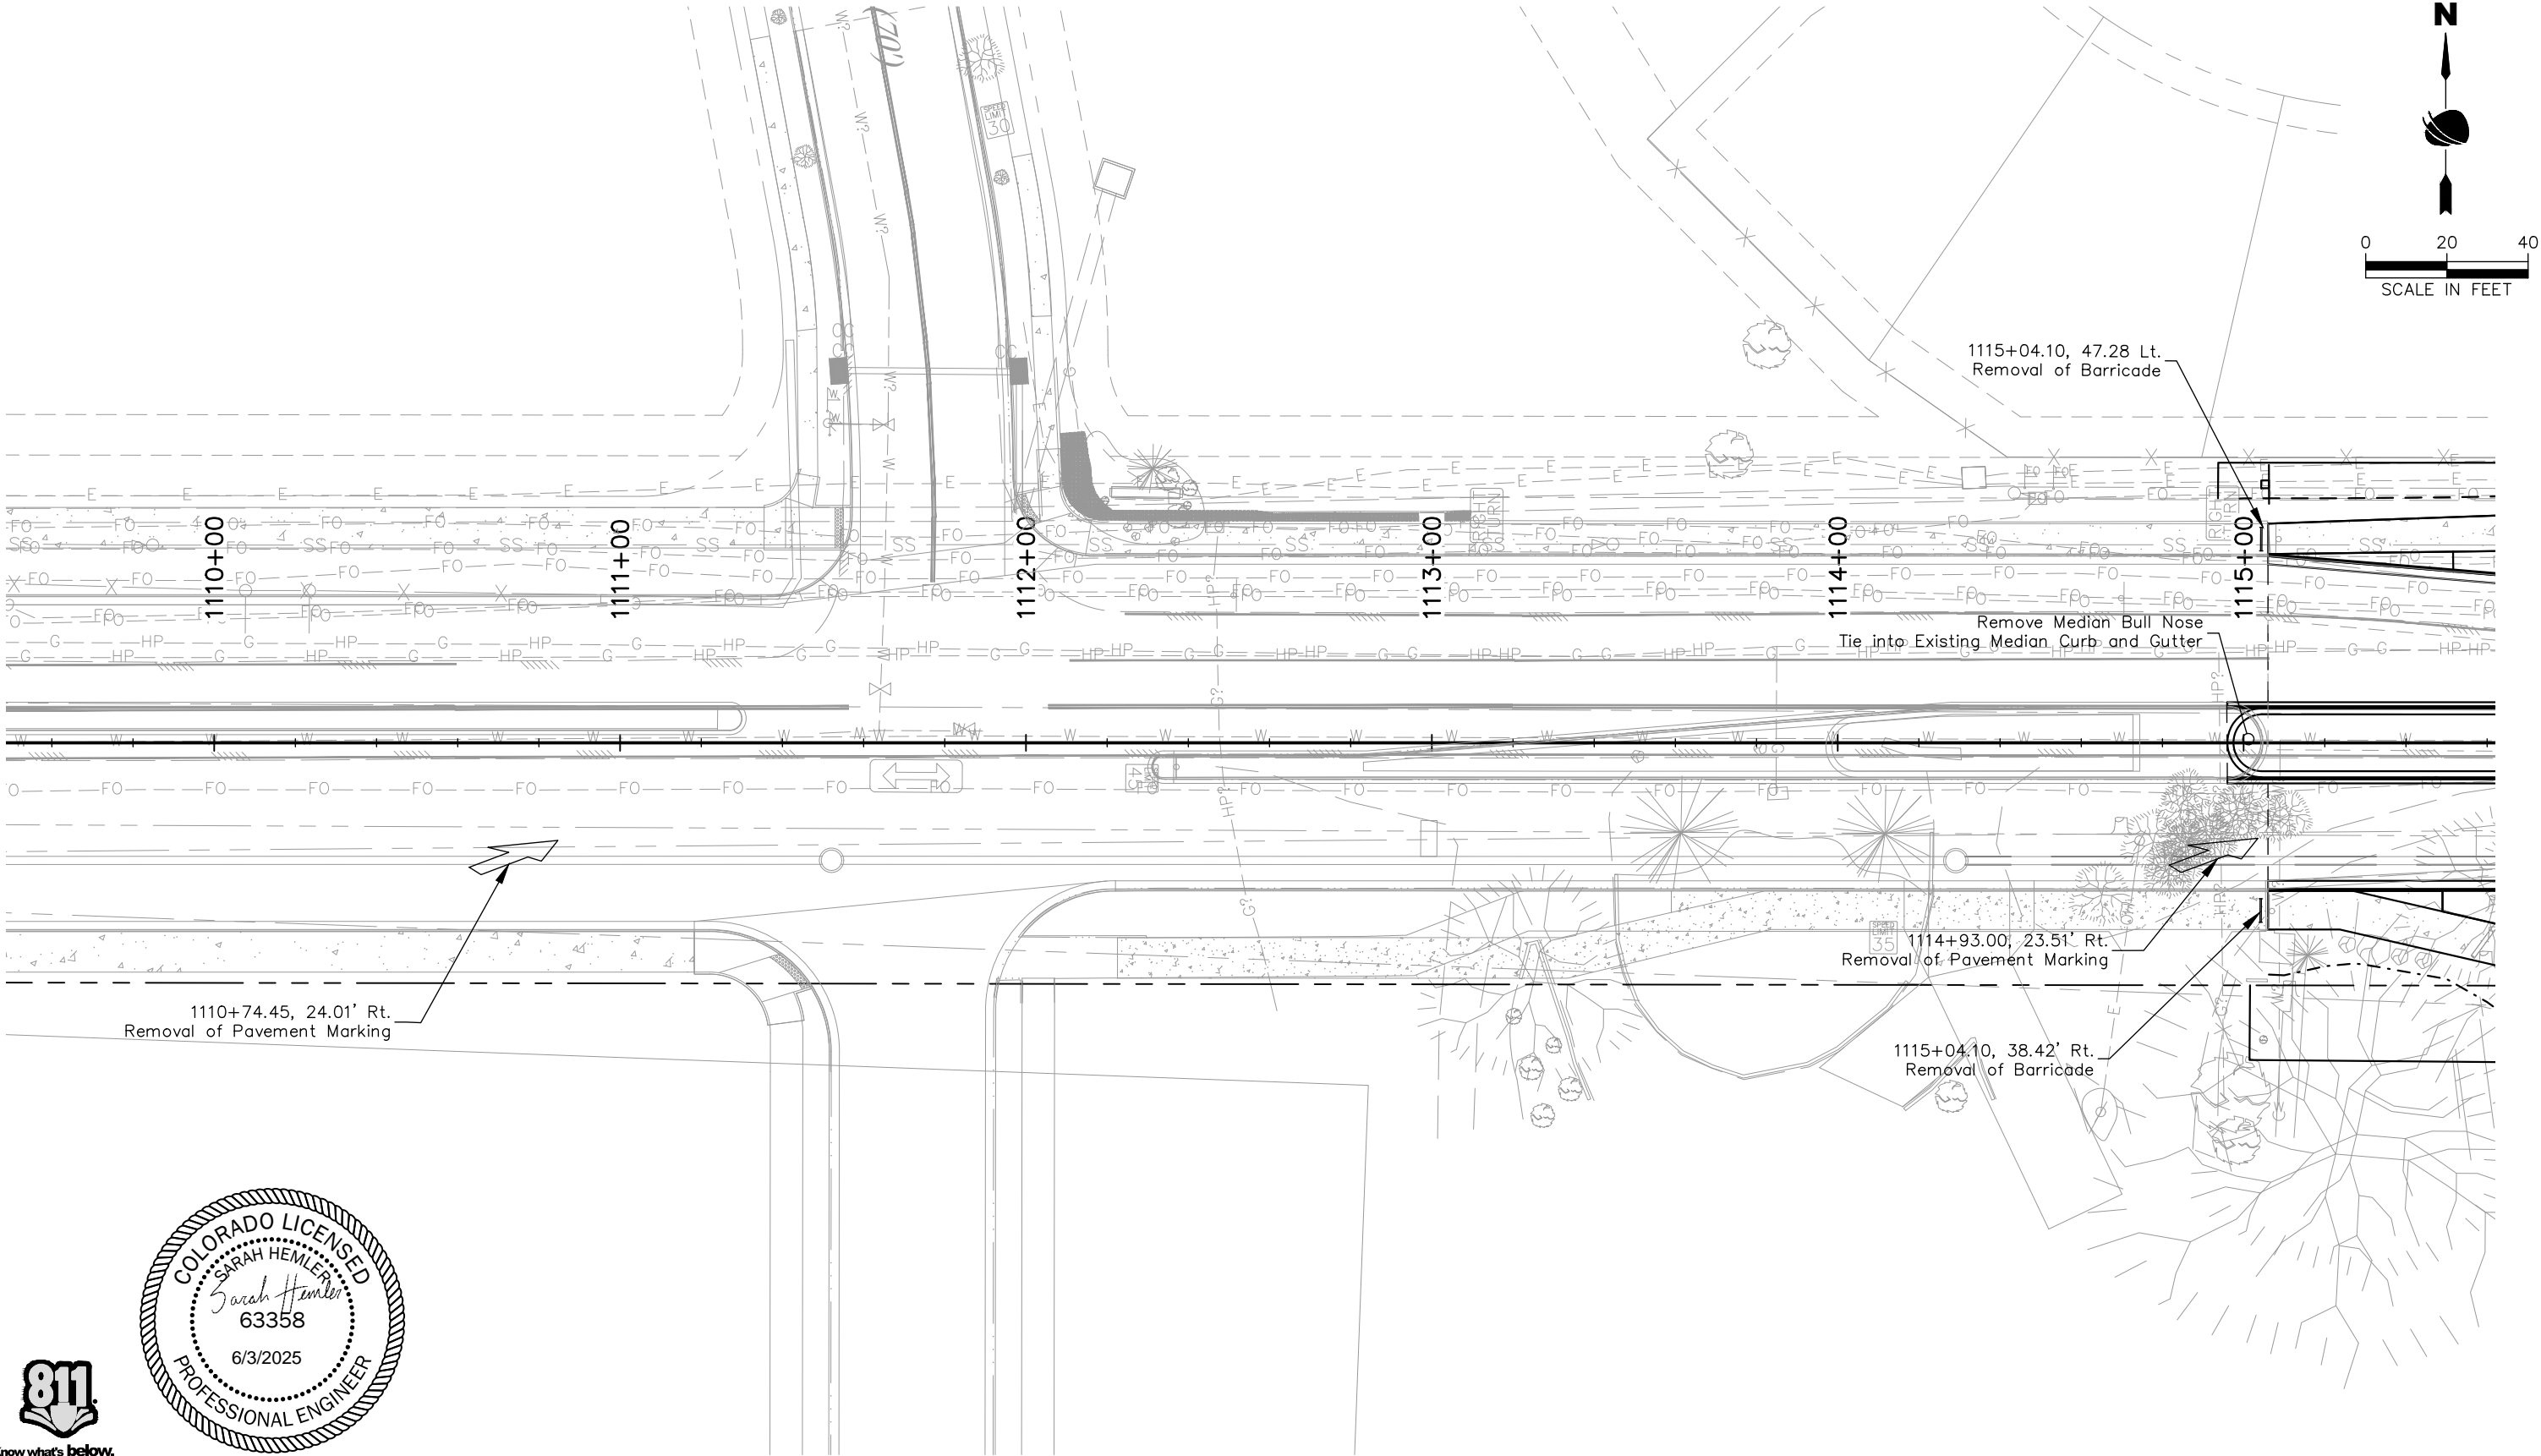
Sheet Revisions		
Date	Comments	Initials




As Constructed
No Revisions:
Revised:
Void:

37TH STREET WIDENING PHASE 2B REMOVAL PLAN		
Designer:	T. Tuttle	Structure Numbers
Detailer:	C. Petersen	
Sheet Subset:	TRAFFIC	Subset Sheets: 1 of 6

Project No.
37TH STREET 2B
Drawing Number REM-001
Sheet Number 31



FOR CONSTRUCTION 5/1/2025

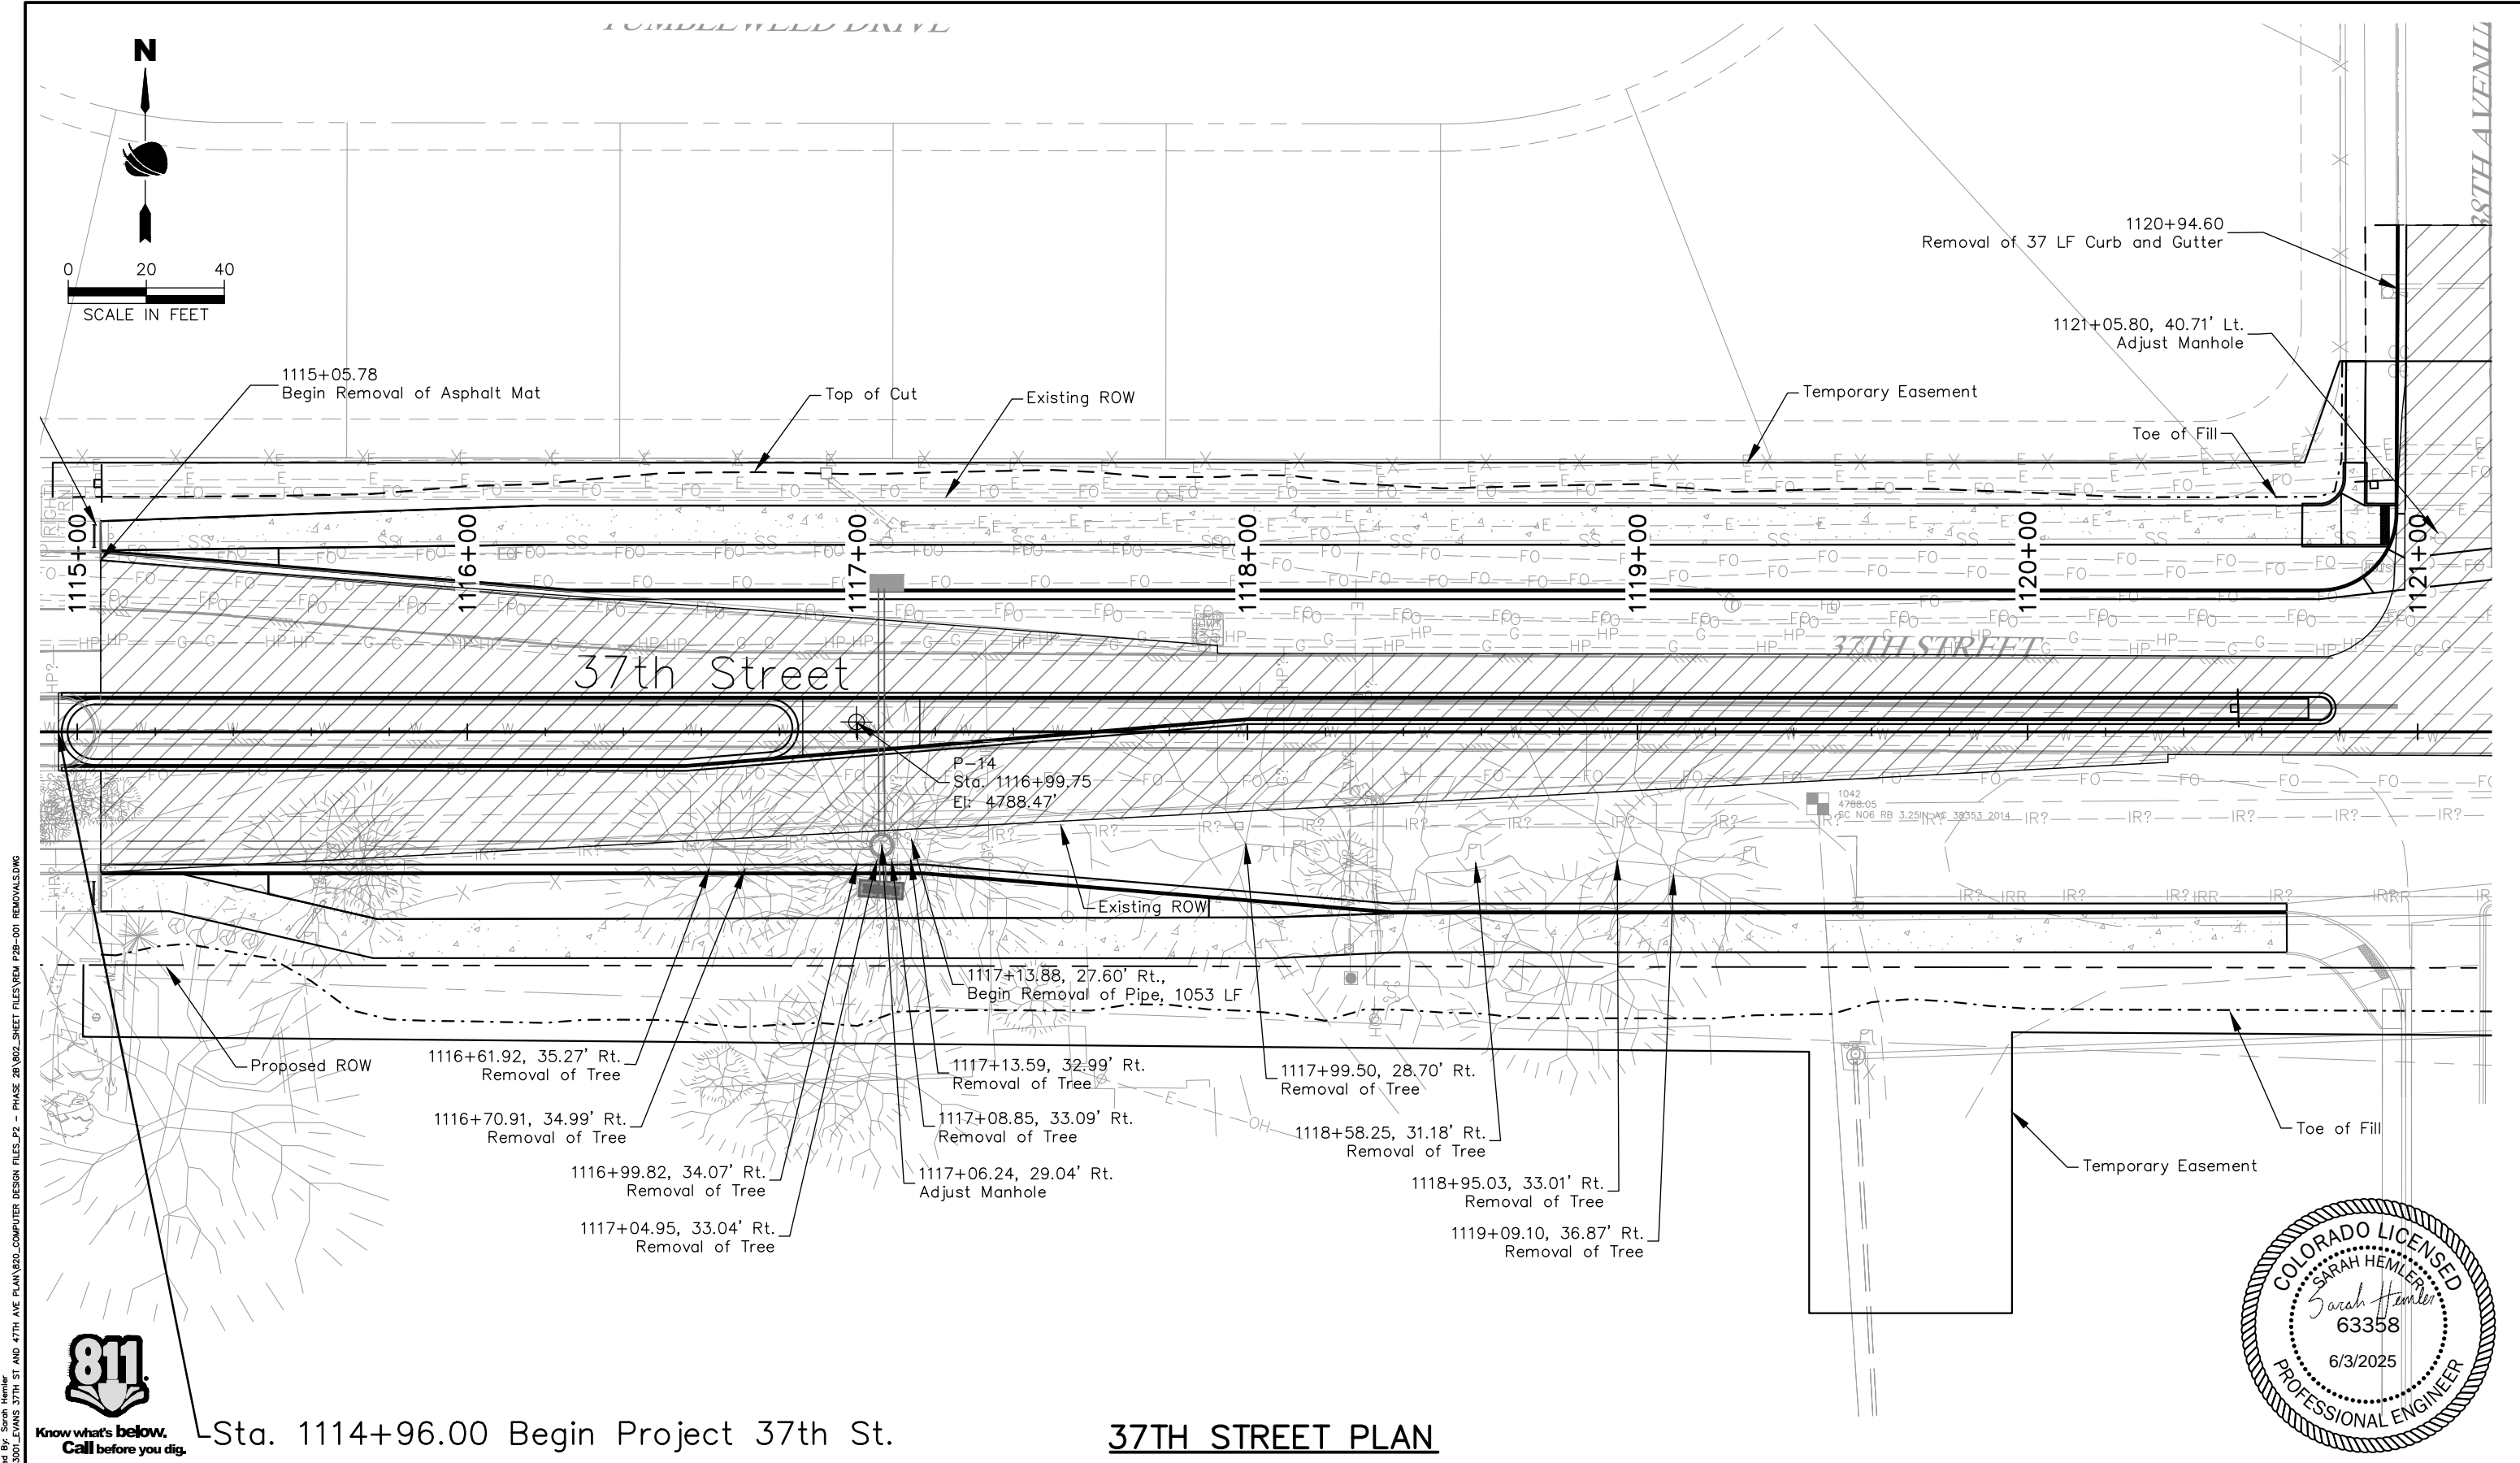



Know what's below.
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Sta. 1114+96.00 Begin Project 37th St.

37TH STREET PLAN



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File Name: REM P2B-001 REMOVALS.DWG		Date	Comments	Initials			Designer: T. Tuttle	Structure Numbers	Drawing Number REM-002	
Horiz. Scale: As Noted Vert. Scale: N/A							Detailer: S. Hemler		Sheet Number 32	



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FOR CONSTRUCTION 5/1/2025



37TH STREET PLAN

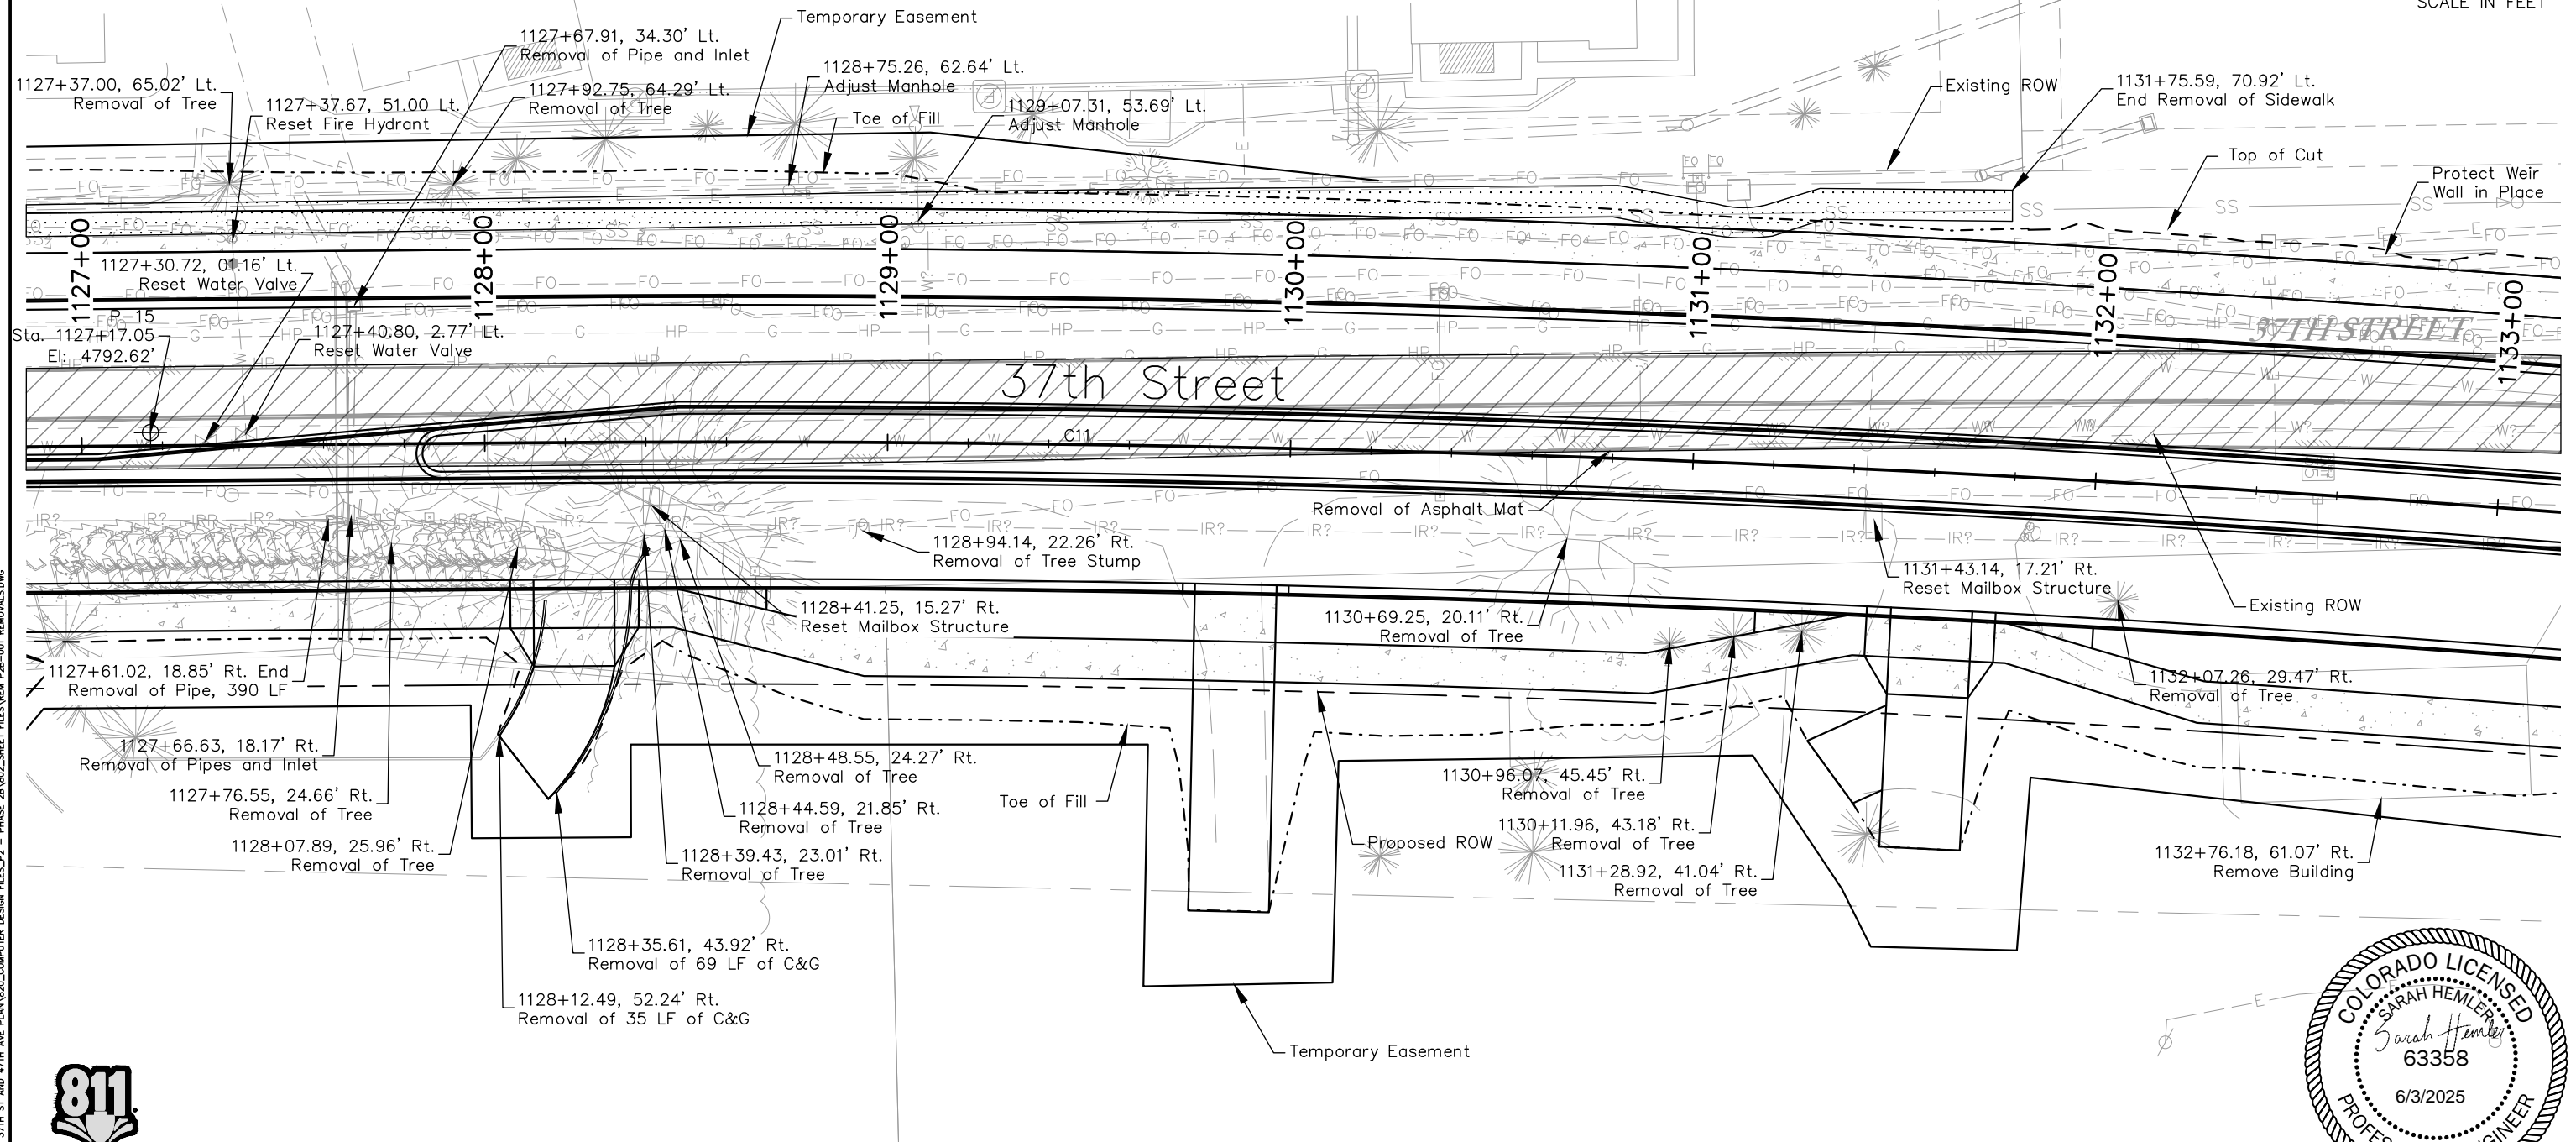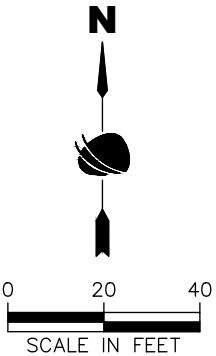


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C:\Q-PROJECTS\37TH STREET WIDENING PHASE 2B\37TH ST AND 47TH AVE PLAN\37TH STREET WIDENING PHASE 2B-001 REMOVALS.DWG

Print Date: 5/2/2025	
File Name: REM P2B-001 REMOVALS.DWG	
Horiz. Scale: As Noted	Vert. Scale: N/A
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Sheet Revisions		
Date	Comments	Initials

	As Constructed		37TH STREET WIDENING PHASE 2B REMOVAL PLAN		Project No.
	No Revisions:				37TH STREET 2B
	Revised:	Designer: T. Tuttle	Structure		Drawing Number REM-004
	Void:	Detailer: S. Hemler	Numbers		Sheet Number 34
		Sheet Subset: PLAN	Subset Sheets: 4 of 6		

FOR CONSTRUCTION 5/1/2025

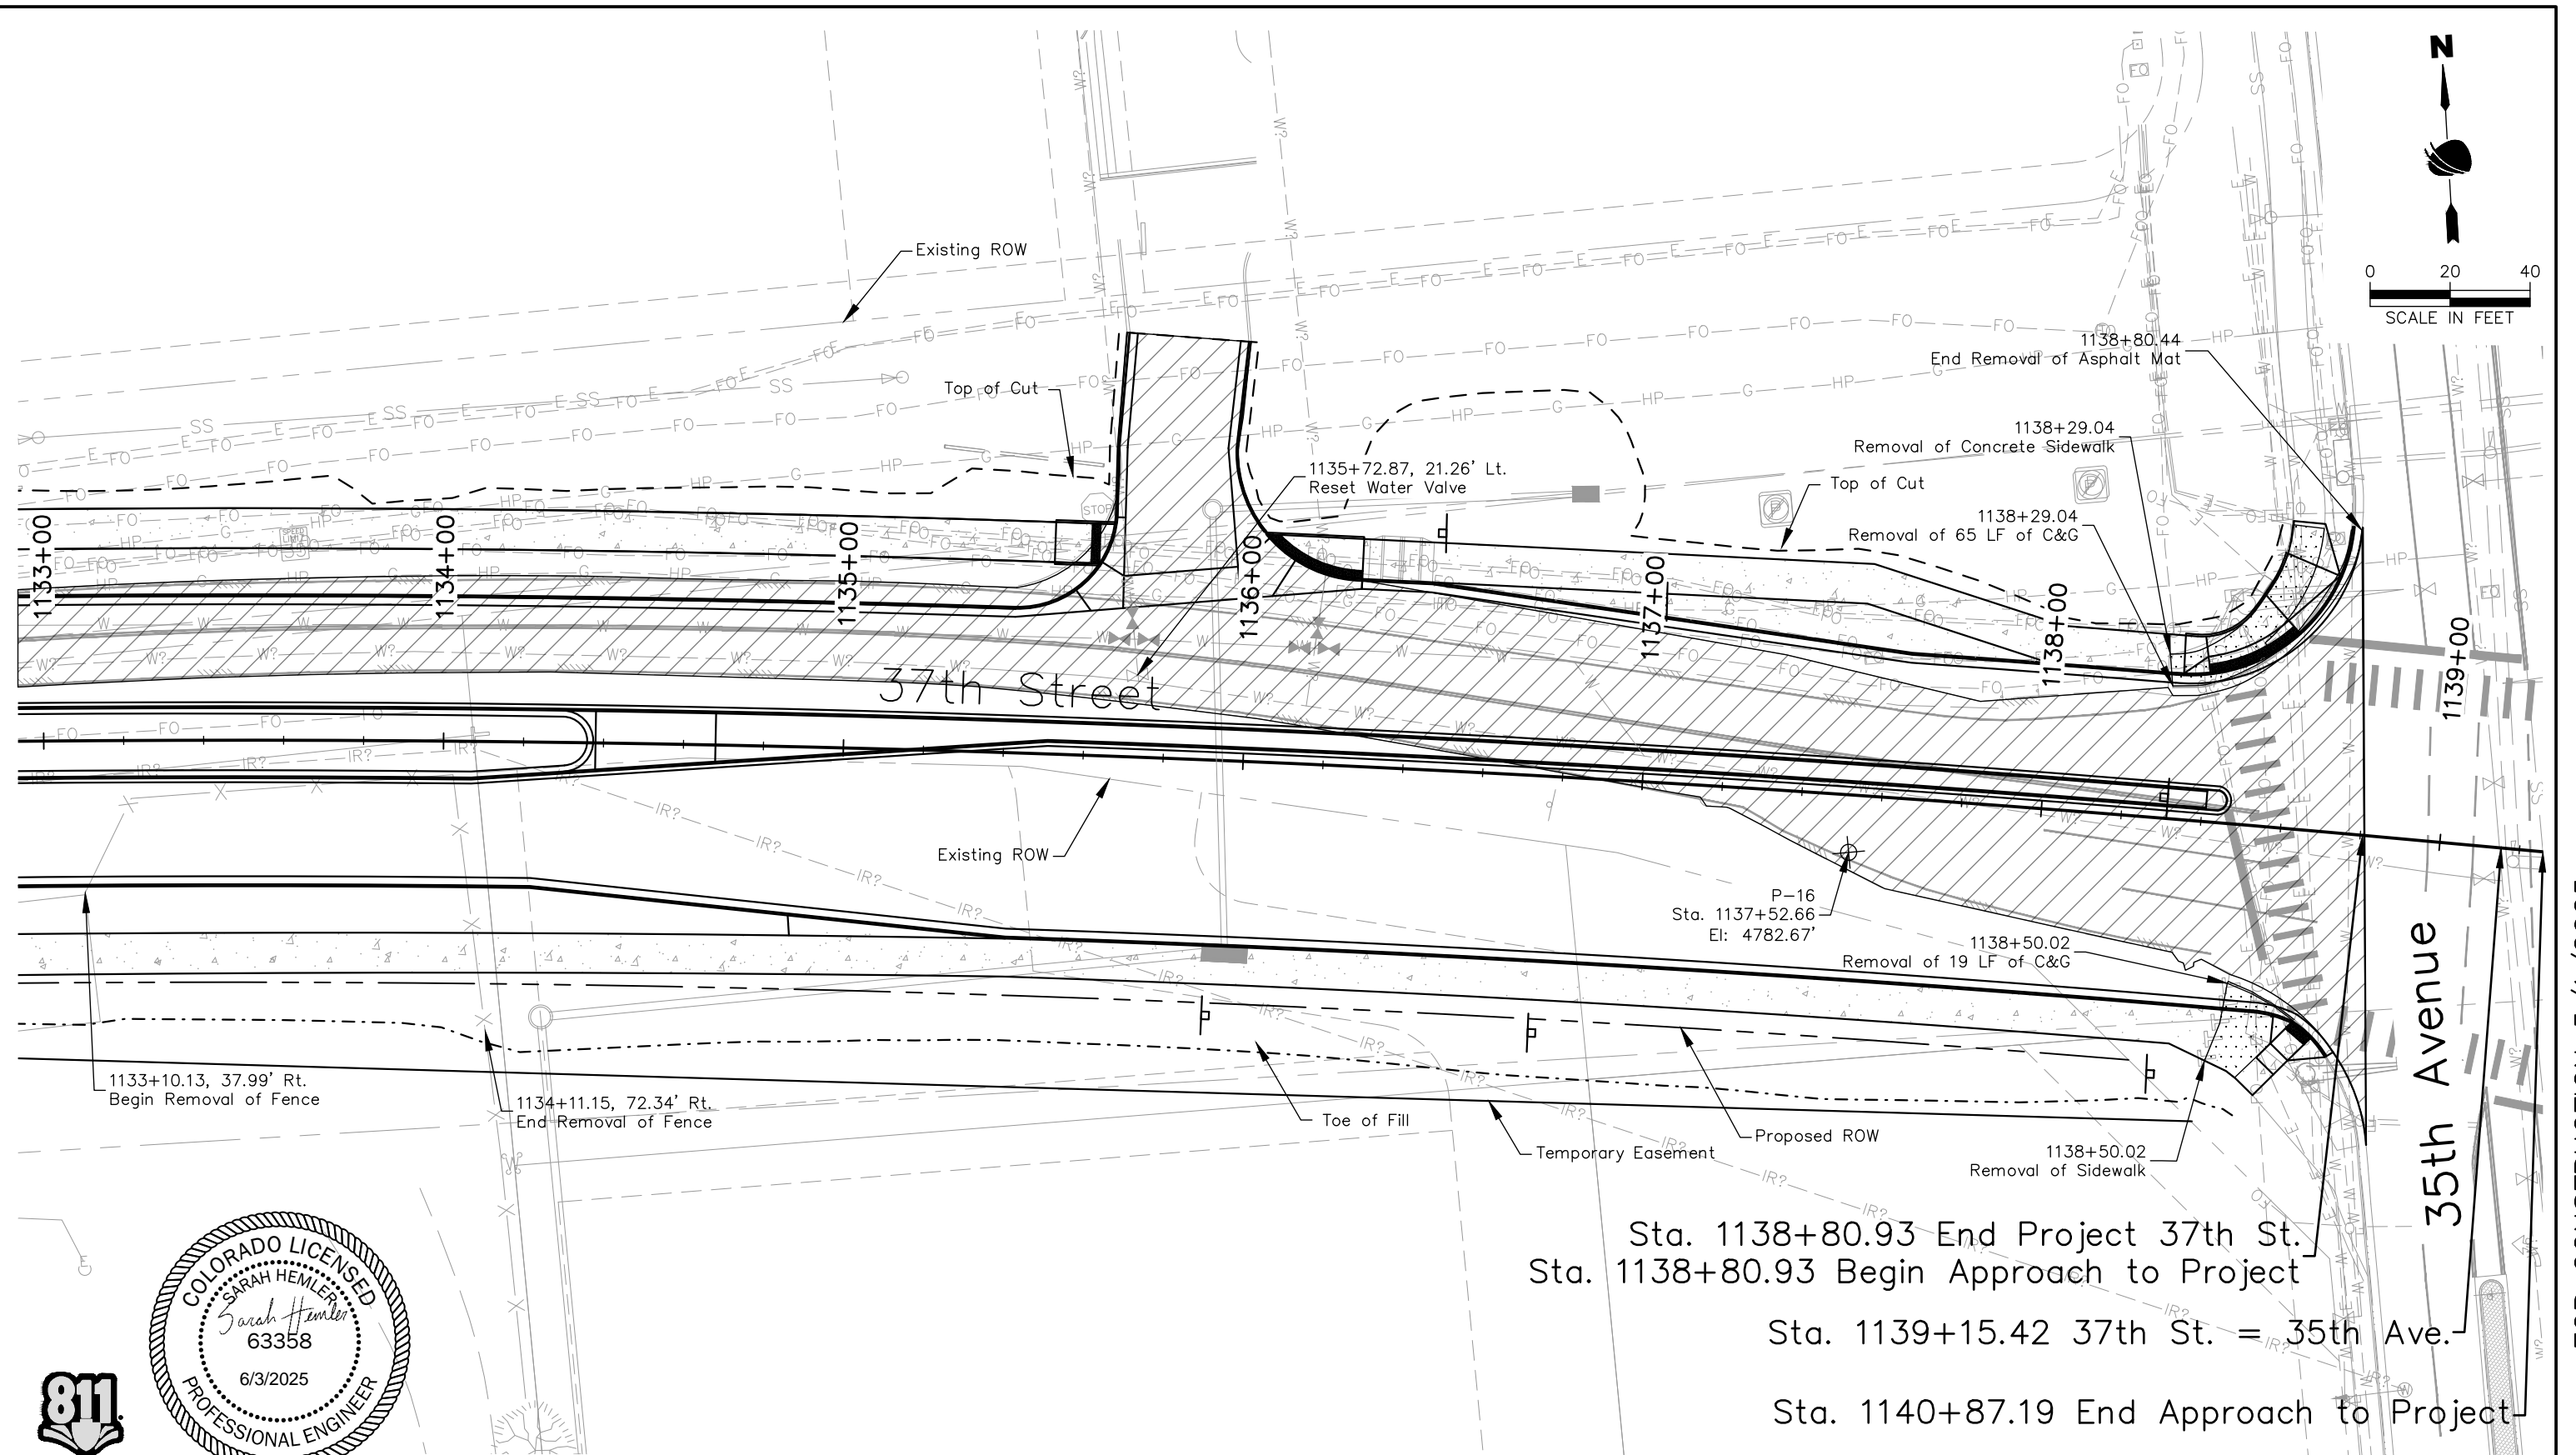

Plot Date: 5/2/2025 6:39 AM Plotted By: Sarah Hemler
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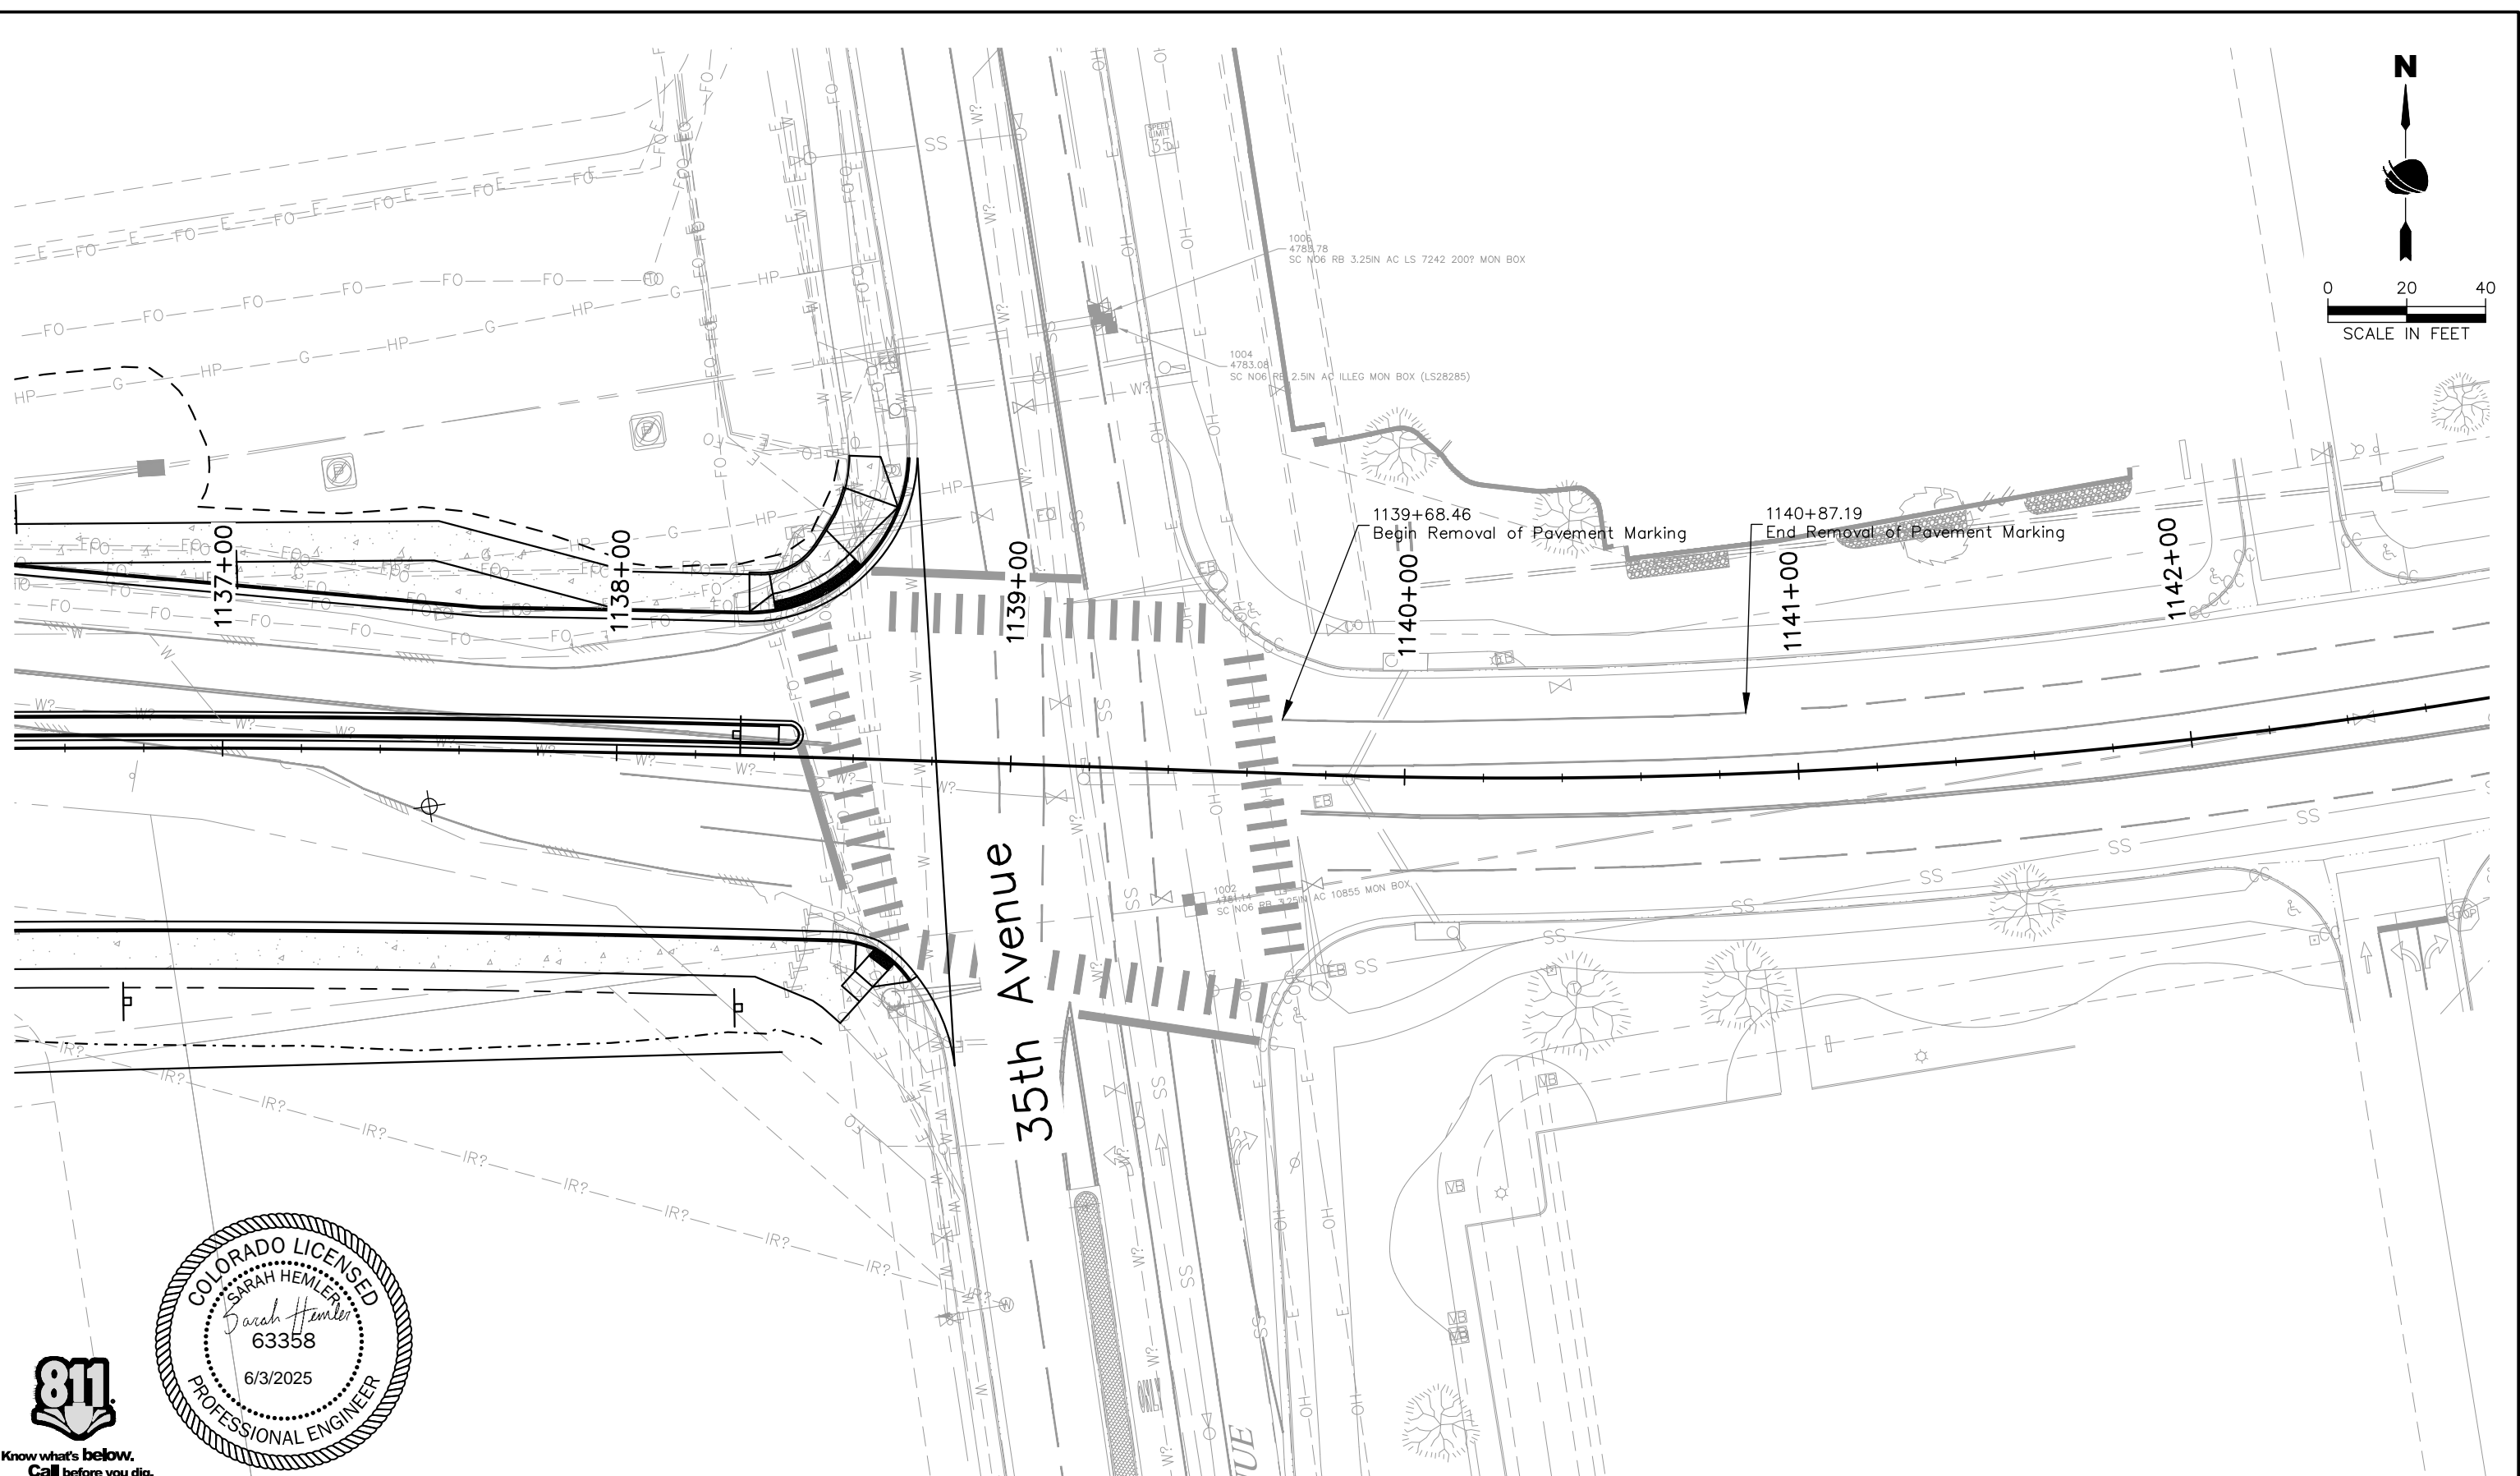
**Know what's below.
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37TH STREET PLAN



As Constructed	37TH STREET WIDENING PHASE 2B REMOVAL PLAN			Project No.
No Revisions:				37TH STREET 2B
Revised:	Designer: T. Tuttle	Structure		Drawing Number REM-005
	Detailer: S. Hemler	Numbers		
Void:	Sheet Subset: PLAN	Subset Sheets: 5 of 6		Sheet Number 35

Plot Date: 5/2/2025 6:39 AM Plotted By: Sarah Hemler
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
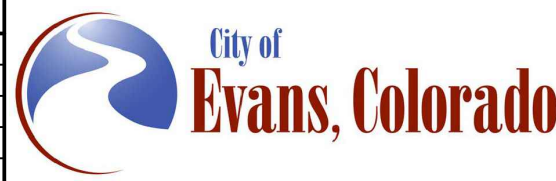


Know what's below.
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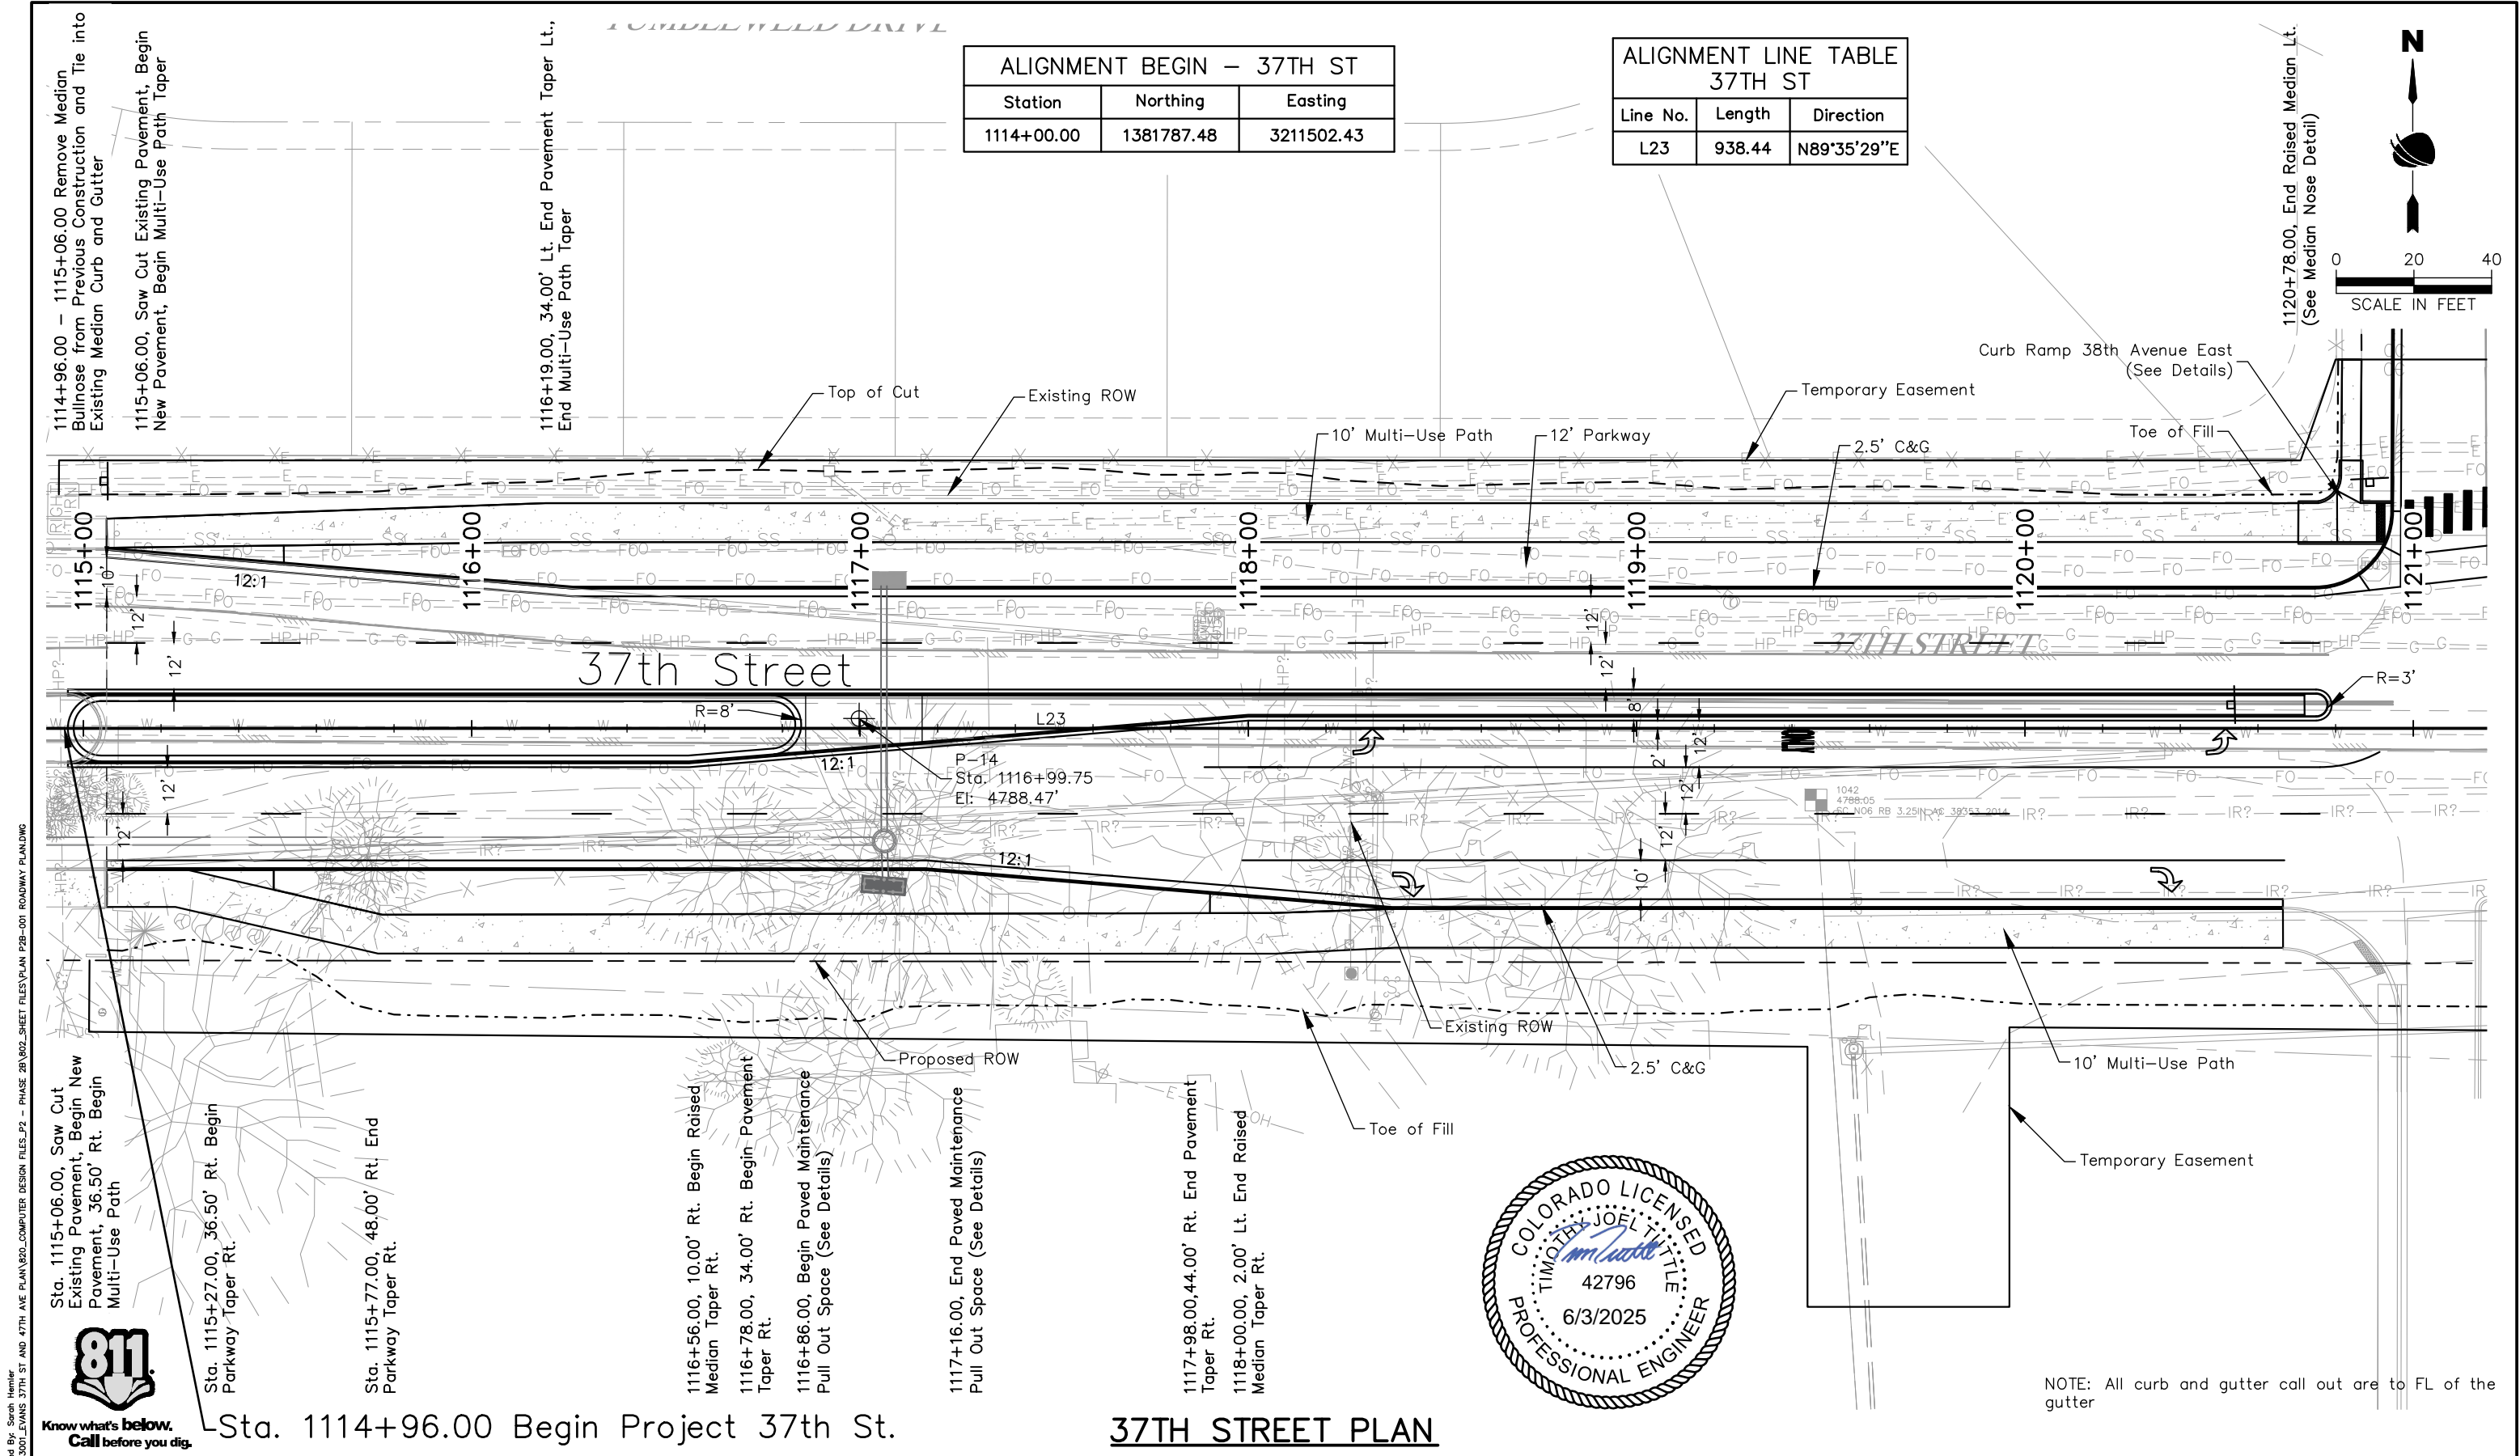
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File Name: REM P2B-001 REMOVALS.DWG	
Horiz. Scale: As Noted	Vert. Scale: N/A
	12076 Grant Street
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Sheet Revisions		
Date	Comments	Initials



As Constructed		37TH STREET WIDENING PHASE 2B REMOVAL PLAN			Project No.	
No Revisions:					37TH STREET 2B	
Revised:		Designer: T. Tuttle	Structure Numbers		Drawing Number REM-006	
Void:		Detailer: C. Petersen			Sheet Number 36	
		Sheet Subset: TRAFFIC	Subset Sheets: 6 of 6			

FOR CONSTRUCTION 5/1/2025



ALIGNMENT BEGIN - 37TH ST		
Station	Northing	Easting
1114+00.00	1381787.48	3211502.43

ALIGNMENT LINE TABLE 37TH ST		
Line No.	Length	Direction
L23	938.44	N89°35'29"E

FOR CONSTRUCTION 5/1/2025

Print Date: 5/2/2025

File Name: PLAN P2B-001 ROADWAY PLAN.DWG

Horiz. Scale: As Noted Vert. Scale: N/A

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000

Sheet Revisions		
Date	Comments	Initials

As Constructed		37TH STREET WIDENING PHASE 2B ROADWAY PLAN		Project No.
No Revisions:		Designer: T. Tuttle		37TH STREET 2B
Revised:		Detailer: S. Hemler	Structure Numbers	
Void:		Sheet Subset: PLAN	Subset Sheets: 1 of 4	Drawing Number PLAN-001
				Sheet Number 37

Plot Date: 5/2/2025 6:41 AM Plotted By: Sarah Hemler
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Plot Date: 5/2/2025 6:41 AM Plotted By: Sarah Hemler
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Know what's below.
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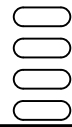
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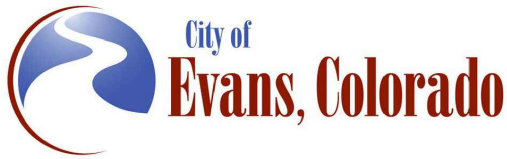
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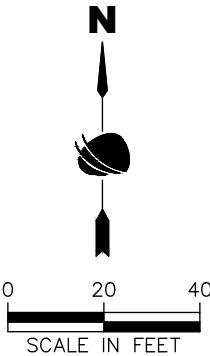
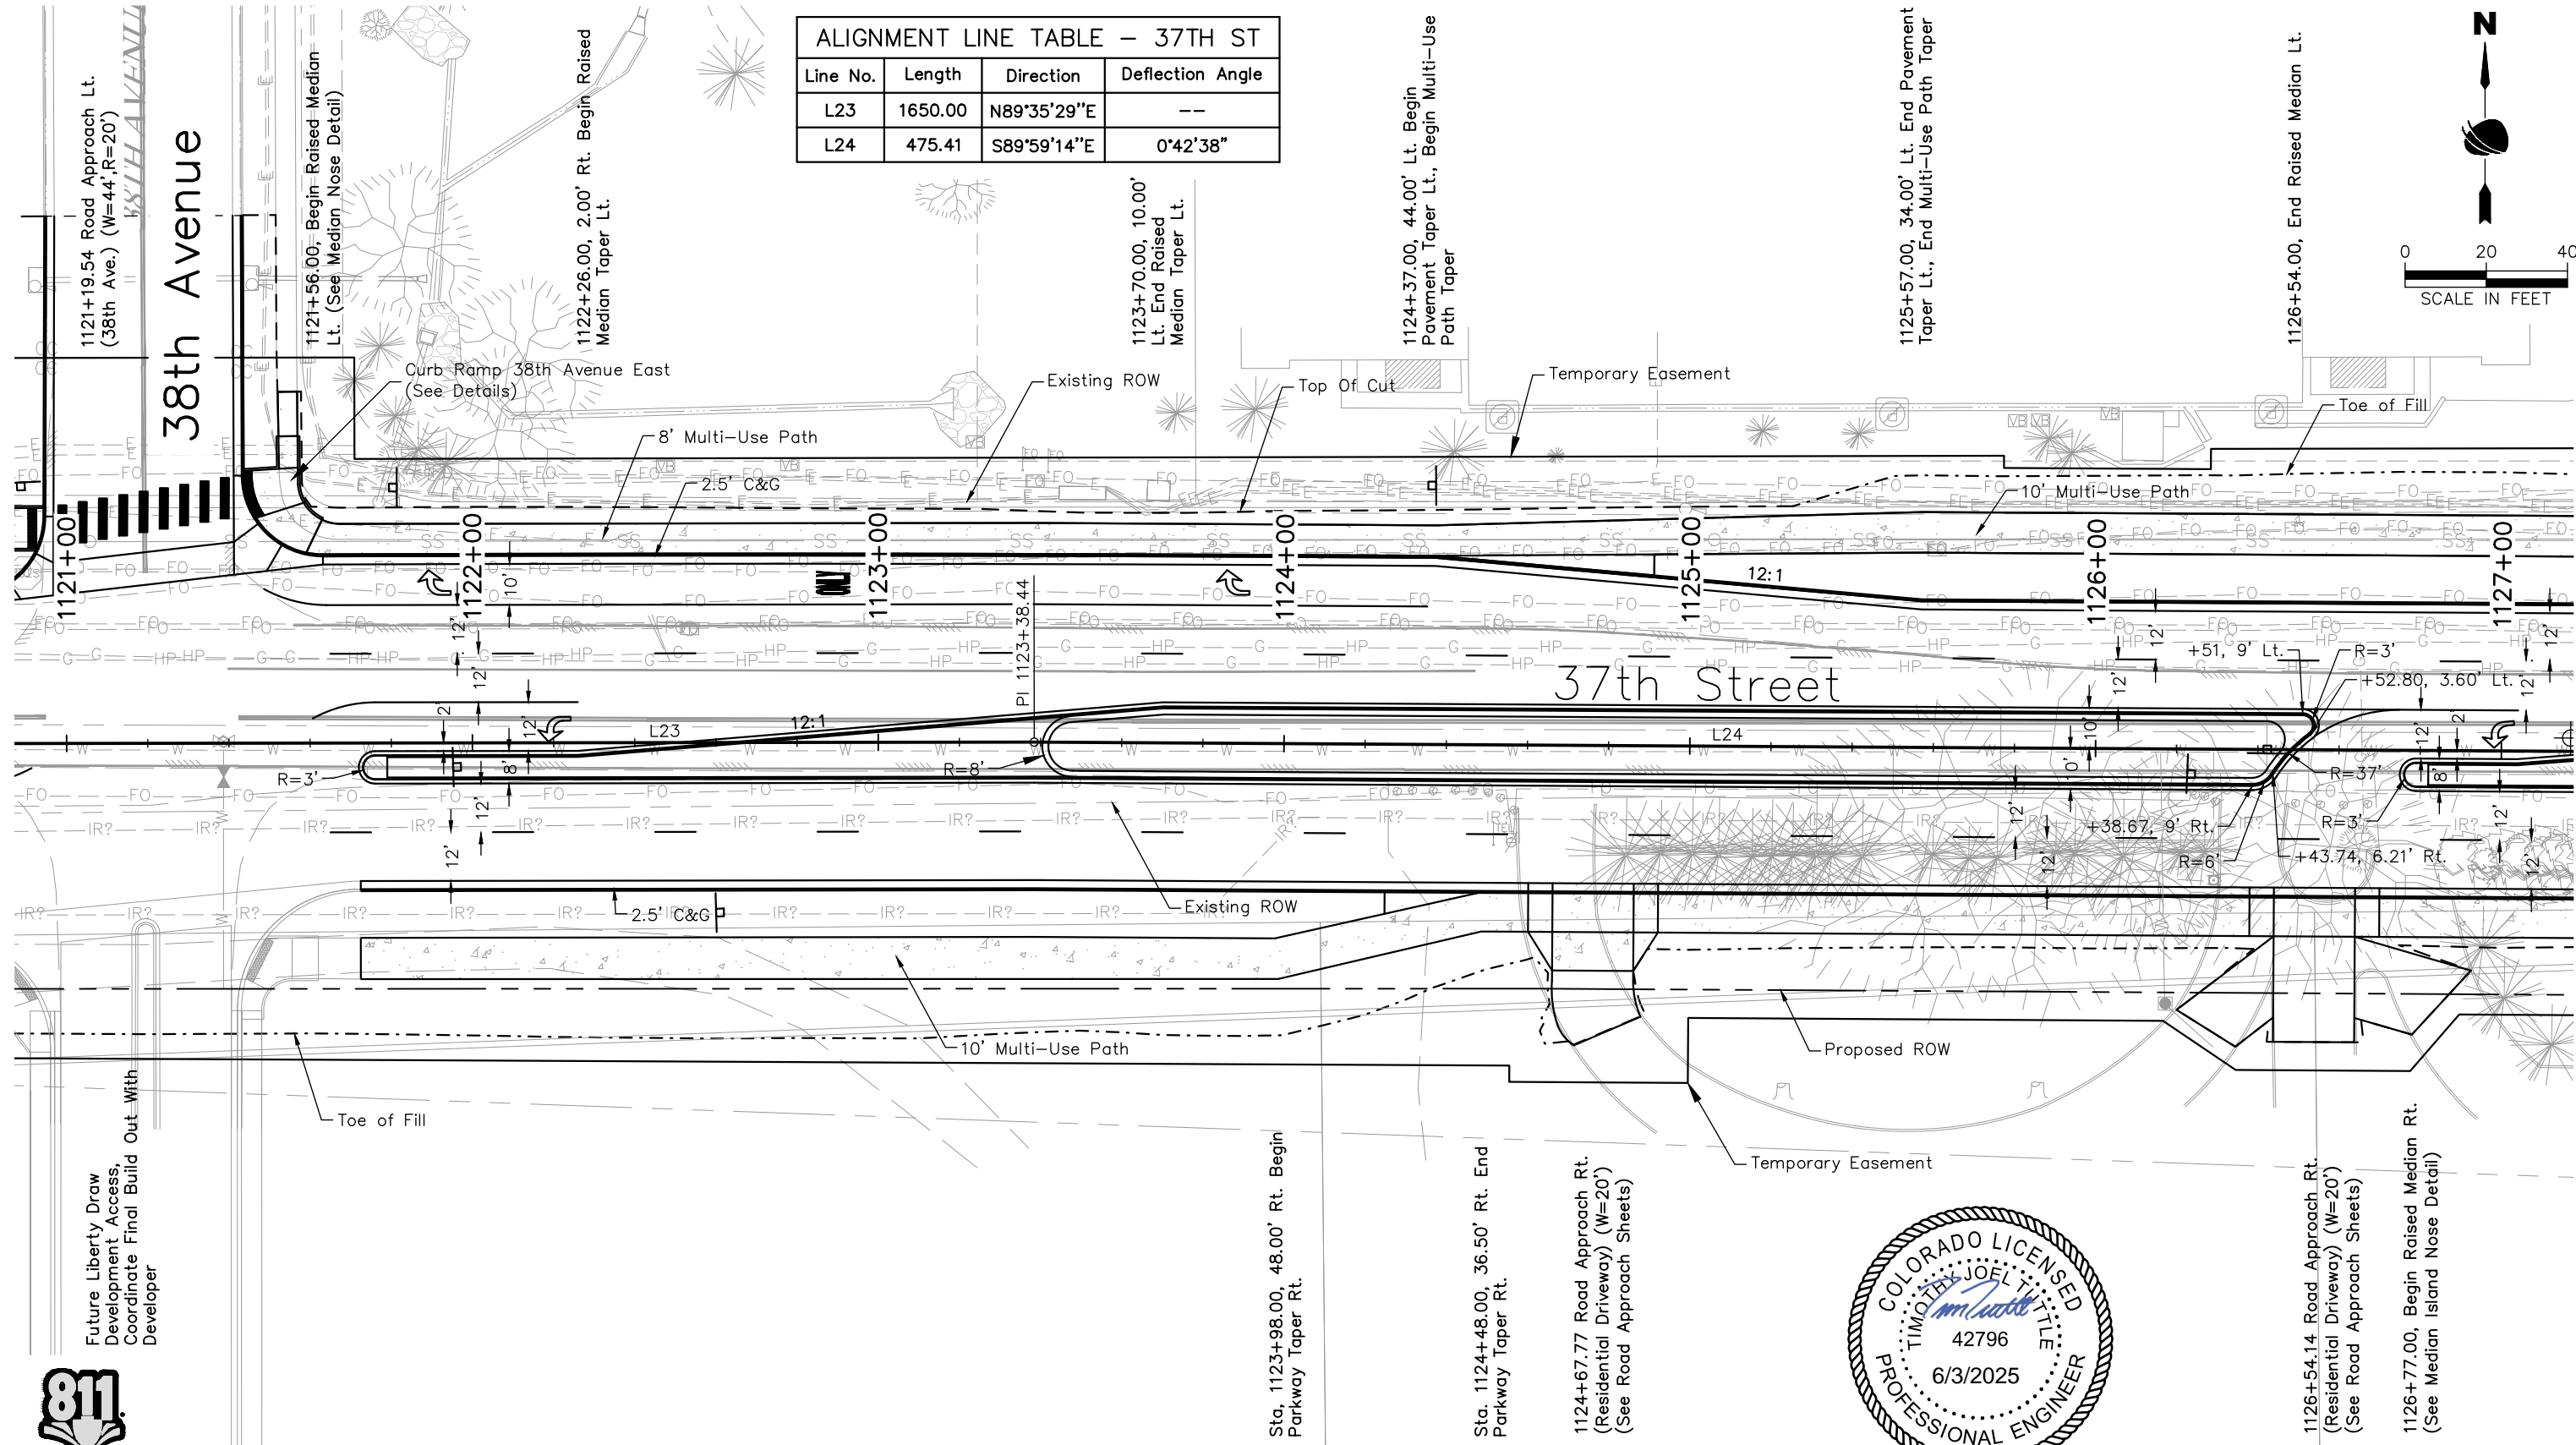
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Sheet Revisions		
Date	Comments	Initials



As Constructed		37TH STREET WIDENING PHASE 2B ROADWAY PLAN		Project No.
No Revisions:		Designer: T. Tuttle		37TH STREET 2B
Revised:		Detailer: S. Hemler	Structure Numbers	Drawing Number PLAN-002
Void:		Sheet Subset: PLAN	Subset Sheets: 2 of 4	Sheet Number 38



37TH STREET PLAN

NOTE: All curb and gutter call out are to FL of the gutter



FOR CONSTRUCTION 5/1/2025



ALIGNMENT CURVE TABLE - 37TH ST									
Curve No.	PC Sta.	PI Sta.	PT Sta.	Delta	L	T	R	Dc	MDS
C11	1128+13.85	1133+54.72	1138+92.61	10°25'23" Rt.	1078.76	540.87	5935.00	0°57'58" Rt.	40 MPH
C12	1139+73.95	1141+22.27	1142+69.63	11°13'09" Rt.	295.67	148.31	1510.00	3°47'40" Lt.	40 MPH

ALIGNMENT LINE TABLE 37TH ST		
Line No.	Length	Direction
L25	81.34	S79°33'51"E
L26	202.70	N89°13'00"E

ALIGNMENT END - 37TH ST		
Station	Northing	Easting
1144+00.00	1381658.19	3214493.57

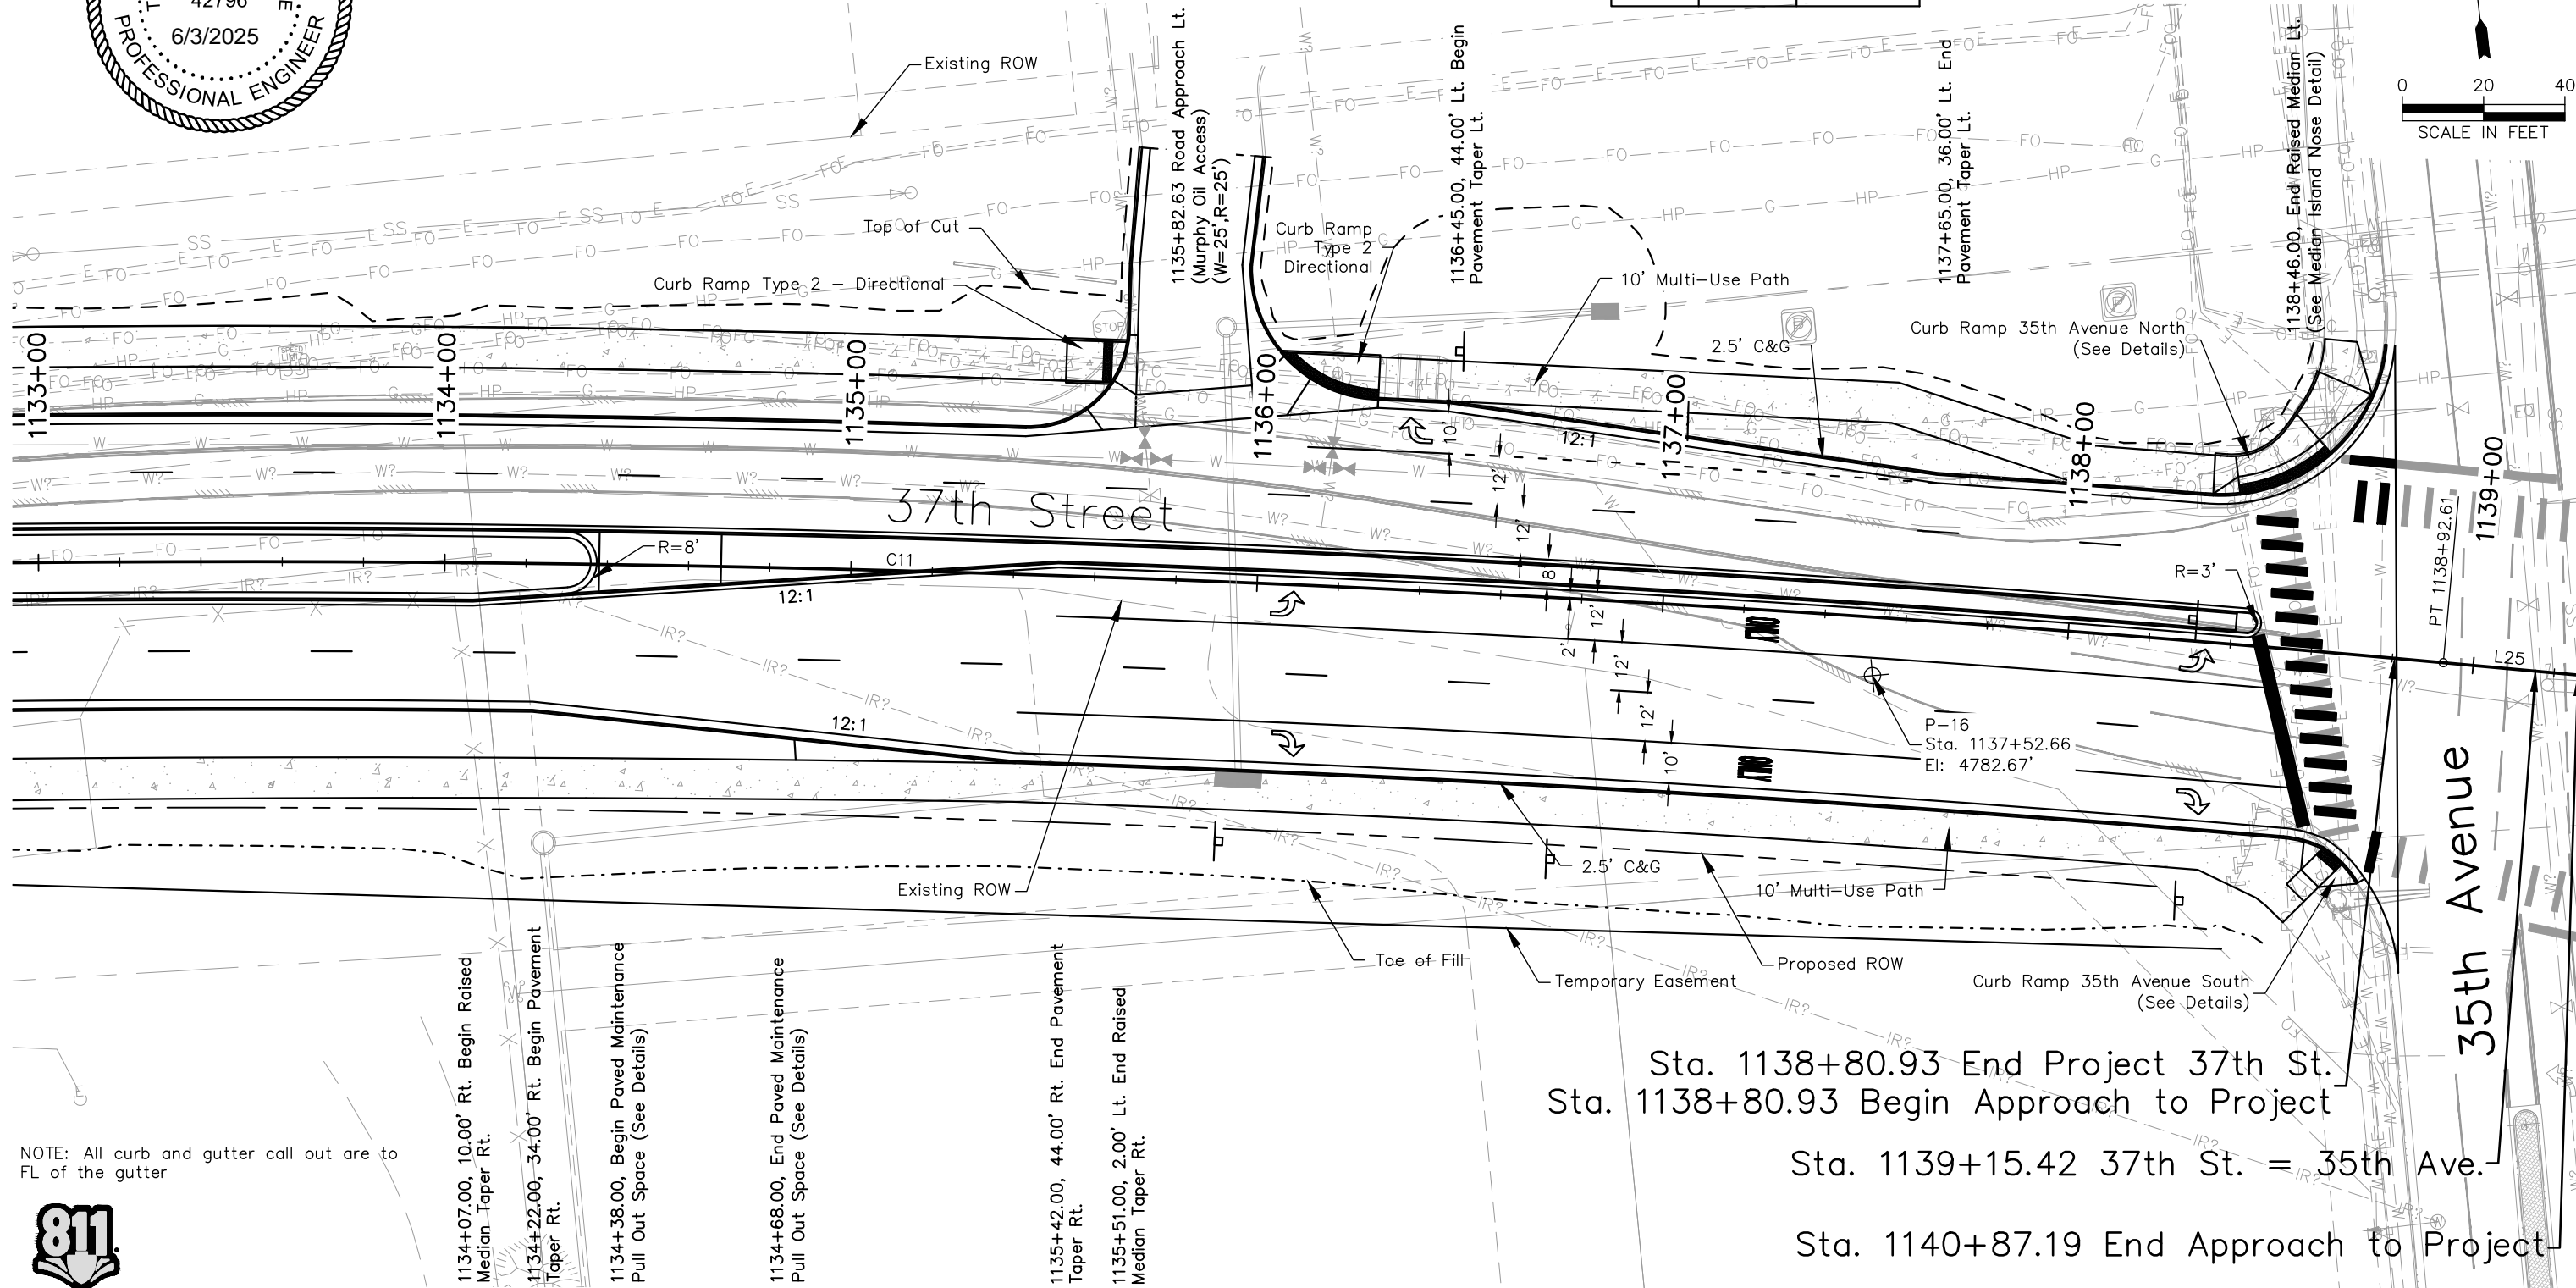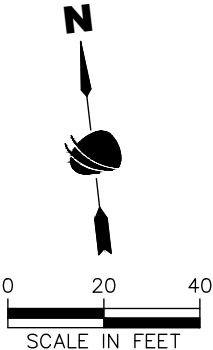

NOTE: All curb and gutter call out are to FL of the gutter



Sta. 1138+80.93 End Project 37th St.
Sta. 1138+80.93 Begin Approach to Project
Sta. 1139+15.42 37th St. = 35th Ave.
Sta. 1140+87.19 End Approach to Project

37TH STREET PLAN

Print Date: 5/2/2025


File Name: PLAN P2B-001 ROADWAY PLAN.DWG

Horiz. Scale: As Noted

Vert. Scale: N/A

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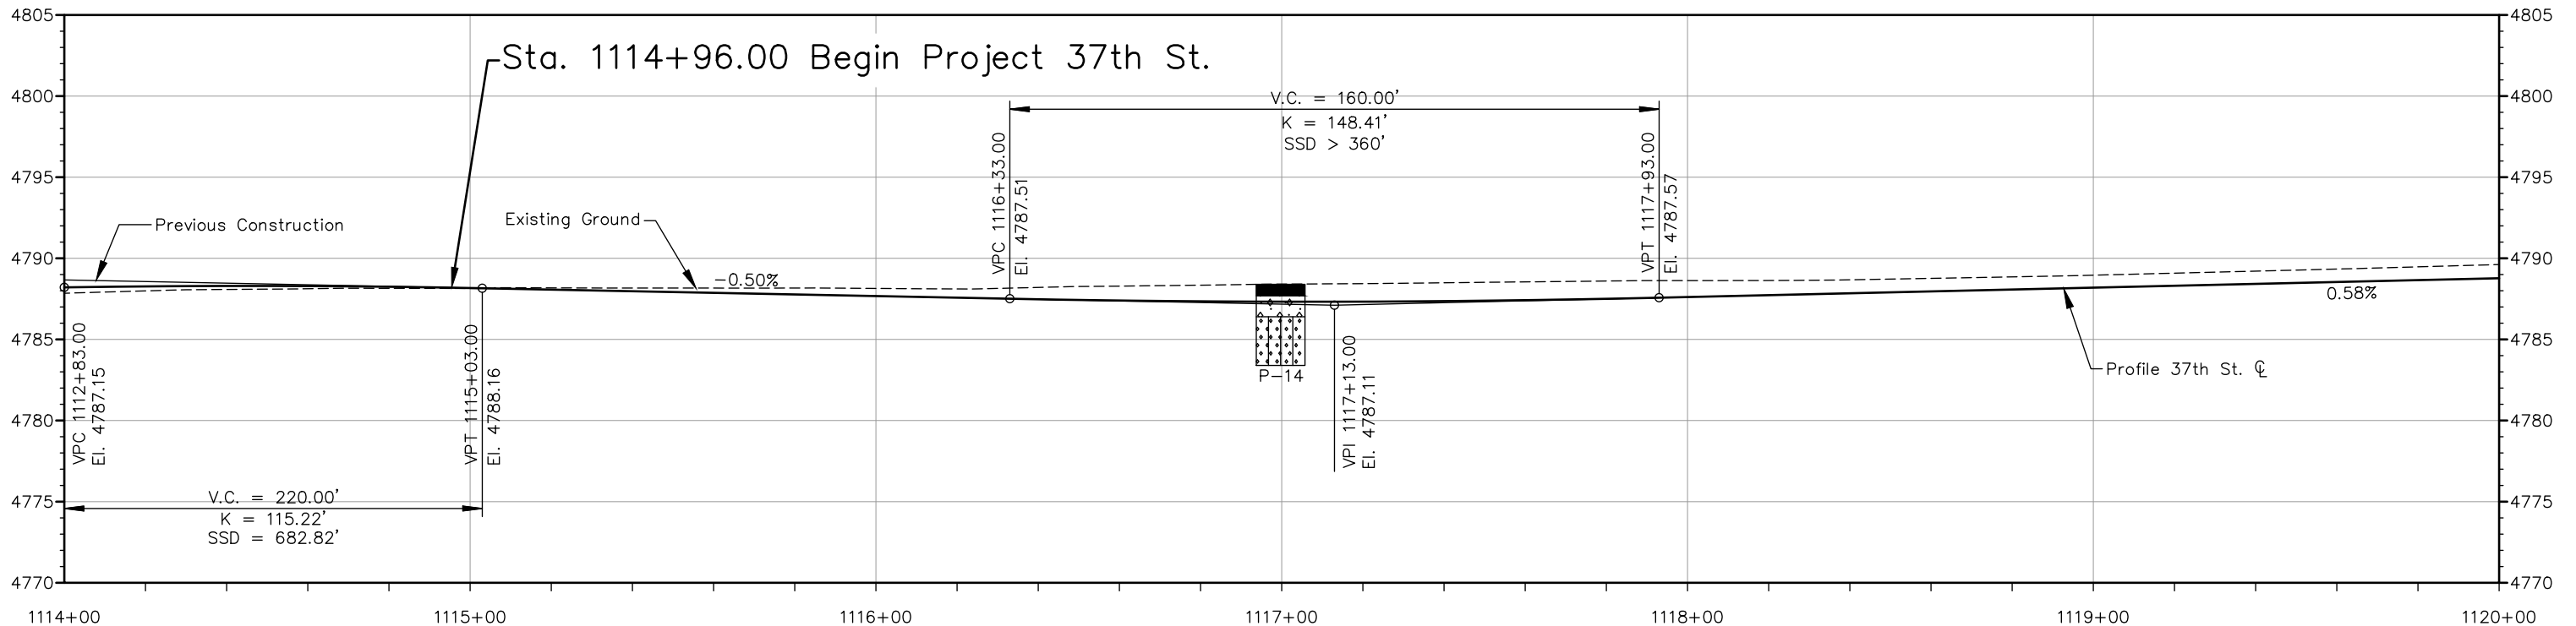
Sheet Revisions		
Date	Comments	Initials

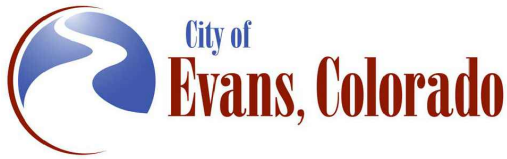



As Constructed	37TH STREET WIDENING PHASE 2B ROADWAY PLAN			Project No.
	No Revisions:	Designer: T. Tuttle	Structure Numbers	37TH STREET 2B
Revised:	Detailer: S. Hemler			Drawing Number PLAN-004
Void:	Sheet Subset: PLAN	Subset Sheets: 4 of 4		Sheet Number 40

FOR CONSTRUCTION 5/1/2025


Plot Date: 5/2/2025 6:41 AM Plotted By: Sarah Hemler
C:\Q-PROJECTS\37TH STREET WIDENING\37TH ST AND 47TH AVE\PLAN\2025\COMPUTER DESIGN FILES\PR P2B-001 ROADWAY PROFILE.DWG



37TH STREET PROFILE

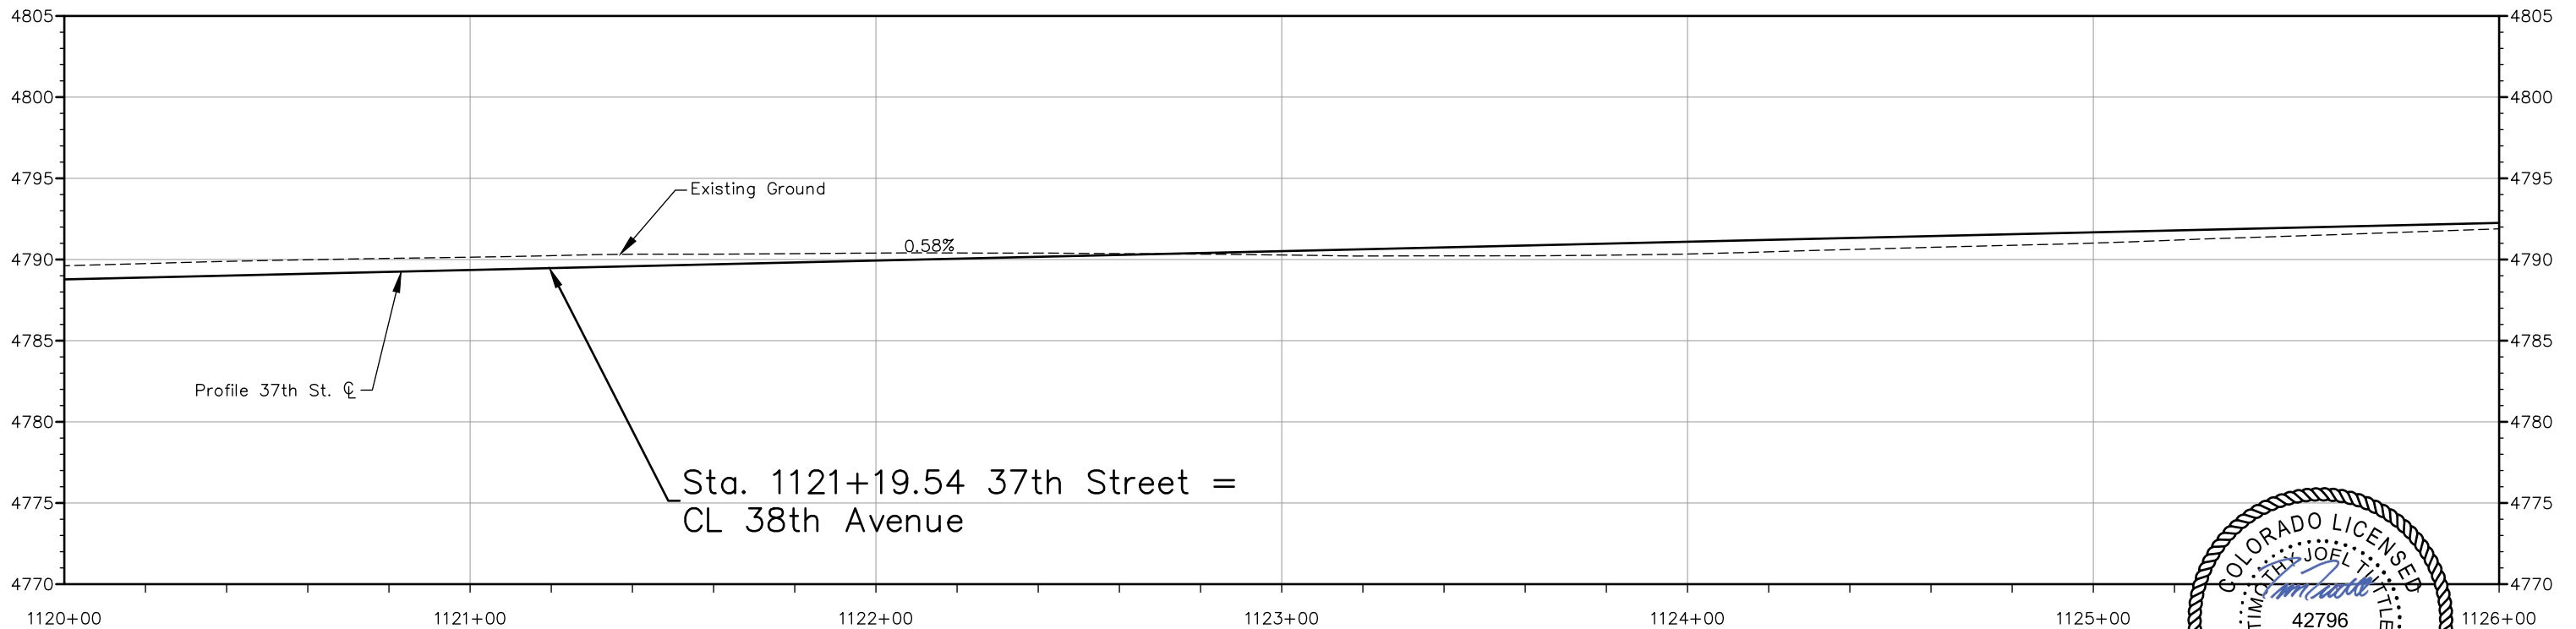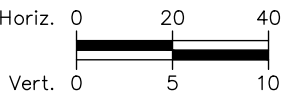

37TH STREET PROFILE

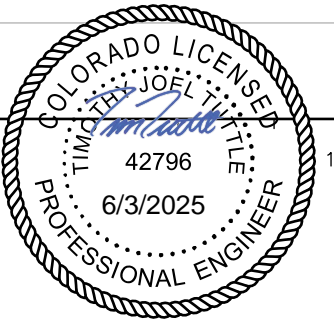

LITHOLOGY

- Asphalt Pavement
- Native - SAND, silty
- Fill - SAND, clayey to silty

Plot Date: 5/2/2025 6:41 AM Plotted By: Sarah Hemler
C:\Q-PROJECTS\37TH STREET WIDENING\37TH ST AND 47TH AVE\PLAN\2025\COMPUTER DESIGN FILES\PR P2B-001 ROADWAY PROFILE.DWG

Print Date: 5/2/2025


File Name: PR P2B-001 ROADWAY PROFILE.DWG

Horiz. Scale: As Noted Vert. Scale: As Noted

RockSol Consulting Group, Inc.


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Sheet Revisions		
Date	Comments	Initials


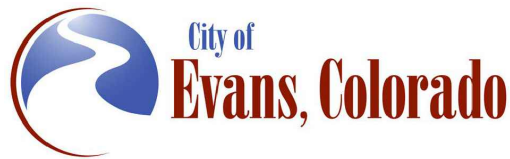


As Constructed	37TH STREET WIDENING PHASE 2B ROADWAY PROFILE			Project No.
	No Revisions:			37TH STREET 2B
Revised:	Designer: T. Tuttle	Structure Numbers		Drawing Number PR-001
Void:	Detailer: S. Hemler			
Sheet Subset: PROFILE		Subset Sheets: 1 of 3	Sheet Number 41	

FOR CONSTRUCTION 5/1/2025

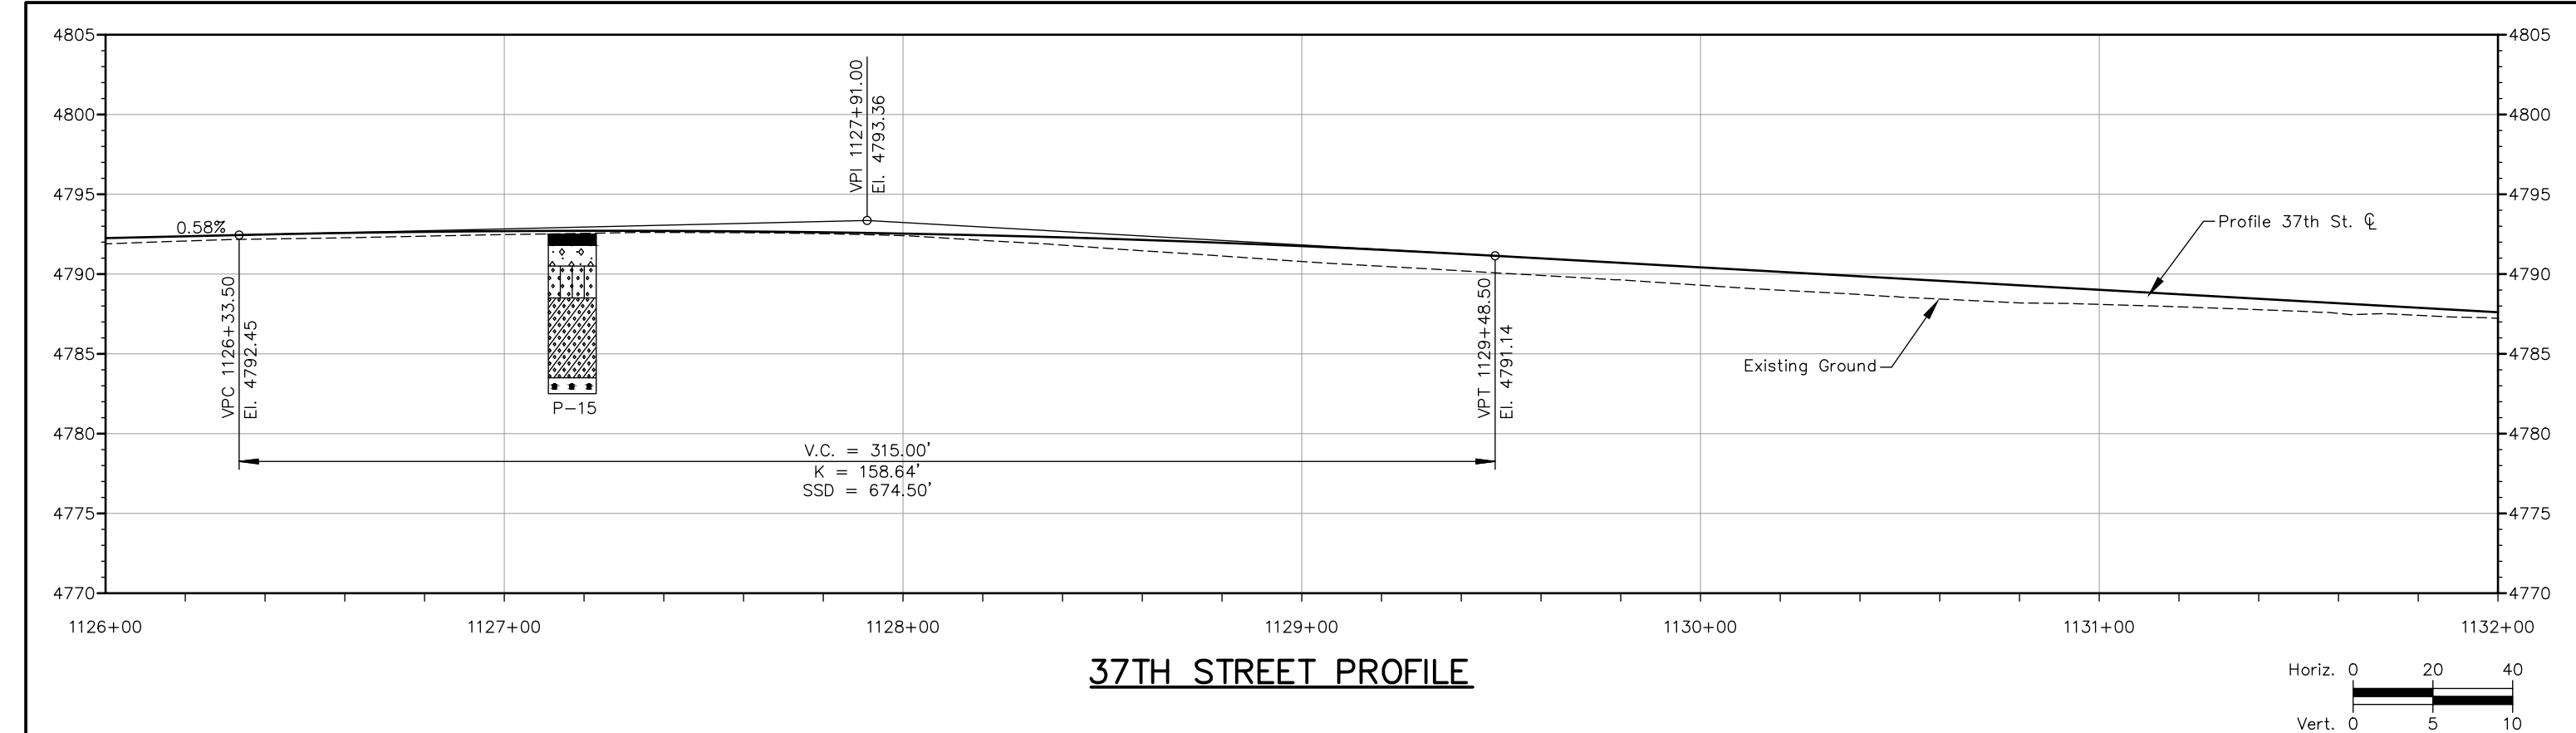

37TH STREET PROFILE

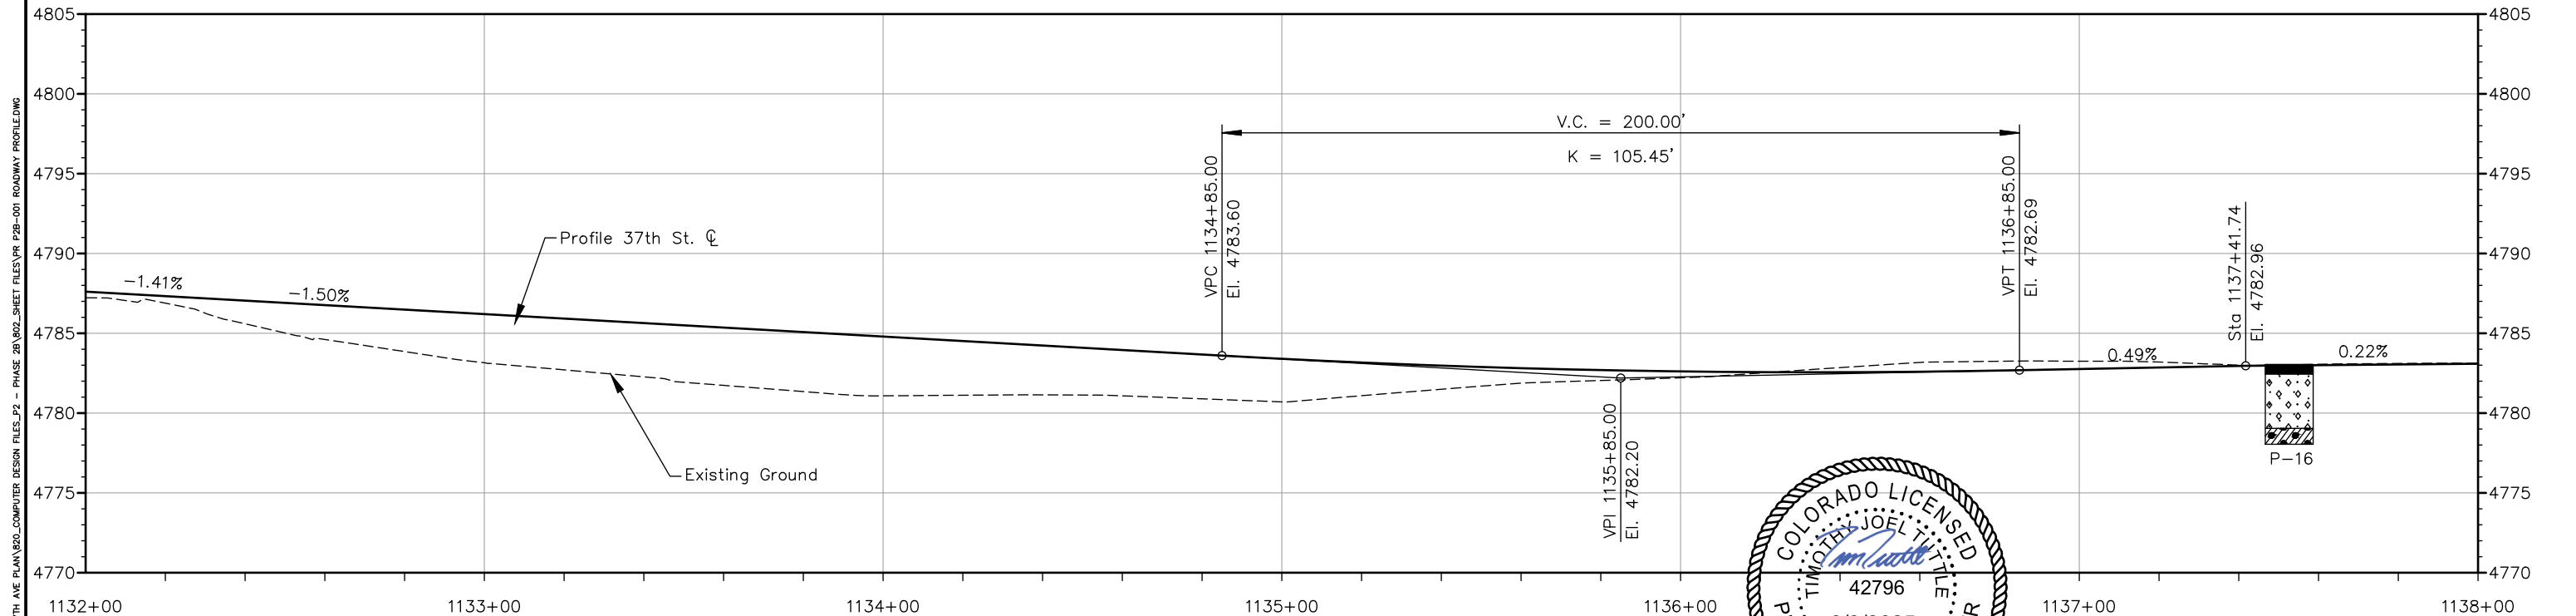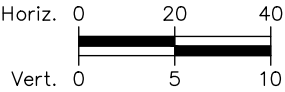

37TH STREET PROFILE



- LITHOLOGY**
- Asphalt Pavement
 - Fill - SAND, clayey to silty
 - Bedrock - SANDSTONE
 - Native - SAND, silty
 - Native - CLAY, sandy
 - Native - SAND, clayey


Print Date: 5/2/2025

File Name: PR P2B-001 ROADWAY PROFILE.DWG



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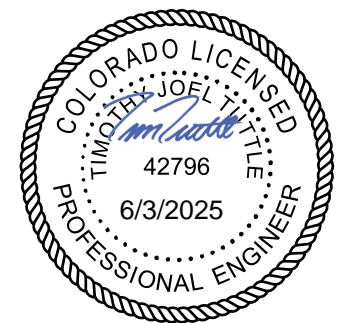
Sheet Revisions		
Date	Comments	Initials



As Constructed	37TH STREET WIDENING PHASE 2B ROADWAY PROFILE			Project No.
	No Revisions:	Designer: T. Tuttle	Structure Numbers	37TH STREET 2B
Revised:	Detailer: S. Hemler			Drawing Number PR-002
Void:	Sheet Subset: PROFILE	Subset Sheets: 2 of 3	Sheet Number 42	

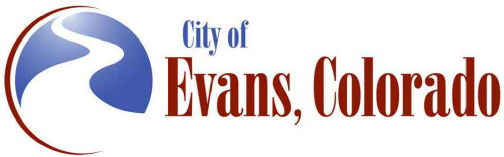


37TH STREET PROFILE

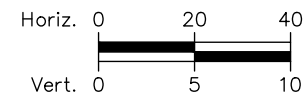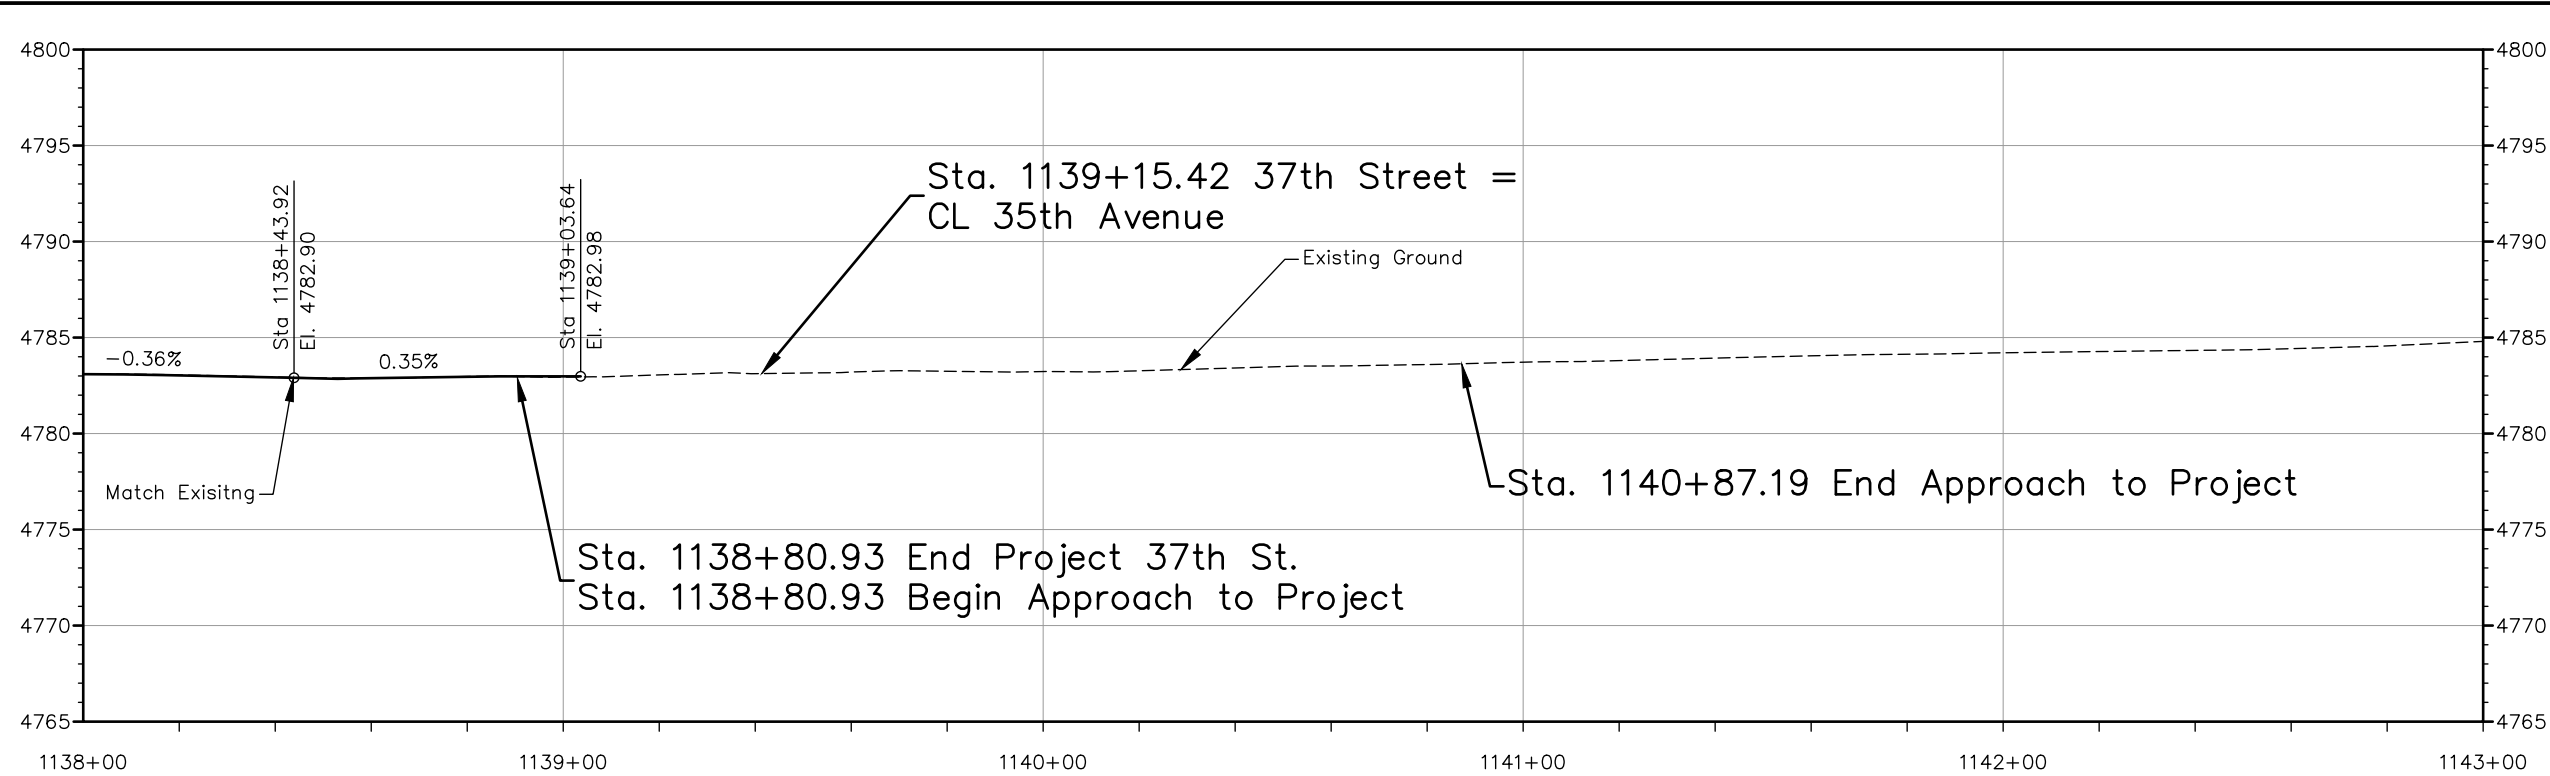

Print Date: 5/2/2025


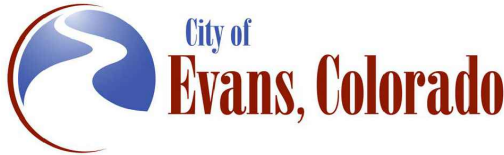
File Name: PR P2B-001 ROADWAY PROFILE.DWG

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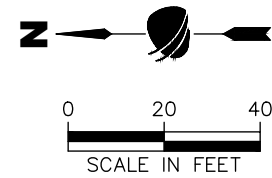
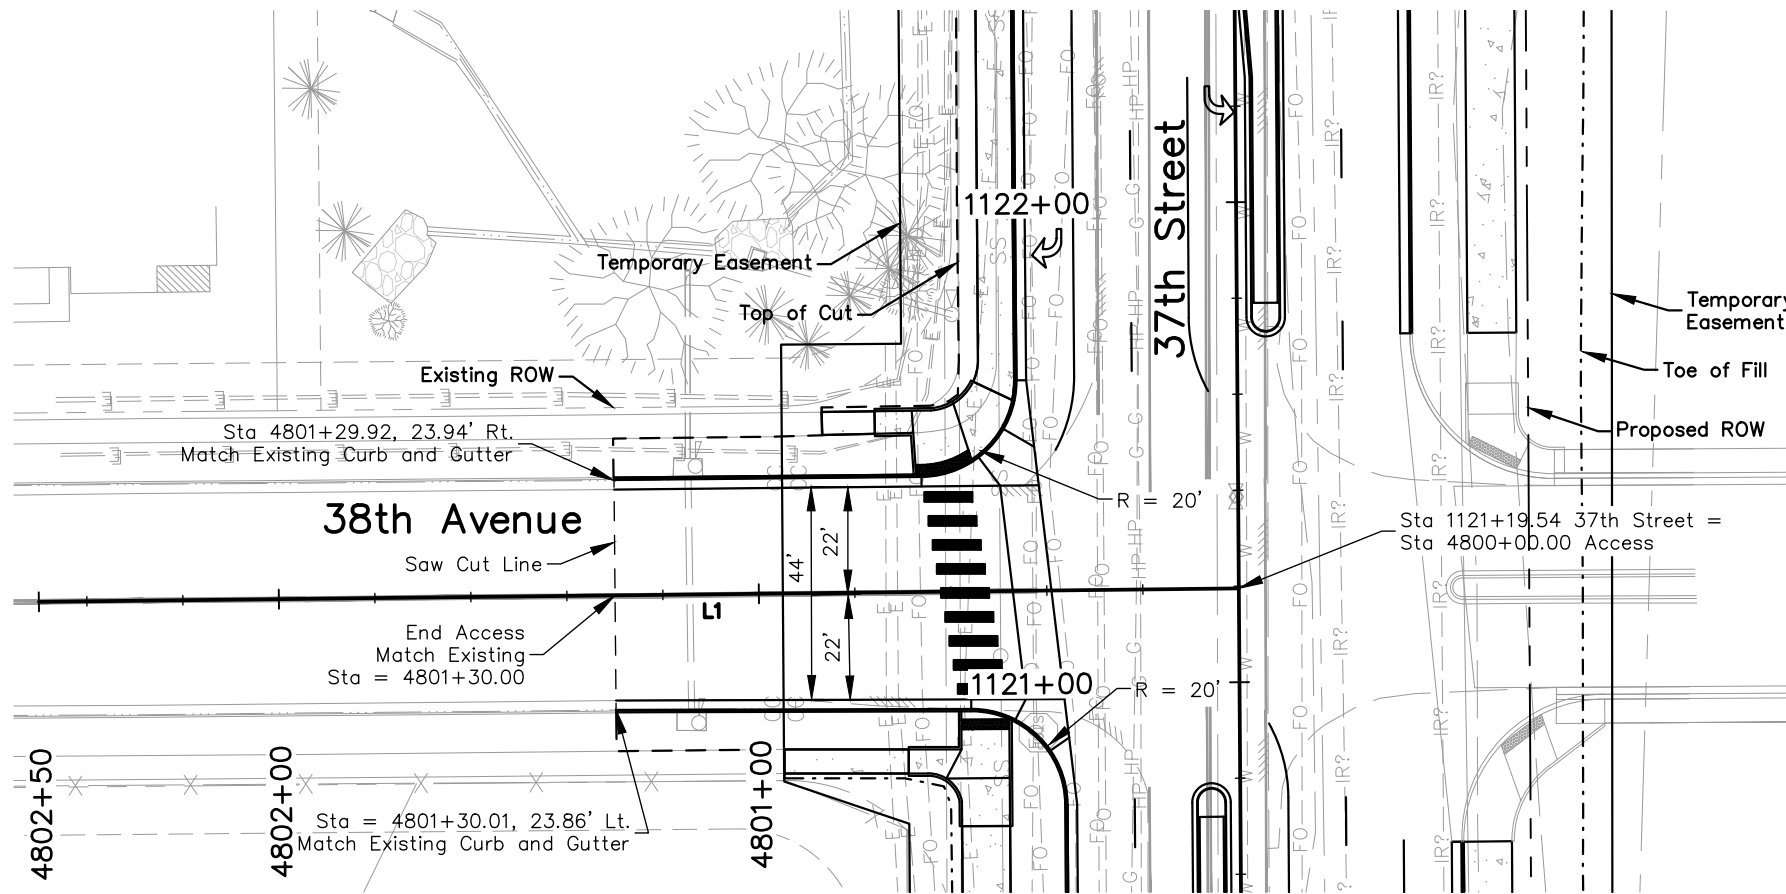
Sheet Revisions		
Date	Comments	Initials



As Constructed	37TH STREET WIDENING PHASE 2B ROADWAY PROFILE			Project No.
No Revisions:				37TH STREET 2B
Revised:	Designer: T. Tuttle	Structure Numbers		Drawing Number PR-003
Void:	Detailer: S. Hemler	Sheet Subset: PROFILE	Subset Sheets: 3 of 3	Sheet Number 43

Plot Date: 5/2/2025 6:41 AM Plotted By: Sarah Hemler
C:\G-PROJECTS\37TH STREET WIDENING PHASE 2B\001 SHEET FILES\PR P2B-001 ROADWAY PROFILE.DWG

FOR CONSTRUCTION 5/1/2025



ROAD APPROACH (38th Avenue)
1121+19.54 LT.
(W = 44', R = 20')

Notes:



1. All curb and gutter callouts are to flowline of the gutter. See Details for Curb Ramp 38th Avenue West and East.
2. Sta 1121+19.54 37th Street = Sta 4800+0000 Access

ALIGNMENT BEGIN			
Line #	Station	Northing	Easting
L1	4800+00.00	1381792.61	3212221.95

ALIGNMENT LINE TABLE		
Line #	Length	Direction
L1	250.00'	N0° 38' 28"W


ALIGNMENT END			
Line #	Station	Northing	Easting
L1	4802+50.00	1382042.59	3212219.16

PLAN VIEW ACCESS STA 1121+19.54 LT.

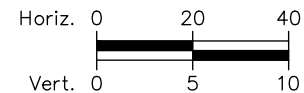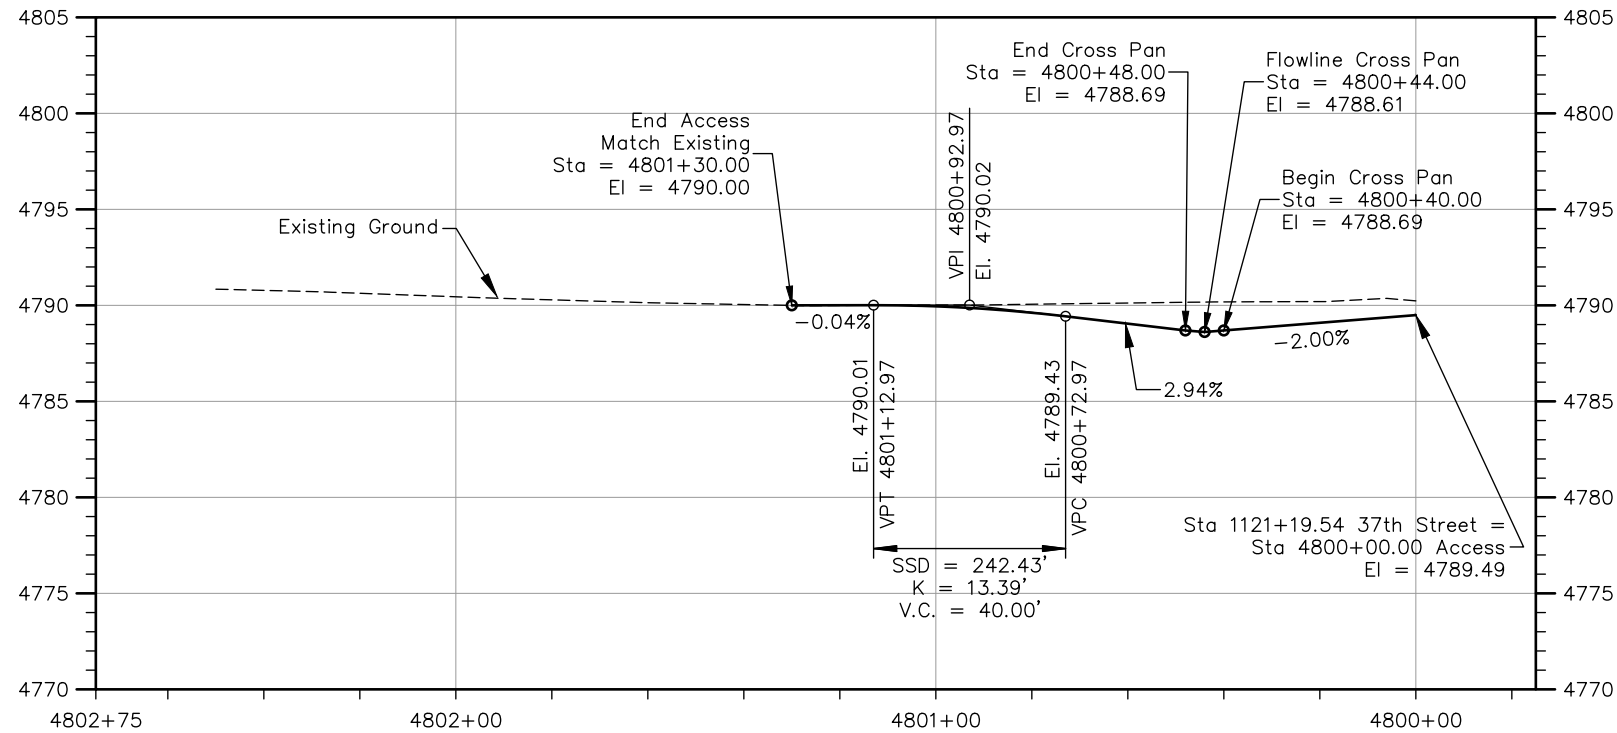

Street Approach Quantity Take Off

HMA (SX) (100) (PG 64-28): 45 TONS
HMA (S) (75) (PG 64-22): 90 TONS
Emulsified Asphalt (Slow-Setting): 41 GAL
Aggregate Base Course (Class 6): 108 CY
Concrete Sidewalk (6 Inch): 20 SY
Concrete Curb Ramp: 82 SY
Curb and Gutter Type 2 (Section II-B): 134 LF
Gutter Type 2 (8 Foot): 45 LF
Concrete Pavement (8 Inch): 22 SY

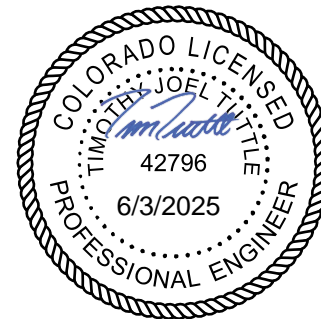


PROFILE VIEW ACCESS STA 1121+19.54 LT.

Print Date: 5/2/2025
File Name: RA P2B-001 ROAD APPROACH.DWG
Horiz. Scale: As Noted Vert. Scale: As Noted

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Sheet Revisions		
Date	Comments	Initials

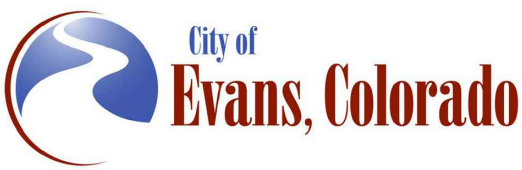


As Constructed		37TH STREET WIDENING PHASE 2B ROAD APPROACH 1121+19.54 LT.		Project No.
No Revisions:		Designer: T. Tuttle		37TH STREET 2B
Revised:		Detailer: J. Jensen	Structure Numbers	Drawing Number RA-001
Void:		Sheet Subset: APPROACH	Subset Sheets: 1 of 6	Sheet Number 44


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FOR CONSTRUCTION 5/1/2025


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PLAN VIEW ACCESS STA 1124+67.77 RT.

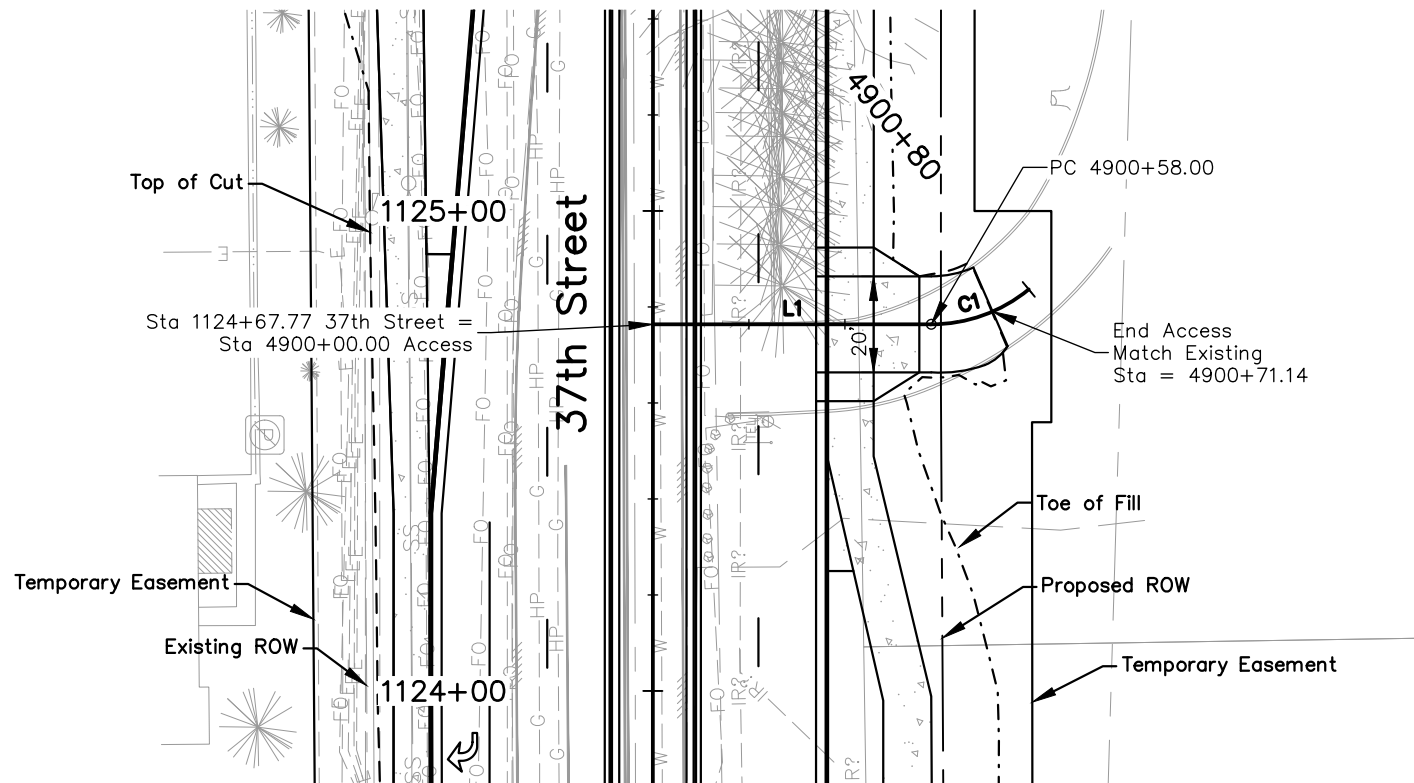

PROFILE VIEW ACCESS STA 1124+67.77 RT.

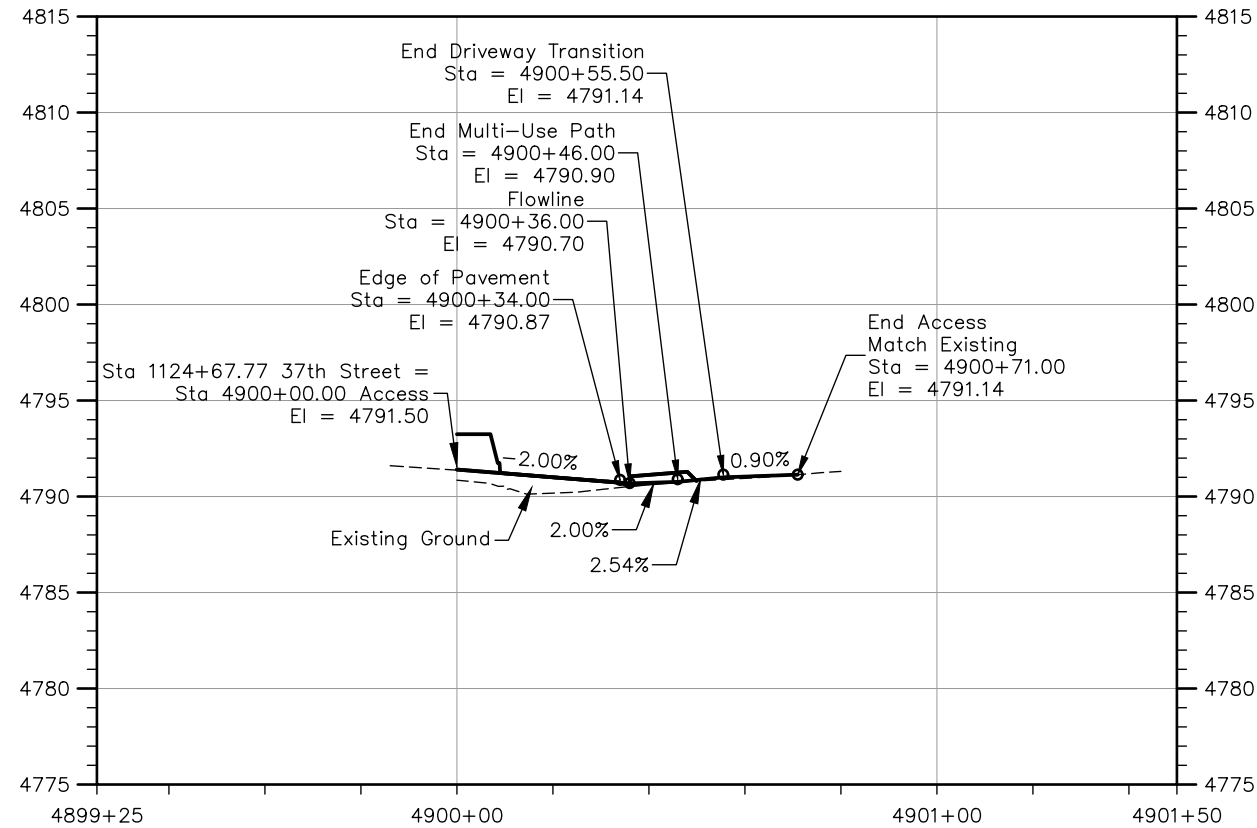


ROAD APPROACH (Residential-Driveway)
1124+67.77 RT.
(W = 20')

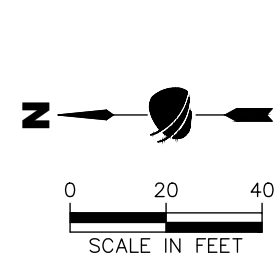ALIGNMENT BEGIN			
Line #	Station	Northing	Easting
L1	4900+00.00	1381794.14	3212578.79

ALIGNMENT LINE TABLE		
Line #	Length	Direction
L1	58.00'	S0° 00' 12"W

ALIGNMENT CURVE TABLE								
Curve #	PC Sta.	PI Sta.	PT Sta.	Delta	L	R	T	Dc
C1	4900+58.00	4900+69.45	4900+80.00	039°26'49"	22.00'	31.96'	11.46'	179.28

ALIGNMENT END								
Curve #	PC Sta.	PI Sta.	PT Sta.	Delta	L	R	T	Dc
C1	4900+58.00	4900+69.45	4900+80.00	039°26'49"	22.00'	31.96'	11.46'	179.28

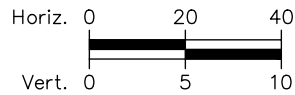

Concrete Driveway Quantity Take Off

- Aggregate Base Course (Class 6): 4 CY
- Concrete Sidewalk (8 Inch): 34 SY
- Concrete Pavement (8 Inch): 27 SY



Print Date: 5/2/2025

File Name: RA P2B-001 ROAD APPROACH.DWG

Horiz. Scale: As Noted Vert. Scale: As Noted



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Sheet Revisions		
Date	Comments	Initials




City of
Evans, Colorado




FREEDOM
Parkway

As Constructed	37TH STREET WIDENING PHASE 2B ROAD APPROACH 1124+67.77 RT.		Project No.
	No Revisions:		37TH STREET 2B
Revised:	Designer: T. Tuttle	Structure Numbers	Drawing Number RA-002
Void:	Detailer: J. Jensen		
	Sheet Subset: APPROACH	Subset Sheets: 2 of 6	Sheet Number 45

Plot Date: 5/2/2025 6:42 AM Plotted By: Sarah Hemler
C:\Q-PROJECTS\YVETTE PROJECTS\33001\EVANS 37TH ST AND 47TH AVE PLAN\2020 COMPUTER DESIGN FILES\P2 - PHASE 2B\802 SHEET FILES\RA P2B-001 ROAD APPROACH.DWG

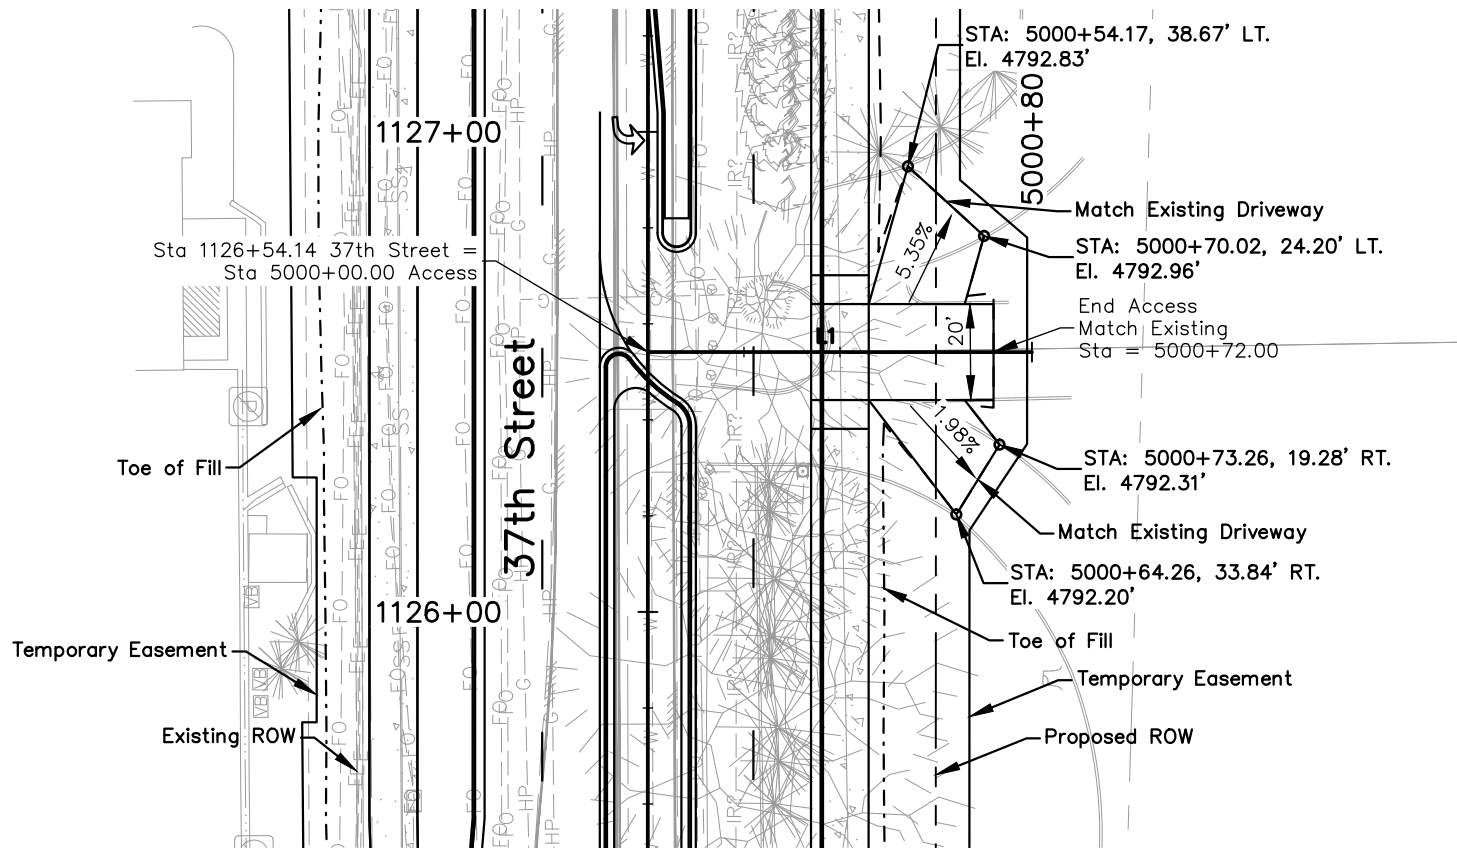

PLAN VIEW ACCESS STA 1126+54.14 RT.

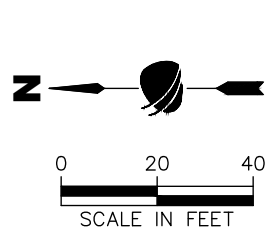


ROAD APPROACH (Residential-Driveway)
1126+54.14 RT.
(W = 20')


ALIGNMENT BEGIN			
Line #	Station	Northing	Easting
L1	5000+00.00	1381794.10	3212756.55

ALIGNMENT LINE TABLE		
Line #	Length	Direction
L1	80.00'	S0° 00' 46"W

ALIGNMENT END			
Line #	Station	Northing	Easting
L1	5000+80.00	1381714.10	3212756.53

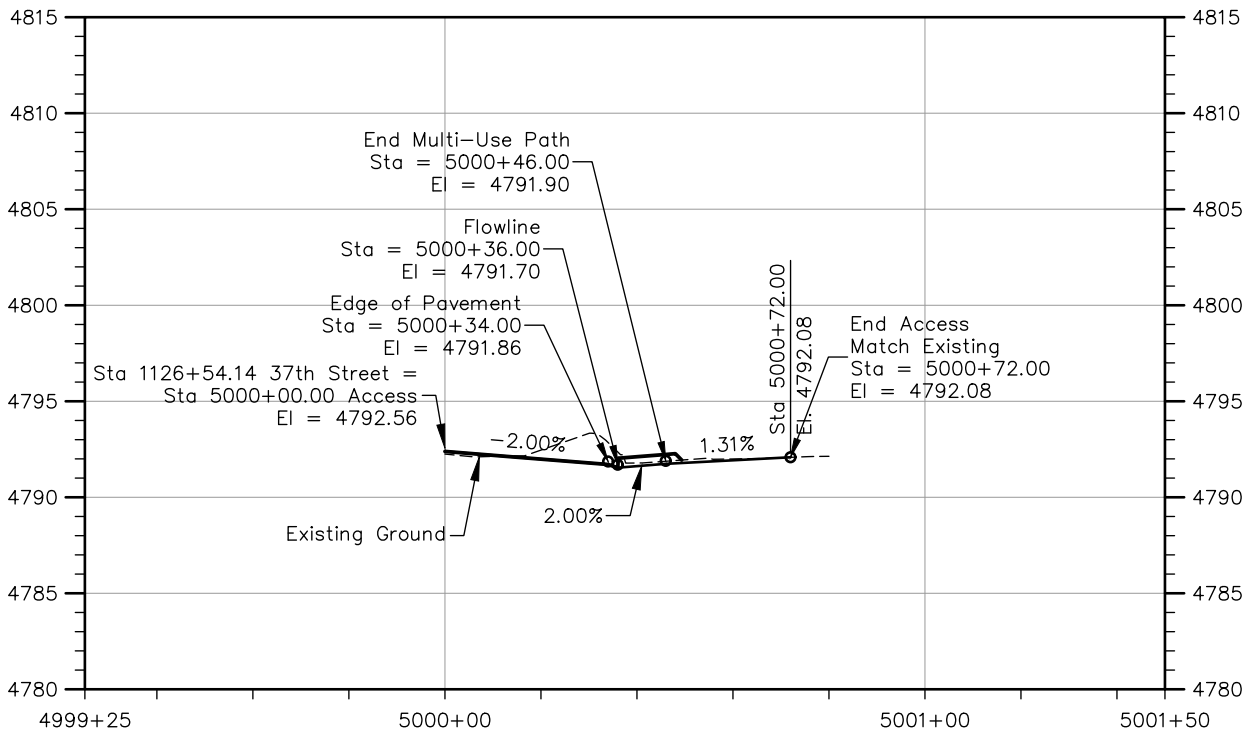

PROFILE VIEW ACCESS STA 1126+54.14 RT.

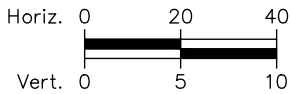

Concrete Driveway Quantity Take Off


Aggregate Base Course (Class 6): 16 CY

Concrete Sidewalk (8 Inch): 34 SY



Print Date: 5/2/2025	
File Name: RA P2B-001 ROAD APPROACH.DWG	
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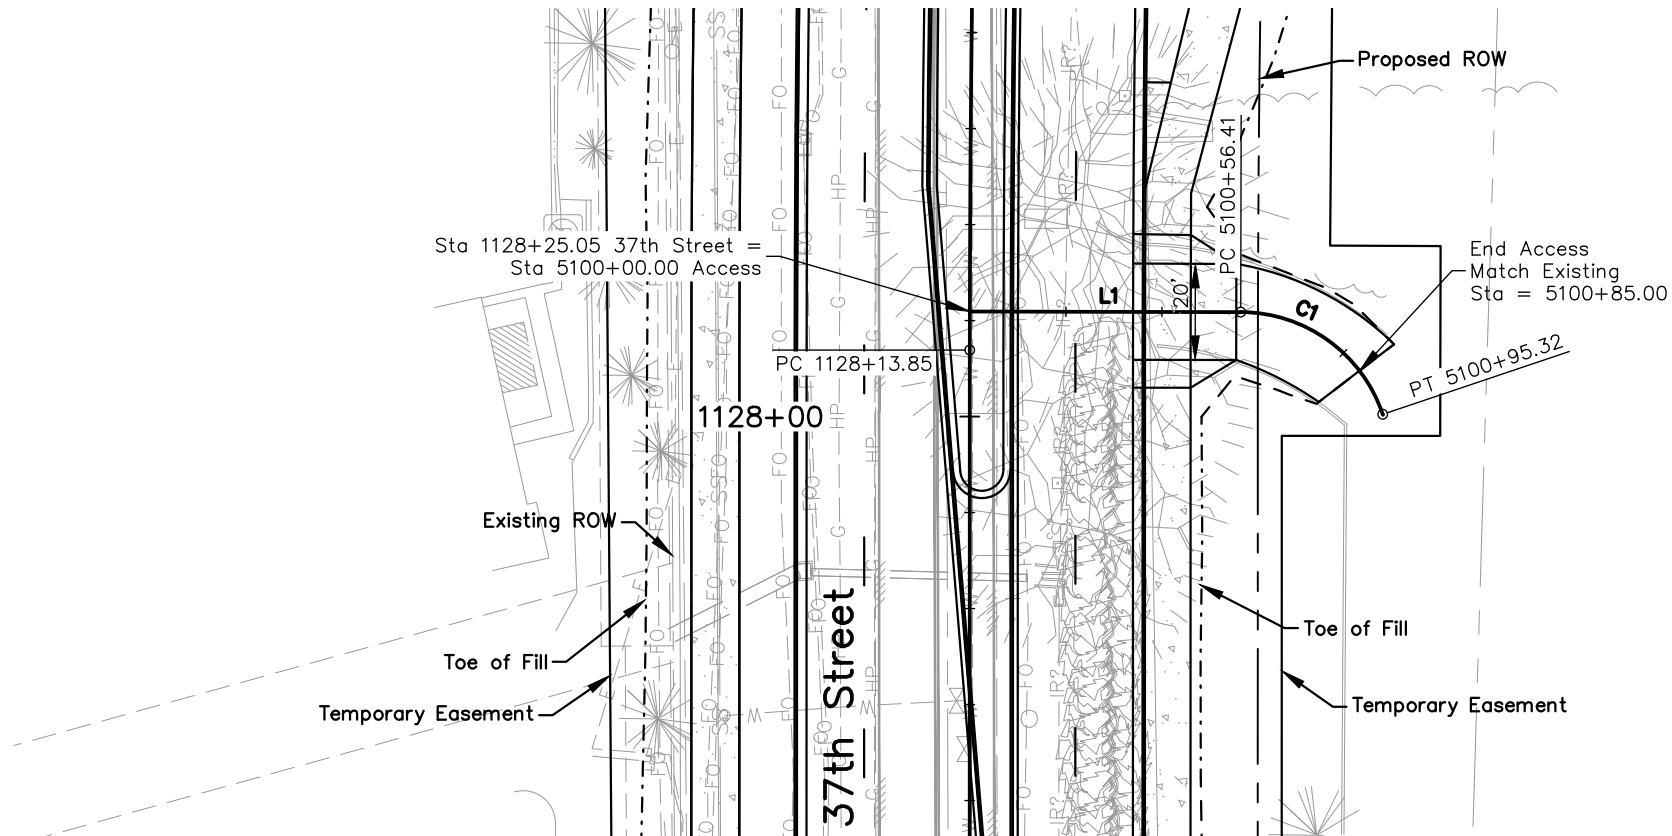
Sheet Revisions		
Date	Comments	Initials

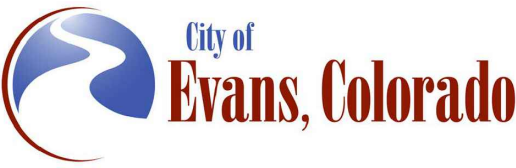


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	No Revisions:		37TH STREET 2B
Revised:	Designer: T. Tuttle	Structure Numbers	Drawing Number RA-003
Void:	Detailer: J. Jensen		
	Sheet Subset: APPROACH	Subset Sheets: 3 of 6	Sheet Number 46

FOR CONSTRUCTION 5/1/2025

Plot Date: 5/2/2025 6:43 AM Plotted By: Sarah Hemler
C:\Q-PROJECS\YARINE PROJECTS\33001 LEVANS 37TH ST AND 47TH AVE PLAN\202 COMPUTER DESIGN FILES\P2 - PHASE 2B\202 SHEET FILES\RA P2B-001 ROAD APPROACH.DWG



PLAN VIEW ACCESS STA 1128+25.05 RT.

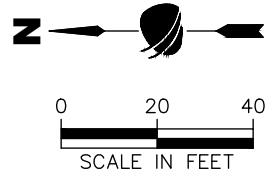



ROAD APPROACH (Residential-Driveway)
1128+25.05 RT.
(W = 20')

ALIGNMENT BEGIN			
Line #	Station	Northing	Easting
L1	5100+00.00	1381794.04	3212924.30

ALIGNMENT CURVE TABLE								
Curve #	PC Sta.	PI Sta.	PT Sta.	Delta	L	R	T	Dc
C1	5100+56.41	5100+78.83	5100+95.32	071°15'11"	38.91'	31.29'	22.42'	183.14

ALIGNMENT LINE TABLE		
Line #	Length	Direction
L1	56.41'	S0° 07' 42"W

ALIGNMENT END			
Curve #	Station	Northing	Easting
C1	5100+95.32	1381708.05	3212902.88

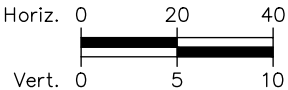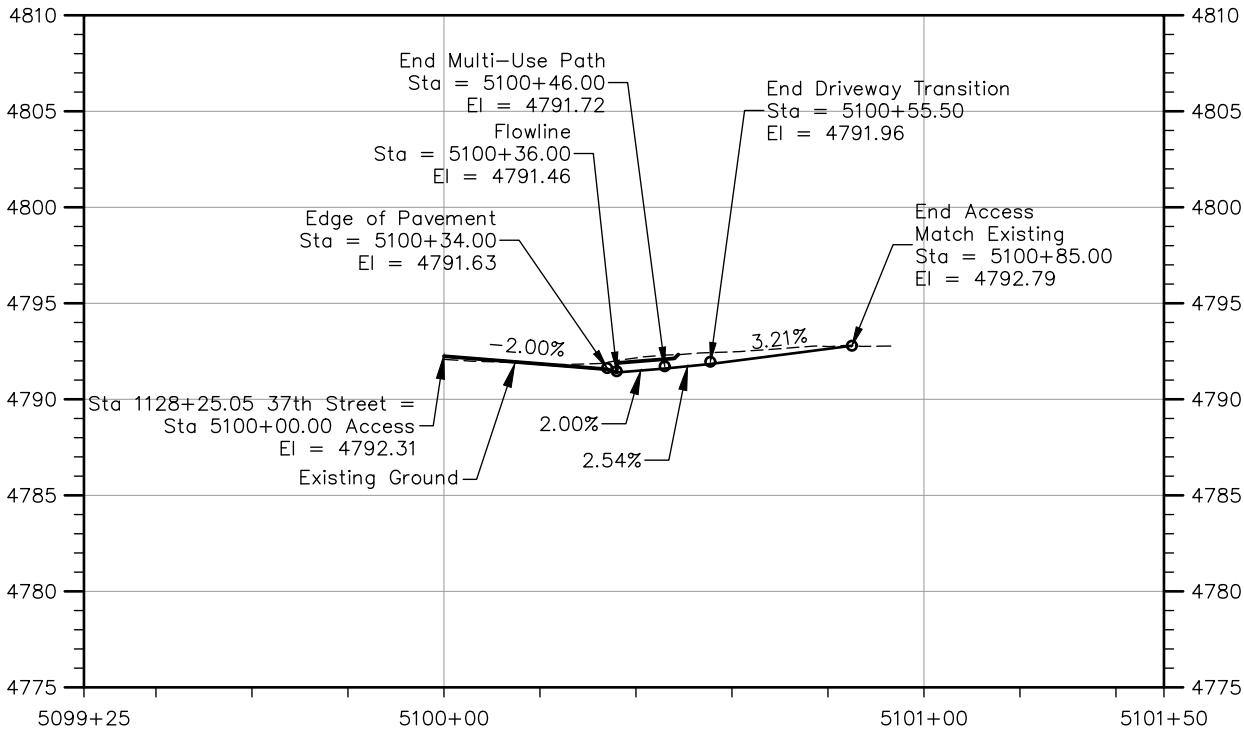

Concrete Driveway Quantity Take Off


Aggregate Base Course (Class 6): 7 CY
Concrete Sidewalk (8 Inch): 34 SY
Concrete Pavement (8 Inch): 27 SY



PROFILE VIEW ACCESS STA 1128+25.05 RT.


Print Date: 5/2/2025	
File Name: RA P2B-001 ROAD APPROACH.DWG	
Horiz. Scale: As Noted	Vert. Scale: As Noted
	12076 Grant Street Thornton, CO 80241 Ph: (303) 962-9300 Fax: (303) 962-9350

Sheet Revisions		
Date	Comments	Initials

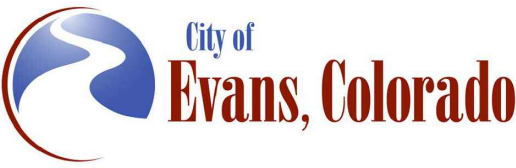


As Constructed	37TH STREET WIDENING PHASE 2B ROAD APPROACH 1128+25.05 RT.		Project No.
	No Revisions:		37TH STREET 2B
Revised:	Designer: T. Tuttle	Structure Numbers	Drawing Number RA-004
Void:	Detailer: J. Jensen		
	Sheet Subset: APPROACH	Subset Sheets: 4 of 6	Sheet Number 47

FOR CONSTRUCTION 5/1/2025

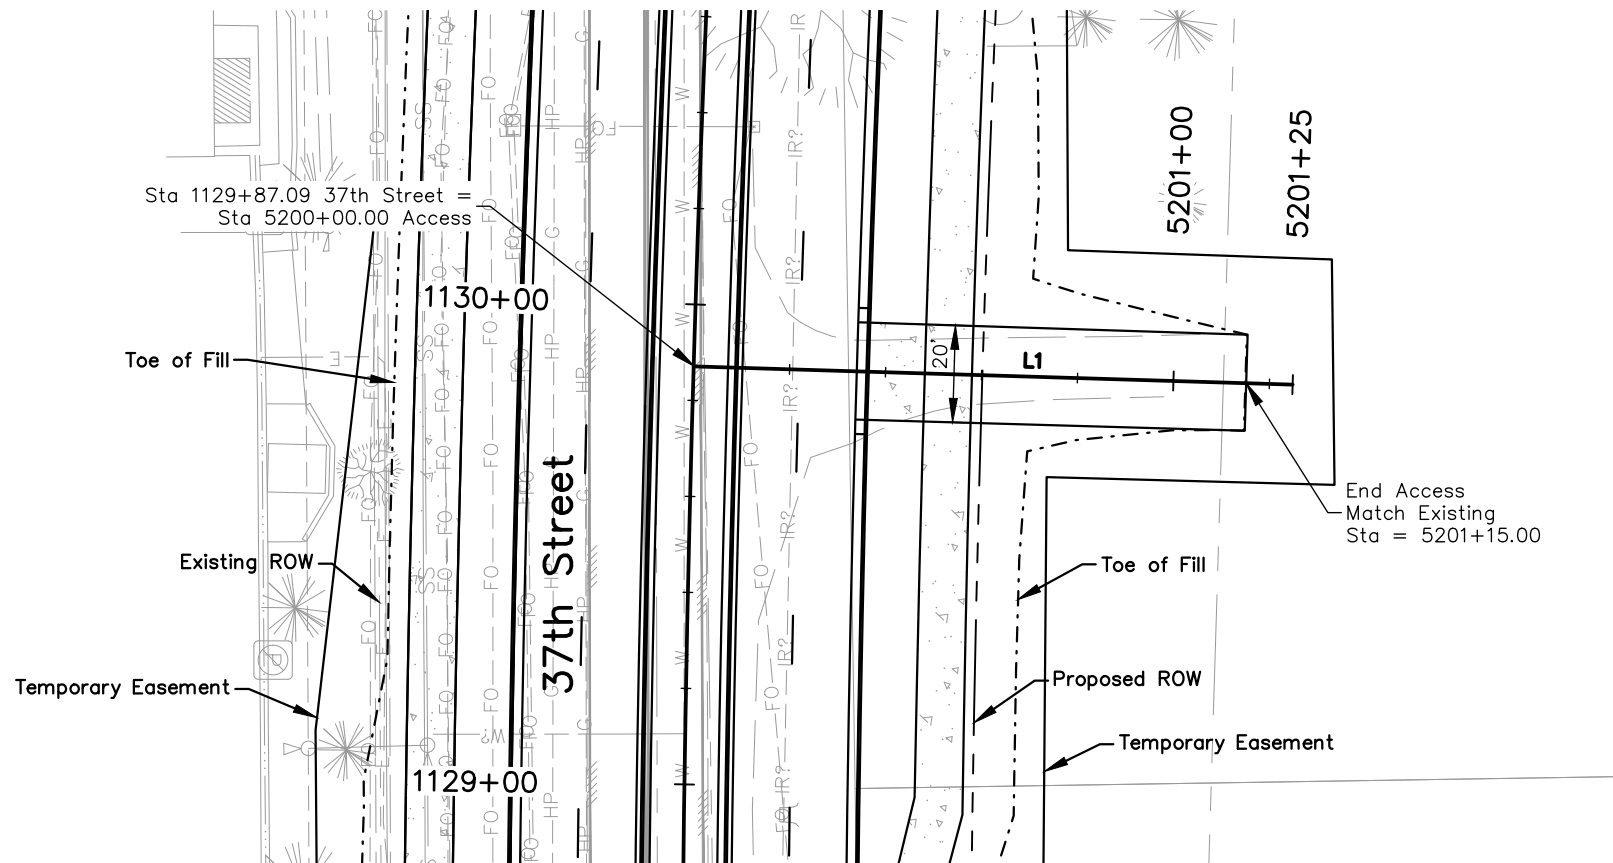

PLAN VIEW ACCESS STA 1129+87.09 RT.


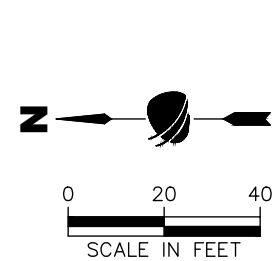


ROAD APPROACH (Field)
1129+87.09 RT.
(W = 20')

ALIGNMENT BEGIN			
Line #	Station	Northing	Easting
L1	5200+00.00	1381791.50	3213089.47

ALIGNMENT LINE TABLE		
Line #	Length	Direction
L1	124.85'	S1° 44' 26"W

ALIGNMENT END			
Line #	Station	Northing	Easting
L1	5201+24.85	1381666.71	3213085.68

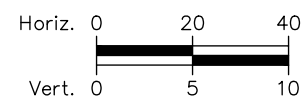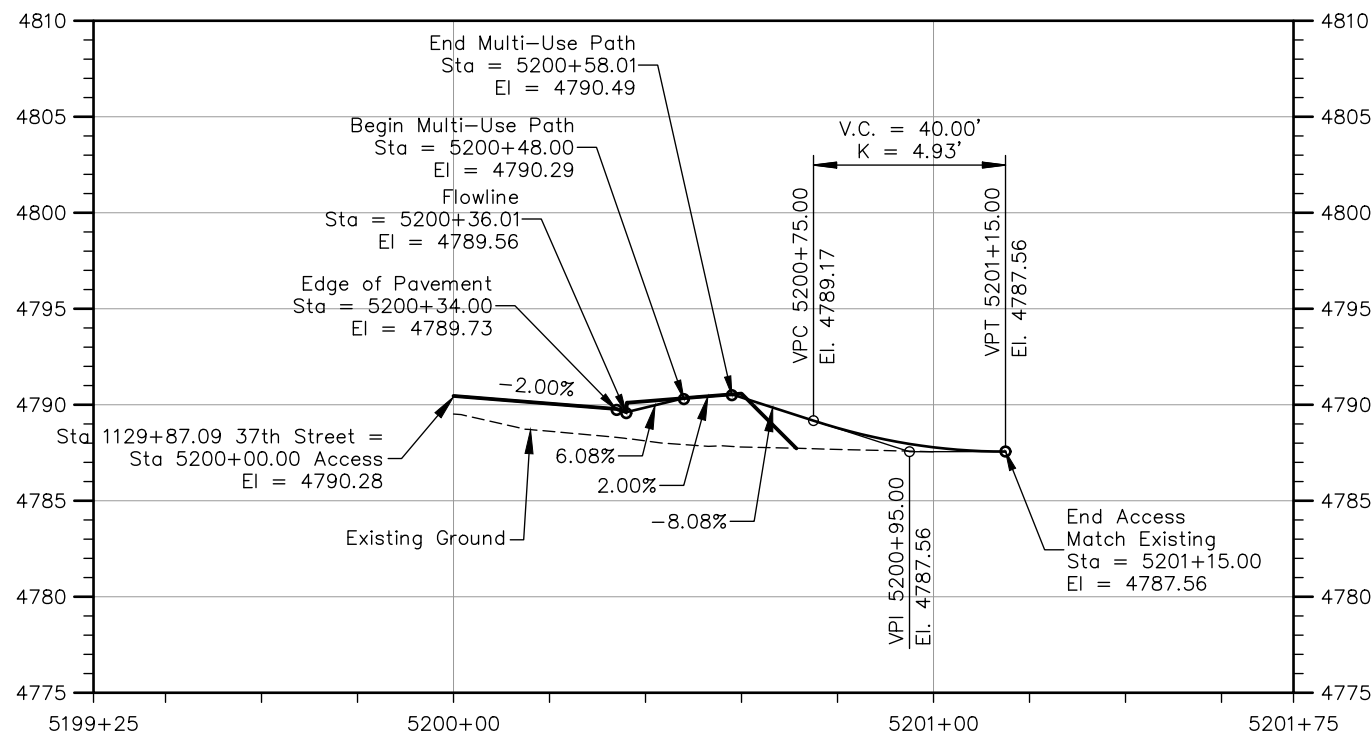


Concrete Driveway Quantity Take Off

Aggregate Base Course (Class 6): 14 CY

Concrete Sidewalk (8 Inch): 22 SY


Concrete Pavement (8 Inch): 26 SY

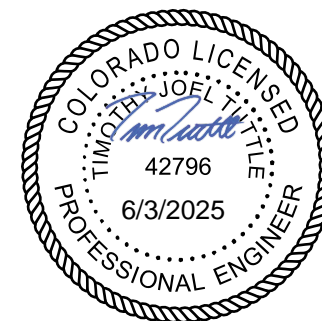

PROFILE VIEW ACCESS STA 1129+87.09 RT.

Print Date: 5/2/2025	
File Name: RA P2B-001 ROAD APPROACH.DWG	
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	Fax: (303) 962-9350


Sheet Revisions		
Date	Comments	Initials

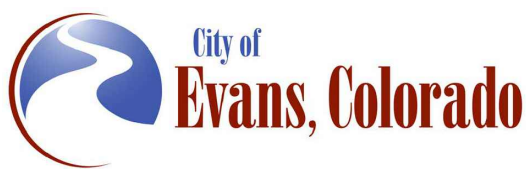


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	No Revisions:		37TH STREET 2B
Revised:	Designer: T. Tuttle	Structure Numbers	Drawing Number RA-005
Void:	Detailer: J. Jensen		
	Sheet Subset: APPROACH	Subset Sheets: 5 of 6	Sheet Number 48

Plot Date: 5/2/2025 6:43 AM Plotted By: Sarah Hemler
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FOR CONSTRUCTION 5/1/2025

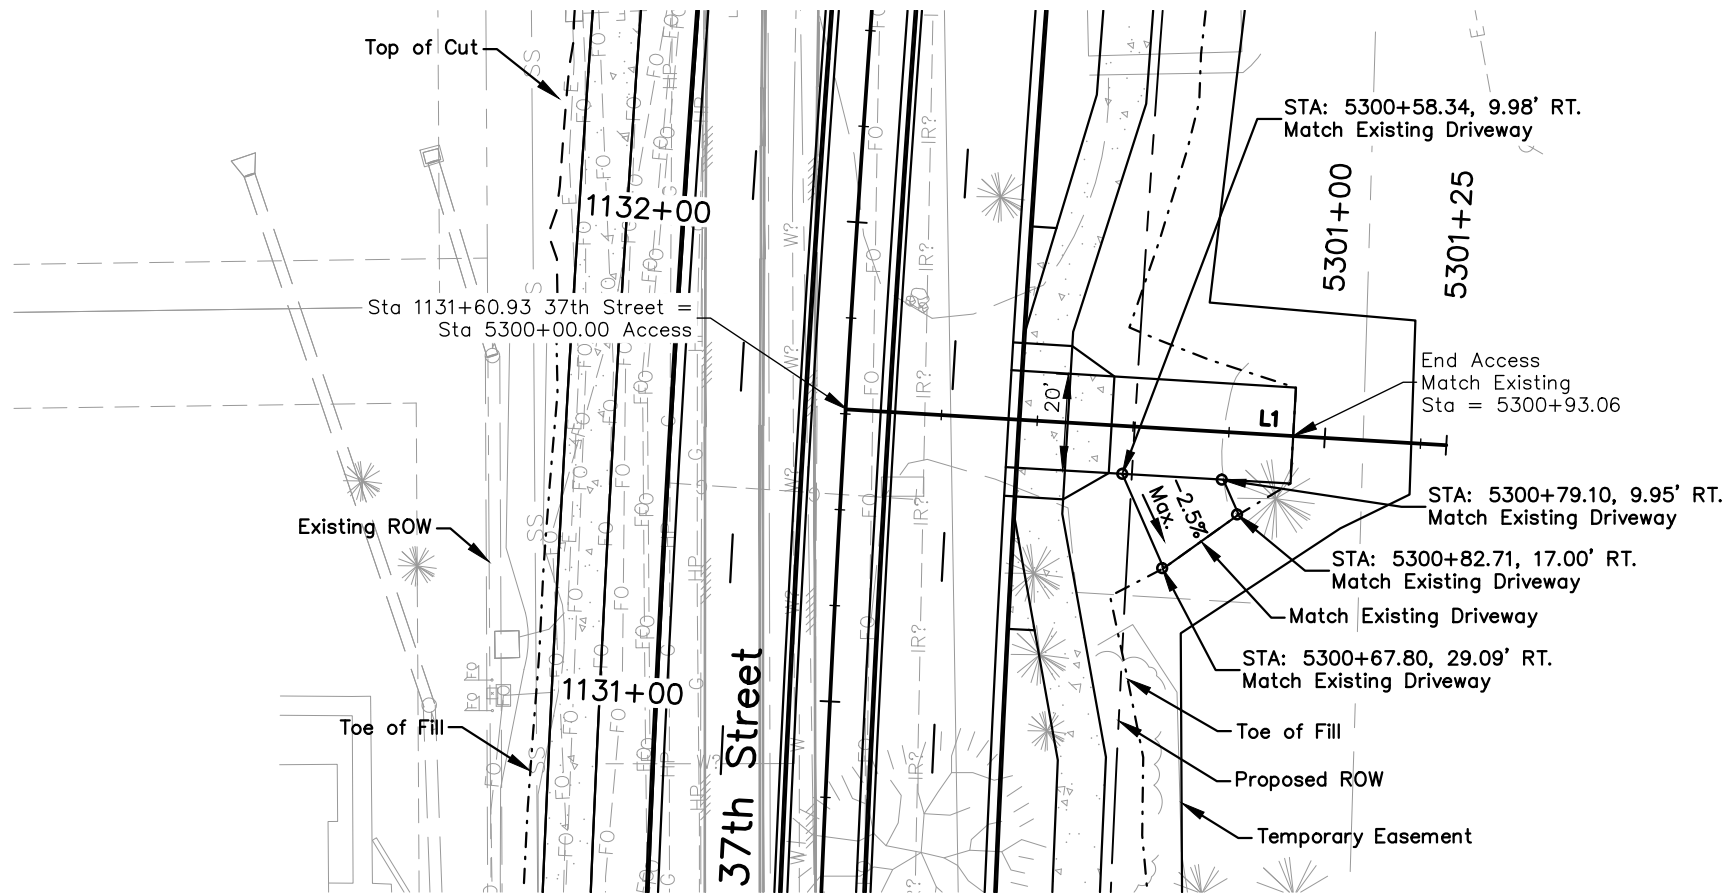

PLAN VIEW ACCESS STA 1131+60.93 RT.


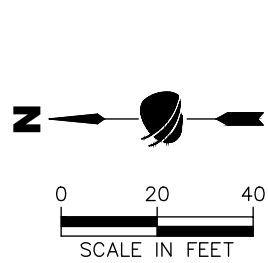


ROAD APPROACH (Residential-Driveway)
1131+60.93 RT.
(W = 20')

ALIGNMENT BEGIN			
Line #	Station	Northing	Easting
L1	5300+00.00	1381783.83	3213263.15

ALIGNMENT LINE TABLE		
Line #	Length	Direction
L1	125.36'	S3° 25' 08"W

ALIGNMENT END			
Line #	Station	Northing	Easting
L1	5301+25.36	1381658.69	3213255.67

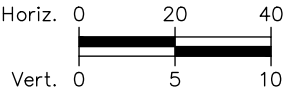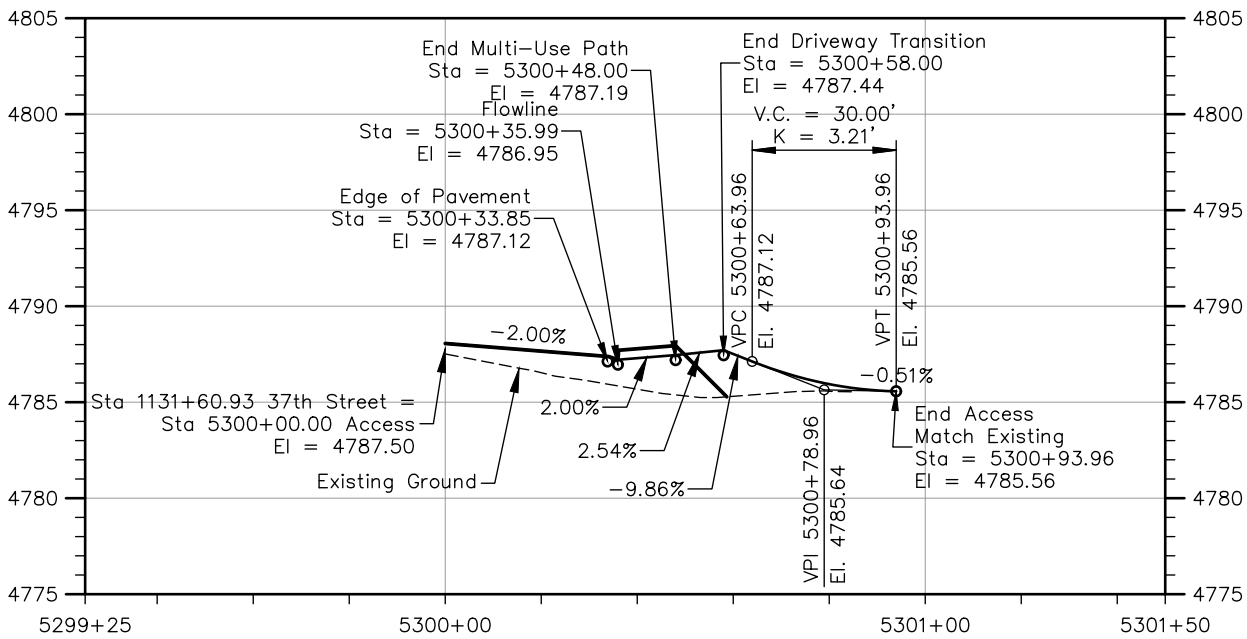

PROFILE VIEW ACCESS STA 1131+60.93 RT.

Concrete Driveway Quantity Take Off

- Aggregate Base Course (Class 6): 13 CY
- Concrete Sidewalk (8 Inch): 35 SY
- Concrete Pavement (8 Inch): 27 SY



Print Date: 5/2/2025


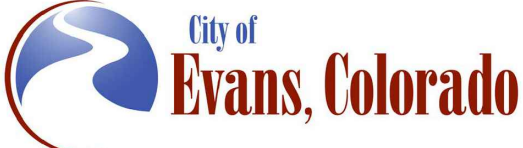
File Name: RA P2B-001 ROAD APPROACH.DWG

Horiz. Scale: As Noted Vert. Scale: As Noted



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Sheet Revisions		
Date	Comments	Initials



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	No Revisions:		
	Revised:		Drawing Number RA-006
Void:	Designer:	T. Tuttle	Sheet Number 49
	Detailer:	J. Jensen	
Sheet Subset: APPROACH		Subset Sheets: 6 of 6	

Plot Date: 5/2/2025 6:43 AM Plotted By: Sarah Hemler
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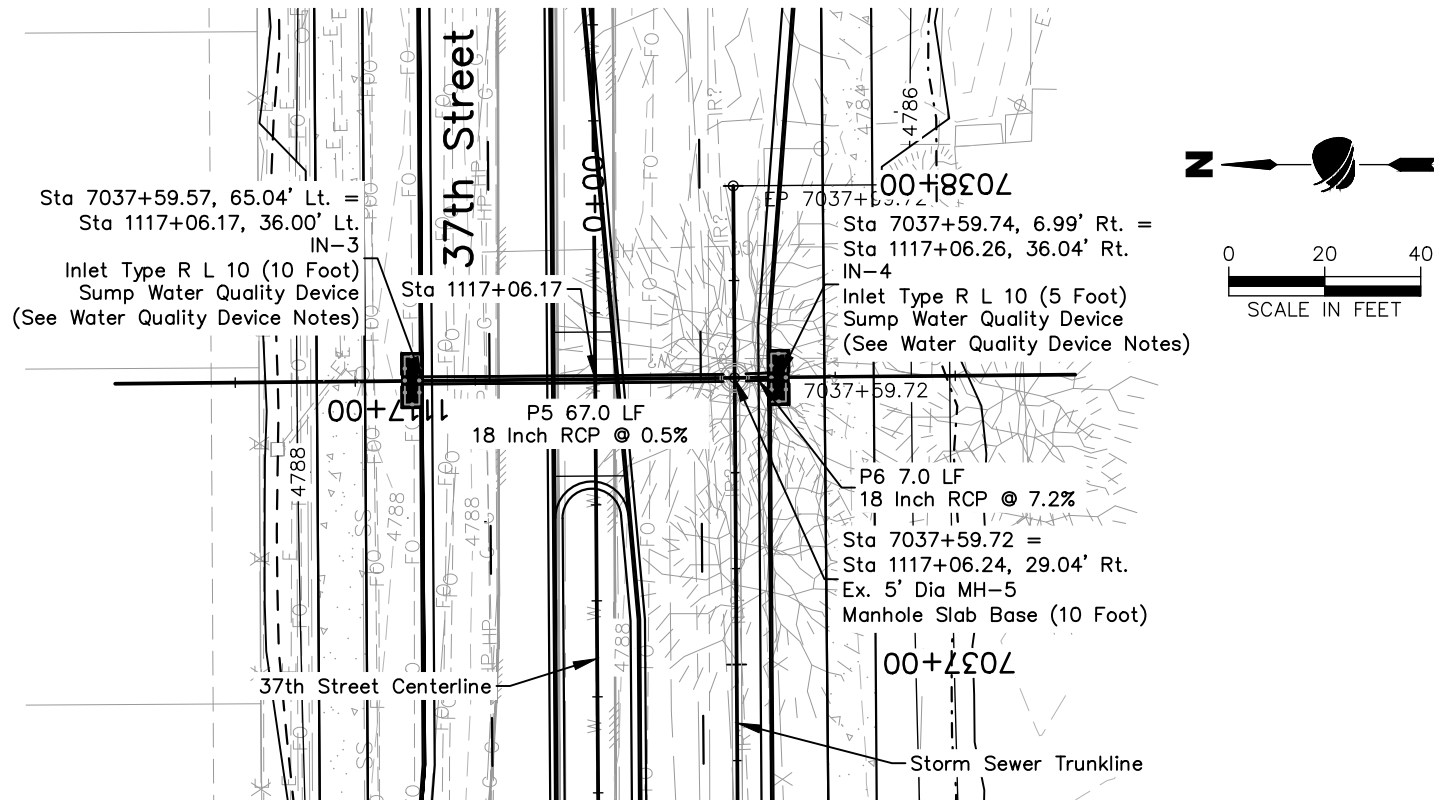
FOR CONSTRUCTION 5/1/2025

WATER QUALITY DEVICE NOTES


1. The Contractor shall submit construction shop drawings to the Engineer for approval prior to installation.
2. Water quality inlets shall consist of 10' Type R Inlets and have the following equipment installed:
 - Frog Reek Partners Gutter Bin Curb Inlet Filter
 - Mundus Bag
 - Mundus Hoop

NOTES:

1. All storm pipe lengths are from center of structure to center of structure unless otherwise noted.
2. Snout is 24R snout.



STA 1117+06.17 STORM SEWER PLAN LATERAL

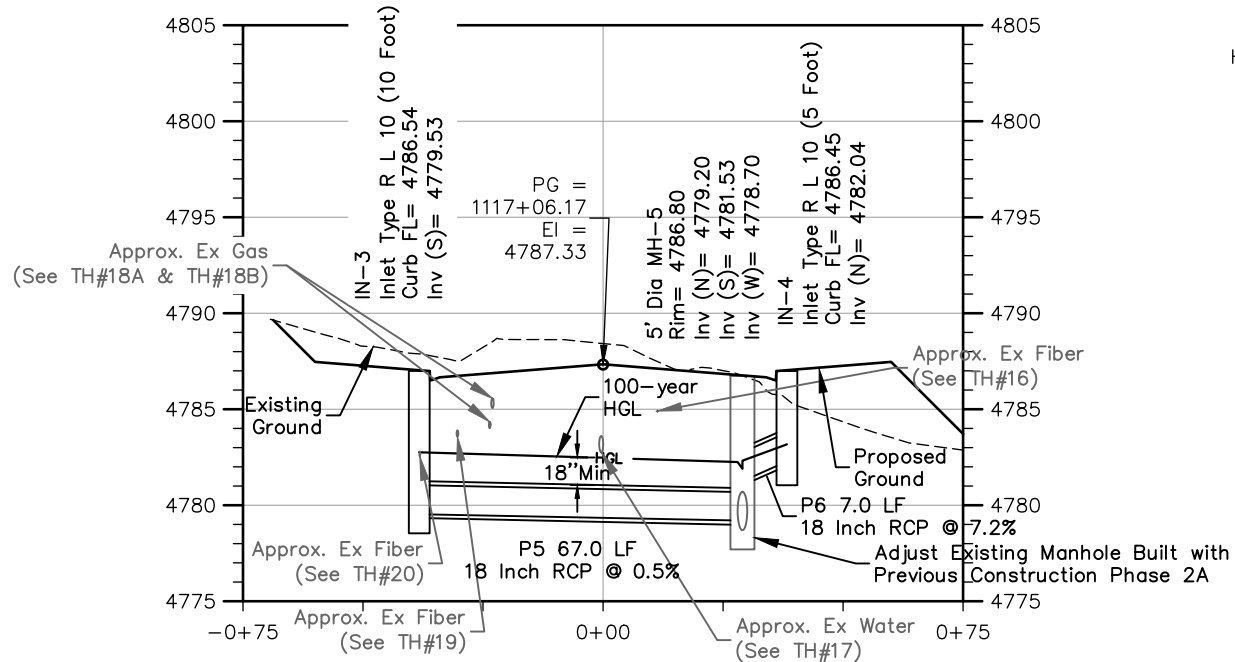


STA 1117+06.17 STORM SEWER PROFILE LATERAL




Print Date: 5/29/2025	
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Horiz. Scale: As Noted	Vert. Scale: As Noted
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	Ph: (303) 962-9300
Fax: (303) 962-9350	

Sheet Revisions		
Date	Comments	Initials

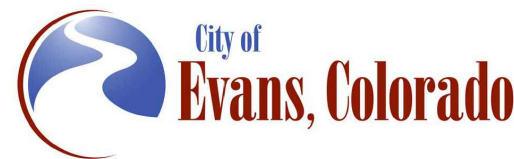


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	No Revisions:		37TH STREET 2B
Revised:	Designer: E. Schneider	Structure Numbers	Drawing Number STRM-001
Void:	Detailer: J. Jensen	Sheet Subset: STRM P&P	Sheet Number
		Subset Sheets: 1 of 1	

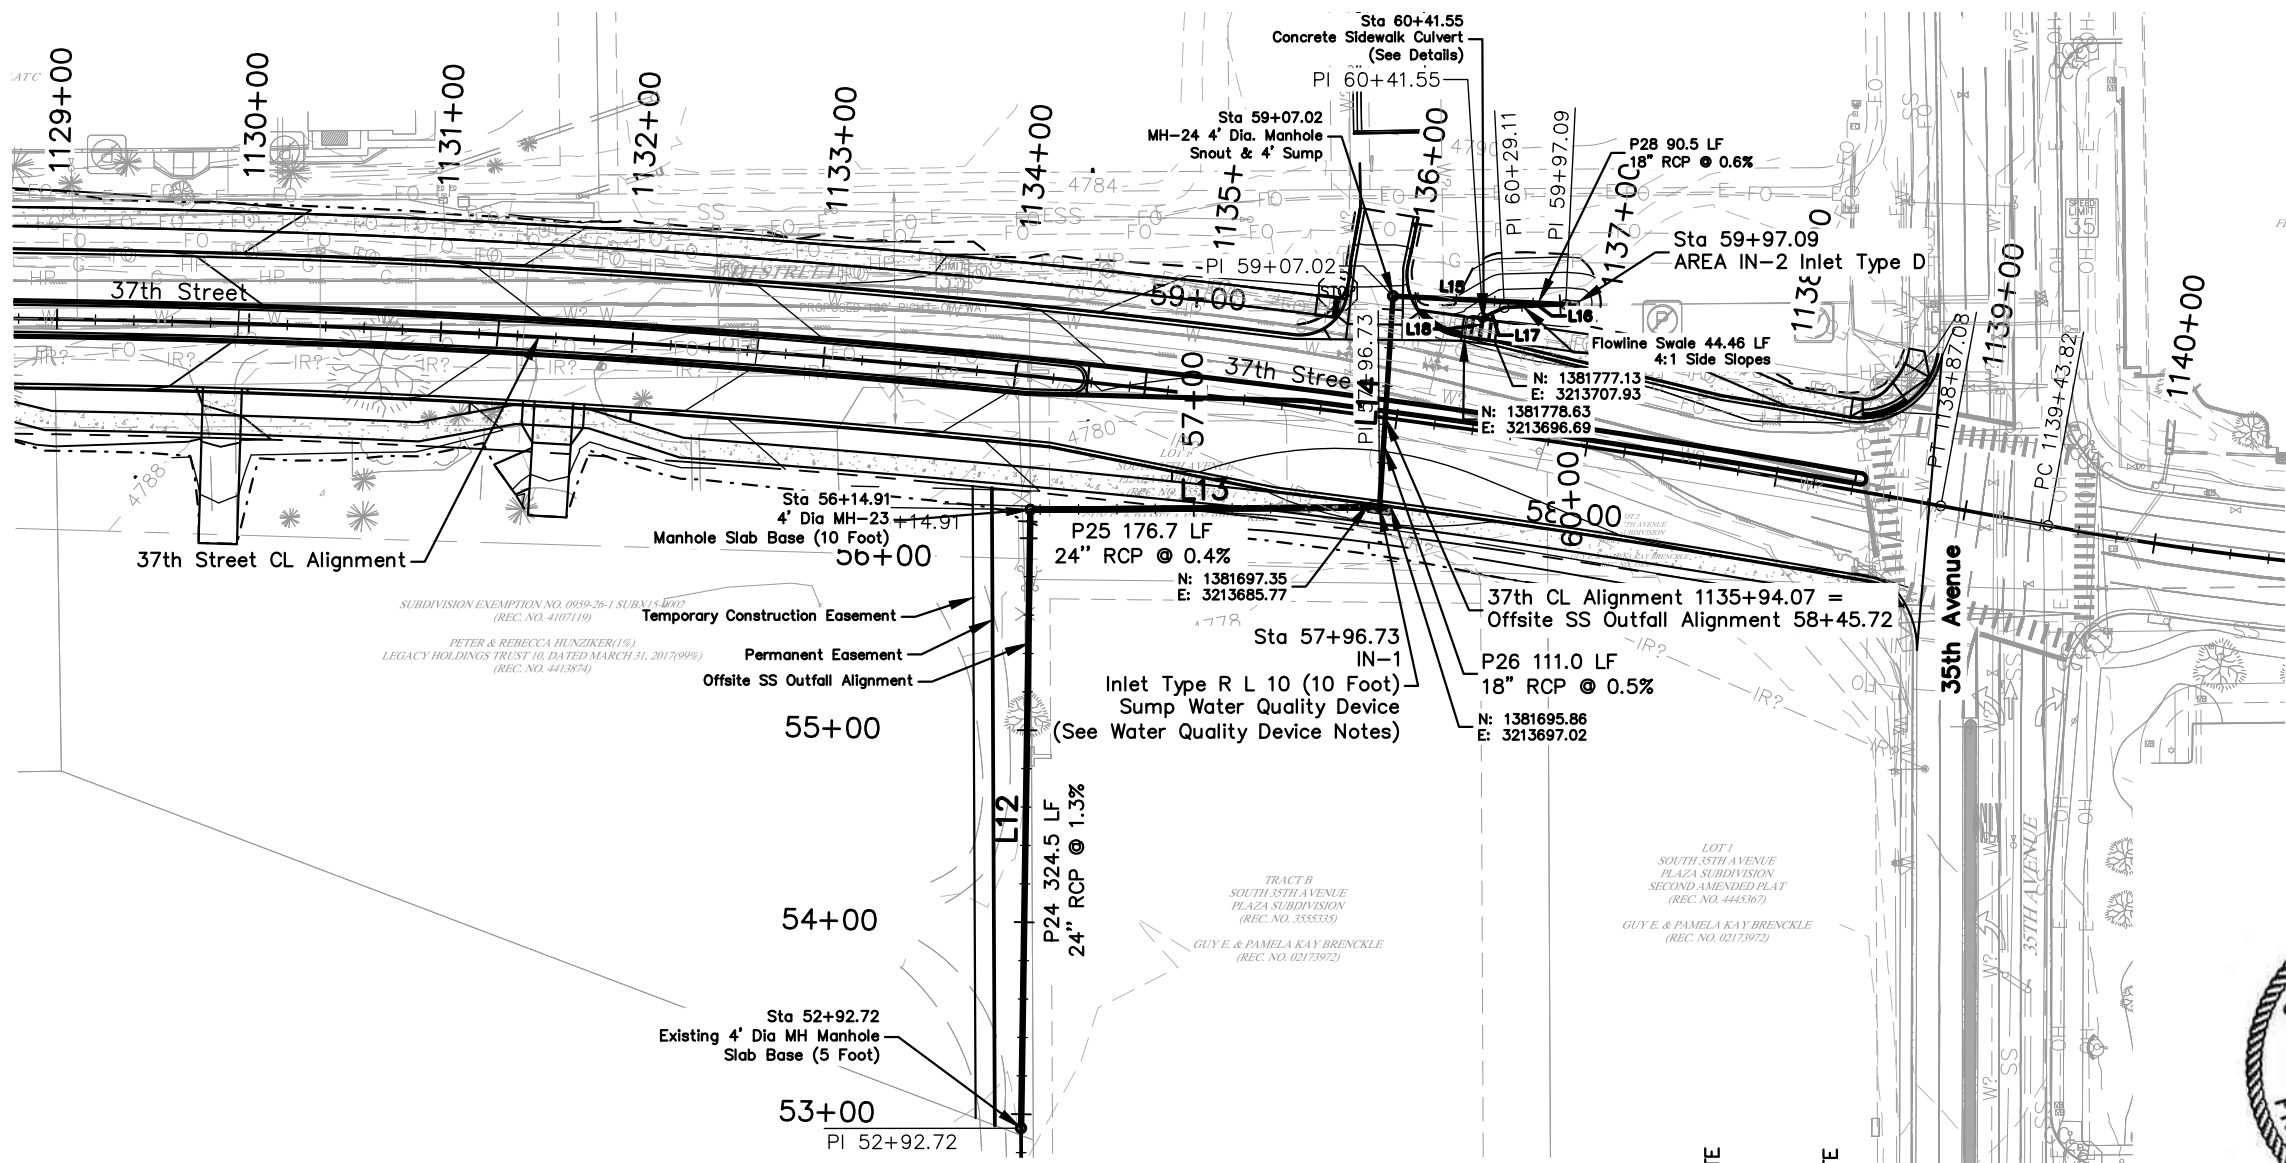

Offsite SS Outfall Alignment				
Line No.	Start Northing	Start Easting	Length	Direction
L12	1381371.91	3213504.52	322.20	N0° 51' 43"E
L13	1381694.07	3213509.36	181.82	N89° 38' 18"E
L14	1381695.21	3213691.18	110.29	N3° 40' 04"E
L15	1381805.28	3213698.24	90.06	S87° 14' 06"E
L16	1381800.93	3213788.19	32.02	S87° 11' 19"W
L17	1381799.36	3213756.21	12.44	S65° 11' 31"W
L18	1381794.14	3213744.92	11.49	S7° 59' 26"W




- WATER QUALITY DEVICE NOTES**
- The Contractor shall submit construction shop drawings to the Engineer for approval prior to installation.
 - Water quality inlets shall consist of 10' Type R Inlets and have the following equipment installed:
 - Frog Creek Partners Gutter Bin Curb Inlet Filter
 - Mundus Bag
 - Mundus Hoop

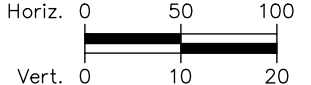

- NOTES:**
- All storm pipe lengths are from center of structure to center of structure unless otherwise noted.
 - Snout is 24R snout.



STA 57+00 to STA 62+00 OFFSITE STORM SEWER OUTFALL PLAN

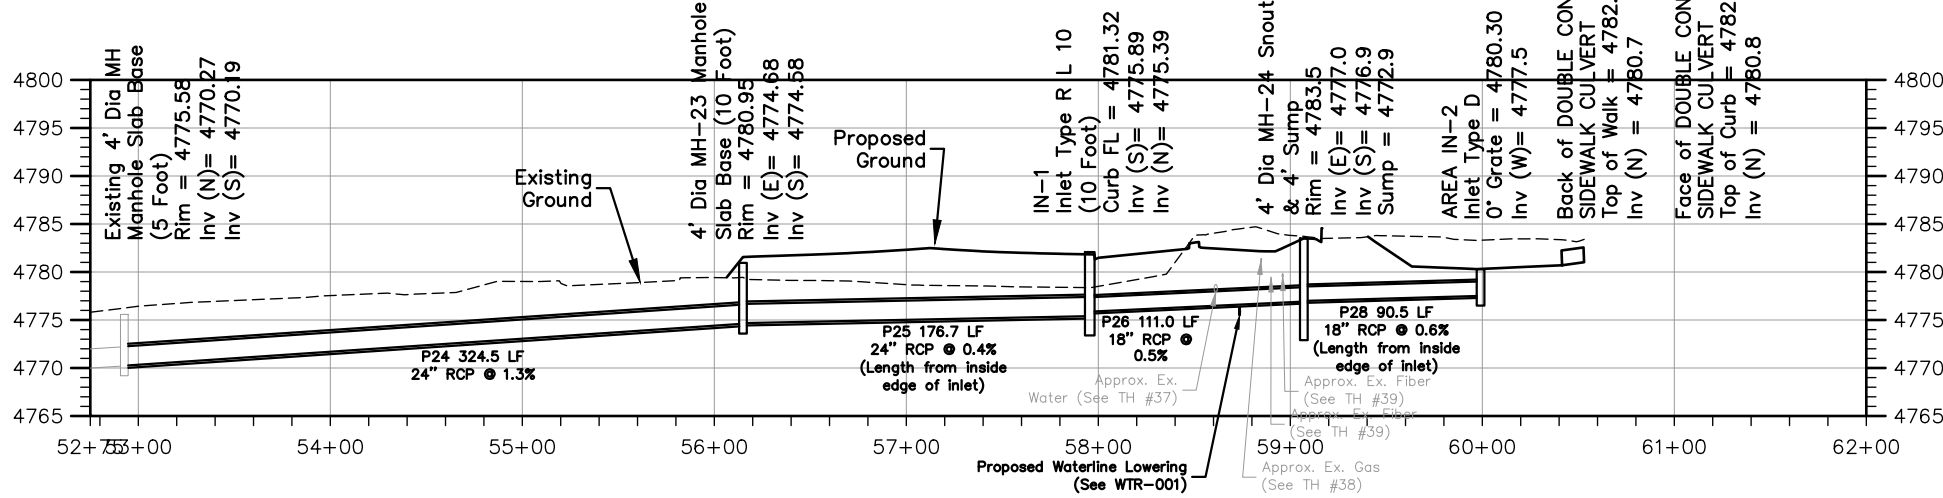

STA 57+00 to STA 62+00 OFFSITE STORM SEWER OUTFALL PROFILE

Print Date: 5/29/2025		Sheet Revisions				As Constructed	37TH STREET WIDENING PHASE 2B OFFSITE STORM SEWER OUTFALL		Project No.	
File Name: SSOFF P2B-001 STORM SEWER OFFSITE.DWG							37TH STREET 2B			
Horiz. Scale: As Noted		Vert. Scale: As Noted					Designer: E. Schneider	Structure	Drawing Number OFF-001	
		12076 Grant Street Thornton, CO 80241 Ph: (303) 962-9300 Fax: (303) 962-9350					Revised: K. Schultz	Numbers		
							Void:	Sheet Subset: OFFSITE SS	Subset Sheets: 1 of 1	Sheet Number

Plot Date: 5/29/2025 4:58 PM. Plotted By: Sarah Hamer
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FOR CONSTRUCTION 5/1/2025

TABULATION OF IRRIGATION QUANTITIES											
NOTE NO.	STATION AND OFFSET	*STRUCTURE EXCAVATION	**UNCLASSIFIED EXCAVATION	*STRUCTURE BACKFILL (SQUEEGEE SAND)	STRUCTURE BACKFILL (NATIVE MATERIAL)	**EMBANKMENT (NATIVE MATERIAL)	REINFORCED CONCRETE PIPE (CIP) 30"	PLASTIC PIPE 12"	INLET TYPE C (MODIFIED)	MANHOLE SLAB BASE (10 FOOT)	REMARKS
		CY	CY	CY	CY	CY	LF	EACH	EACH	EACH	
Pipe		229.63	197.13	81.67	116.72	195.60		385			
Box	1127+64.61, 52.69' Rt.								1		
Pipe		179.32	153.94	63.64	90.95	152.42		300			
Manhole	1130+66.18, 42.04' Rt.									1	
Pipe		201.81	173.25	71.70	102.47	171.72		338			
Manhole	1134+06.18, 42.49' Rt.									1	
Pipe		71.61	61.70	25.03	35.78	32.23		118			
Manhole	1135+25.27, 37.51' Rt.									1	
Pipe		78.09	6.75	24.70	34.17	62.58	93				Irrigation Lateral
Box	1127+64.58, 42.02' Lt.								1		Irrigation Lateral
TOTALS		761	593	267	380	615	93	1,141	2	3	

*For Information Only
**Carried to Summary of Earthwork



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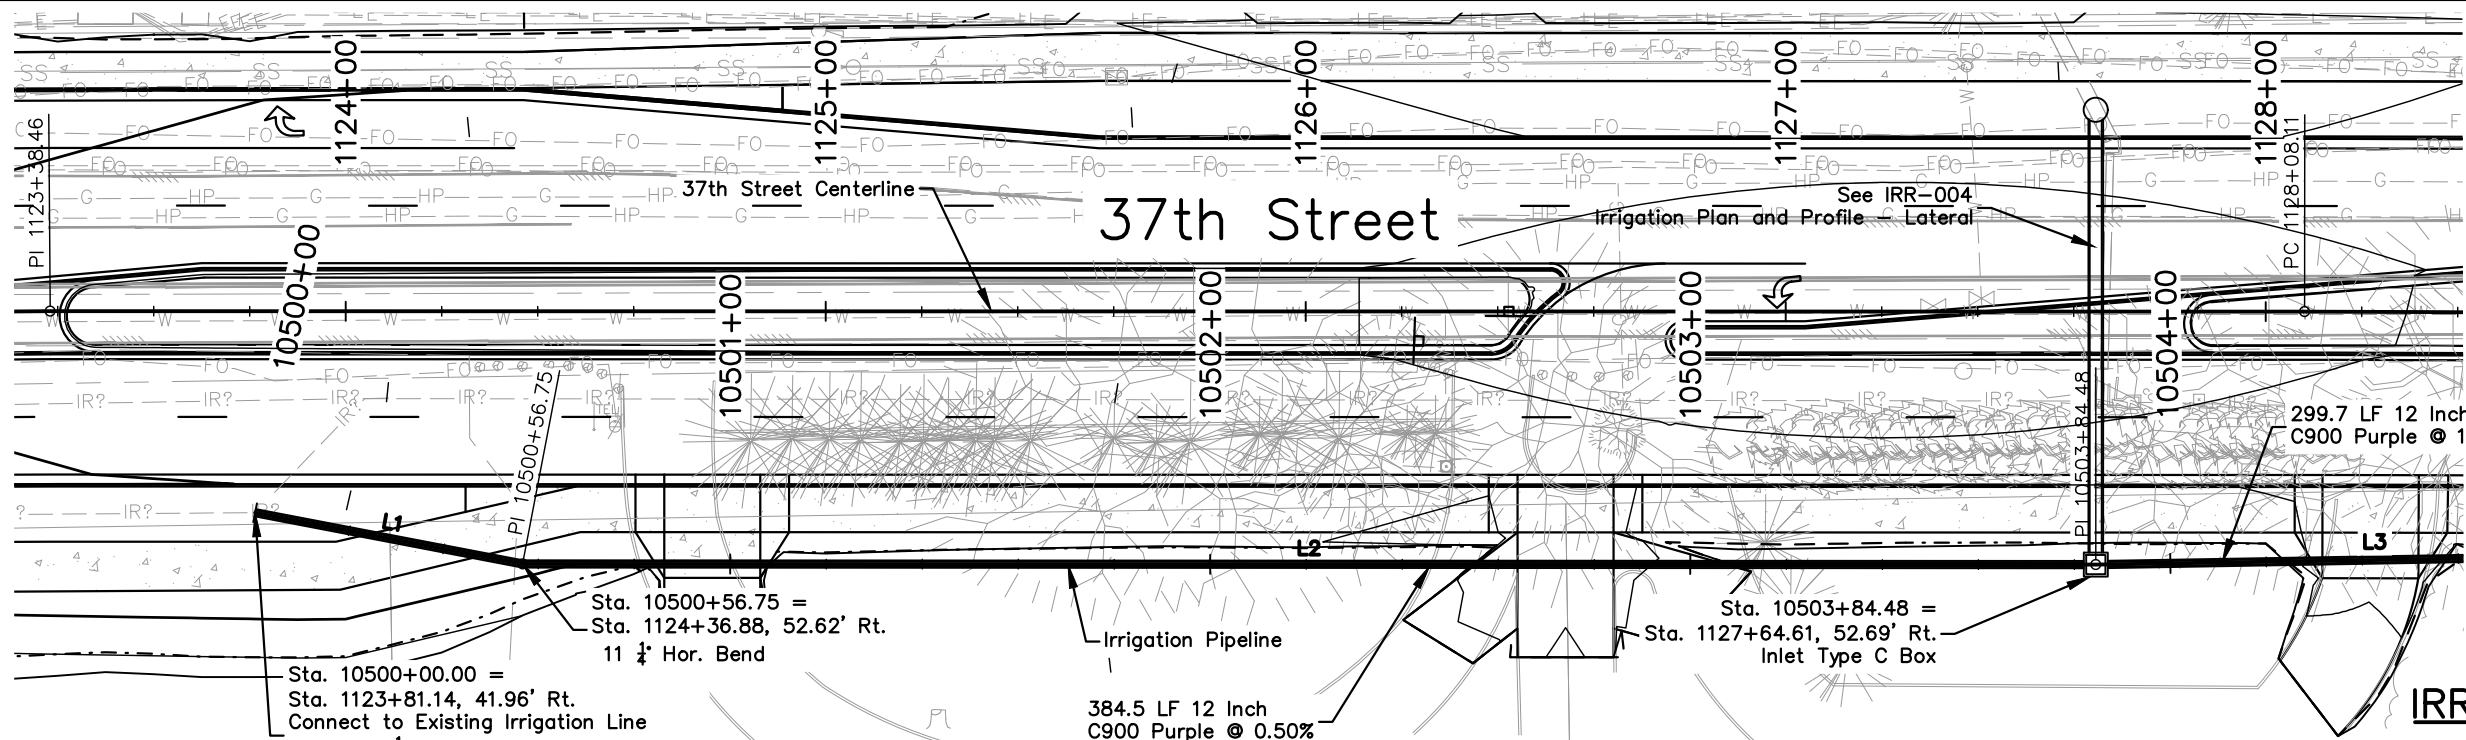
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R-1	Sheet Revisions		
	Date	Comments	Initials
	4/16/25	Added Irrigation work to plan set	SAH

As Constructed		37TH STREET WIDENING PHASE 2B IRRIGATION TABULATION		Project No.
No Revisions:				37TH STREET 2B
Revised:		Designer: T. Tuttle	Structure	Drawing Number IRTAB-001
Void:		Detailer: J. Jensen	Numbers	
		Sheet Subset: IRR TAB	Subset Sheets: 1 of 1	Sheet Number 51A


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FOR CONSTRUCTION 5/1/2025



STA 10500+00 to STA 10504+60 IRRIGATION PLAN

ALIGNMENT LINE TABLE				
Line No.	Length	Direction	Start Northing	Start Easting
L1	56.75	S79° 09' 31"E	1381752.21	3212483.54
L2	327.73	S89° 58' 27"E	1381741.53	3212539.28
L3	299.71	N89° 02' 32"E	1381741.38	3212867.00

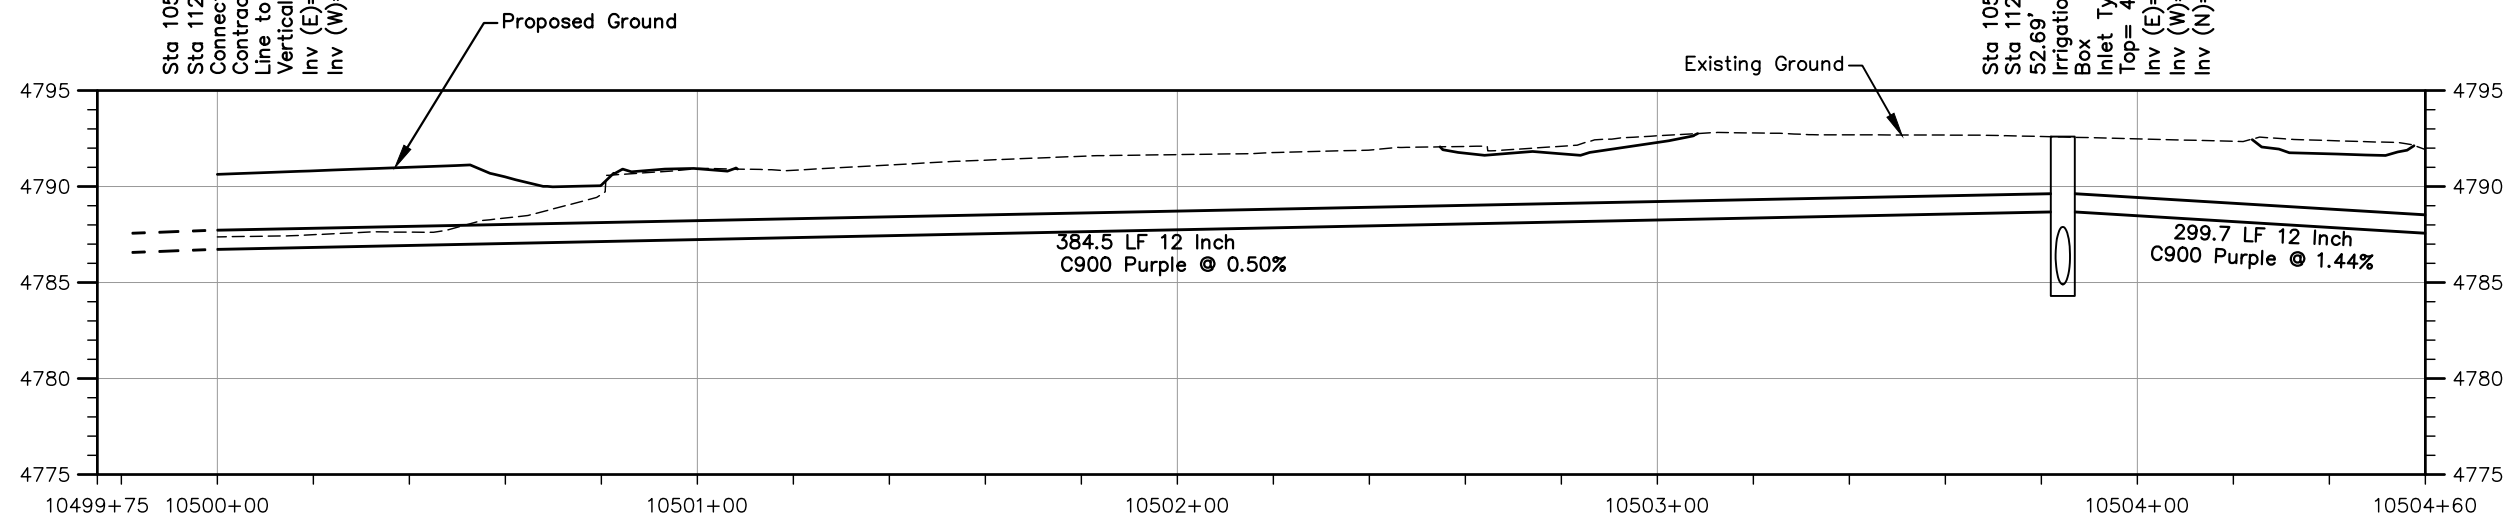

STA 10500+00 to STA 10504+60 IRRIGATION PROFILE

Print Date: 4/16/2025

File Name: IRR P2B-001 IRRIGATION PLAN & PROFILE.DWG

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Sheet Revisions

Date	Comments	Initials
4/16/25	Added Irrigation work to plan set	SAH

As Constructed

No Revisions:

Revised:

Void:

37TH STREET WIDENING PHASE 2B
IRRIGATION PLAN & PROFILE
TRUNKLINE

Designer: T. Tuttle

Detailer: J. Jensen

Sheet Subset: IRR P&P

Structure Numbers

Subset Sheets: 1 of 4

Project No.

37TH STREET 2B

Drawing Number IRR-001

Sheet Number 51B


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FOR CONSTRUCTION 5/1/2025

R-1




0 20 40
SCALE IN FEET

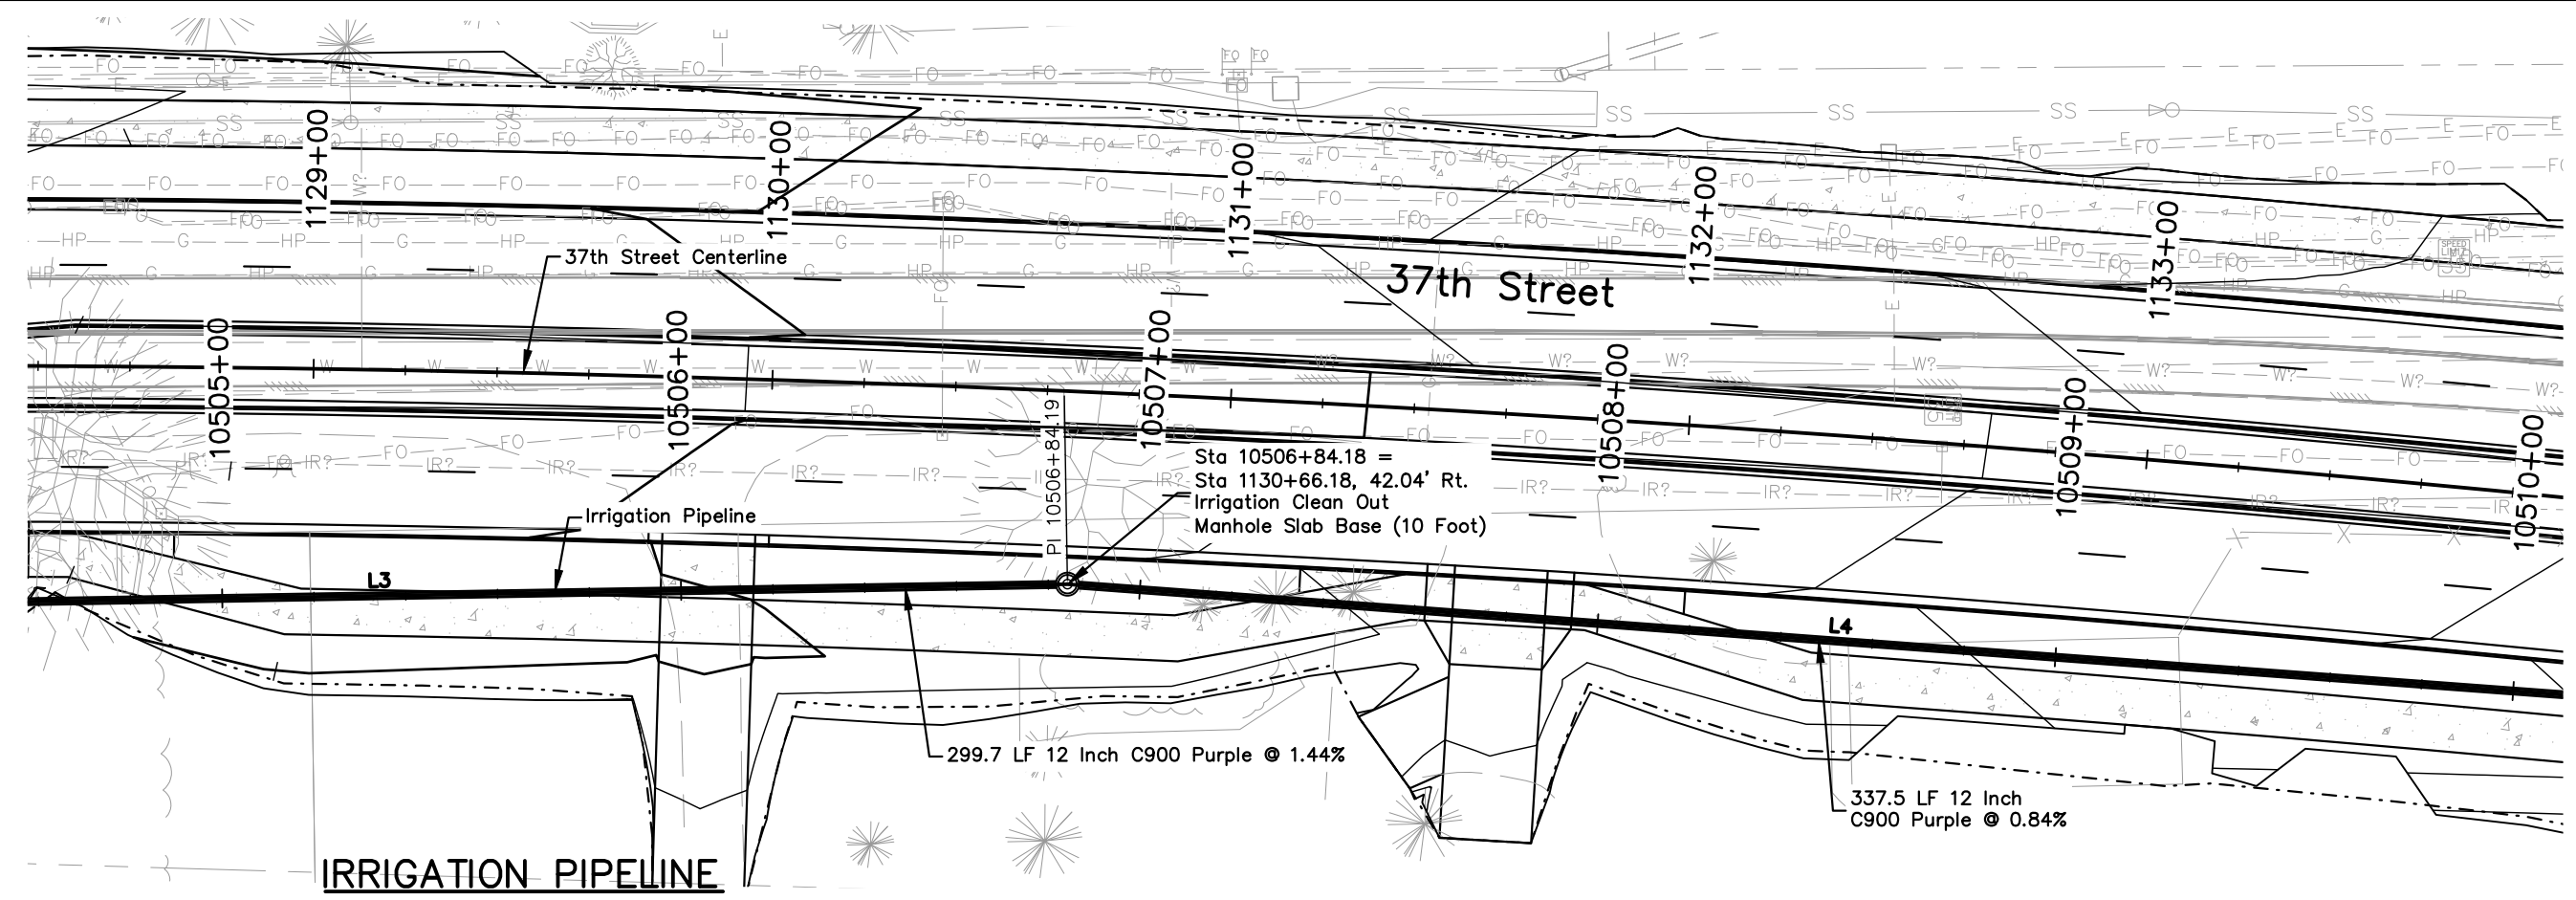

STA 10504+60 to STA 10510+00 IRRIGATION PLAN

ALIGNMENT LINE TABLE				
Line No.	Length	Direction	Start Northing	Start Easting
L3	299.71	N89° 02' 32"E	1381741.38	3212867.00
L4	337.53	S85° 46' 43"E	1381746.39	3213166.67

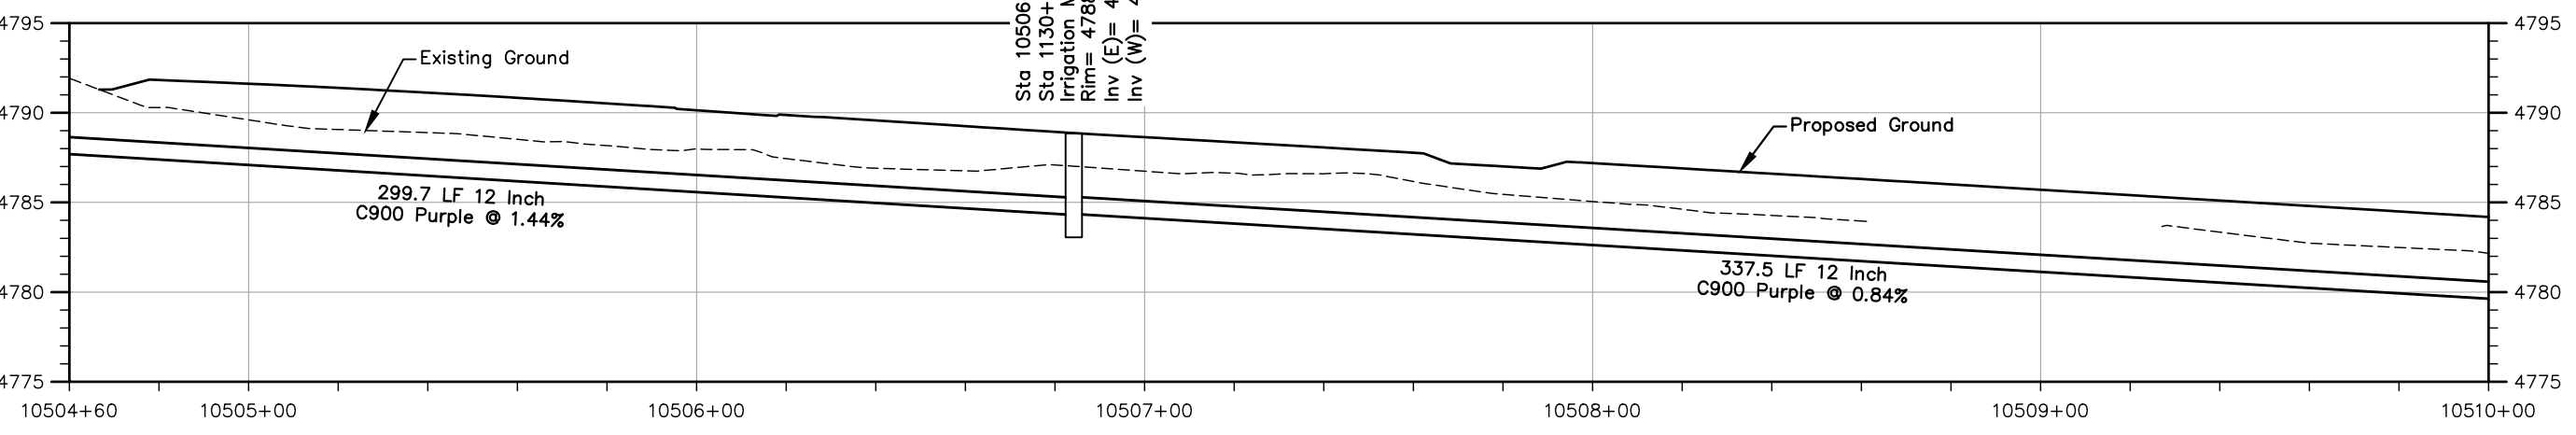

STA 10504+60 to STA 10510+00 IRRIGATION PROFILE

Horiz. 0 20 40
Vert. 0 5 10



Print Date: 4/16/2025


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Horiz. Scale: As Noted

Vert. Scale: As Noted

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Sheet Revisions		
Date	Comments	Initials
4/16/25	Added Irrigation work to plan set	SAH




As Constructed
No Revisions:
Revised:
Void:

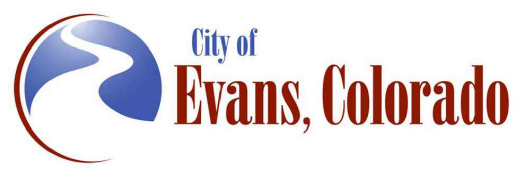37TH STREET WIDENING PHASE 2B IRRIGATION PLAN & PROFILE TRUNKLINE	
Designer: T. Tuttle	Structure Numbers
Detailer: J. Jensen	
Sheet Subset: IRR P&P	Subset Sheets: 2 of 4


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Drawing Number IRR-002
Sheet Number 51C

Plot Date: 4/16/2025 3:17 PM Plotted By: Sarah Henning
C:\Q-PROJECTS\2025\37TH ST AND 47TH AVE PLAN\2025\COMPUTER DESIGN FILES\2 - PHASE 2B\001-SHEET FILES\IRR P2B-001 IRRIGATION PLAN & PROFILE.DWG

FOR CONSTRUCTION 5/1/2025

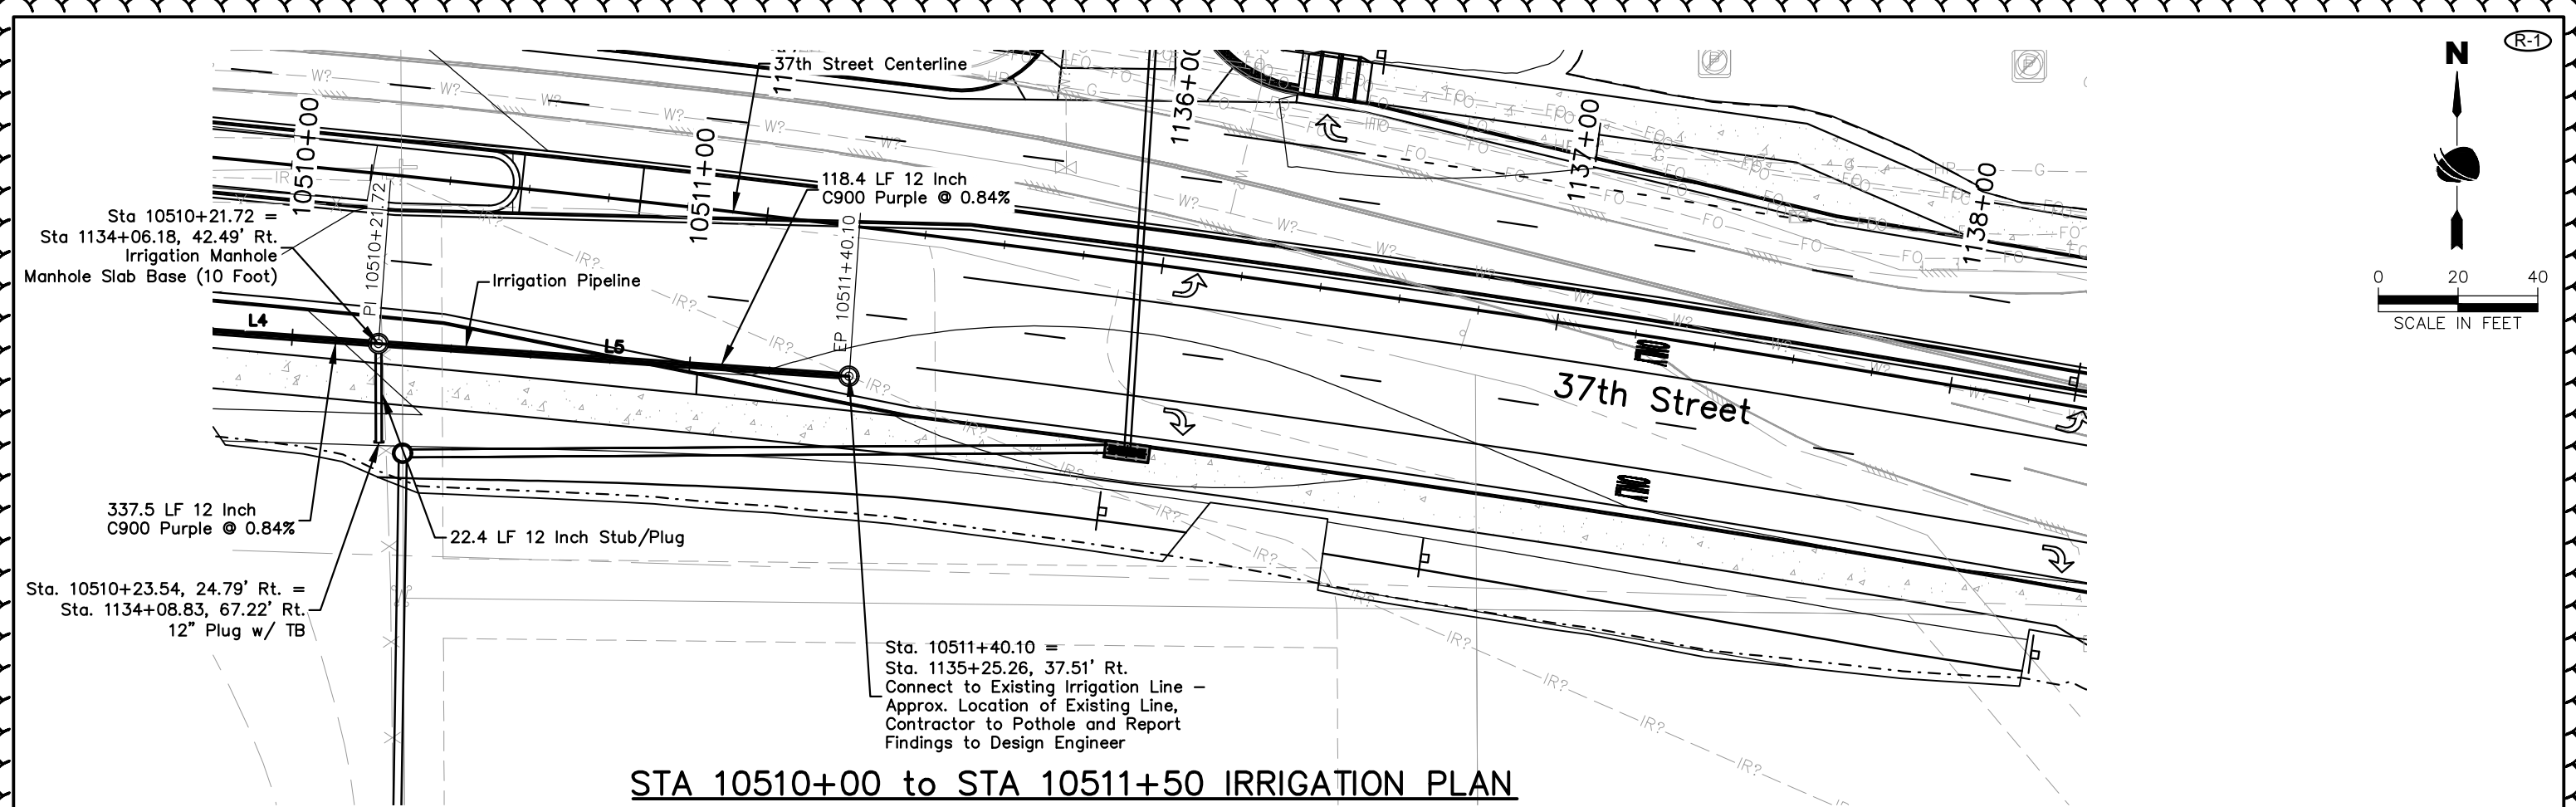

STA 10510+00 to STA 10511+50 IRRIGATION PLAN

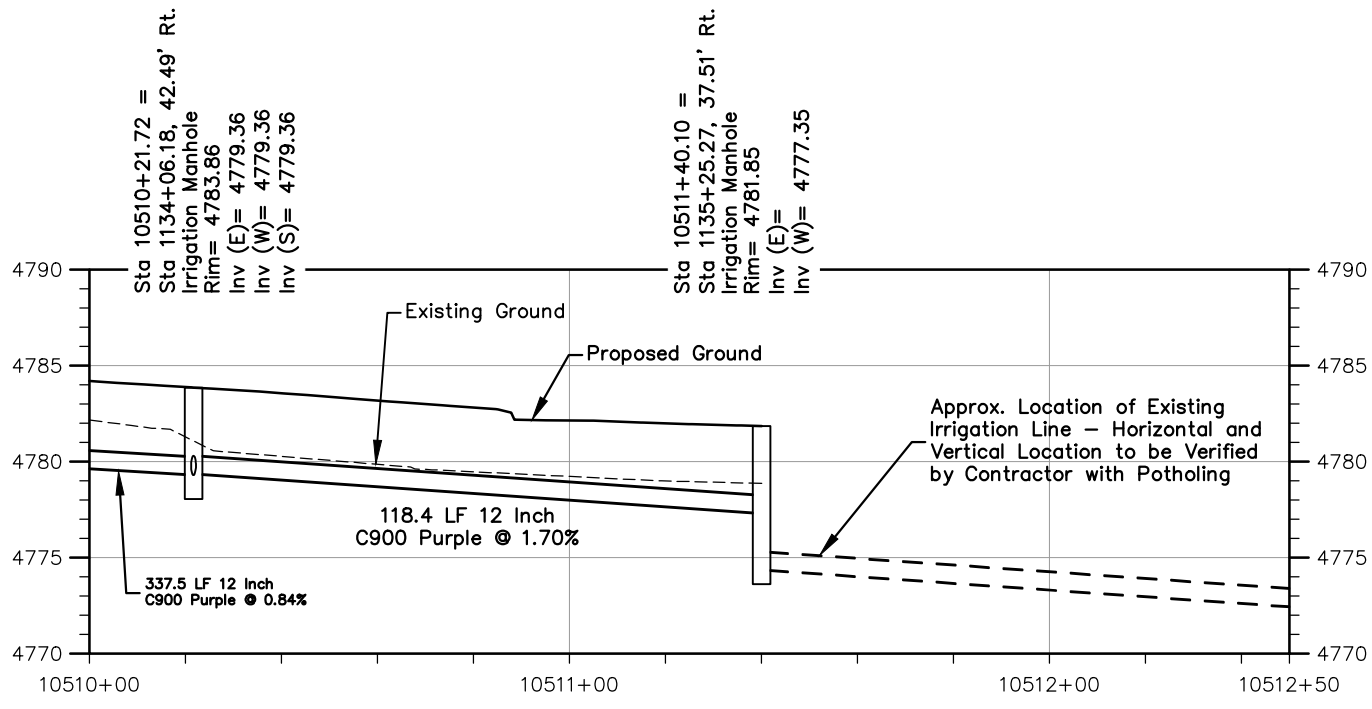


STA 10510+00 to STA 10511+50 IRRIGATION PROFILE

IRRIGATION PIPELINE

ALIGNMENT LINE TABLE				
Line No.	Length	Direction	Start Northing	Start Easting
L4	337.53	S85° 46' 43"E	1381746.39	3213166.67
L5	118.39	S86° 03' 01"E	1381721.55	3213503.28

ALIGNMENT END				
Line No.	Length	Direction	End Northing	End Easting
L5	118.39	S86° 03' 01"E	1381713.39	3213621.39

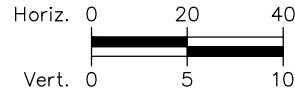

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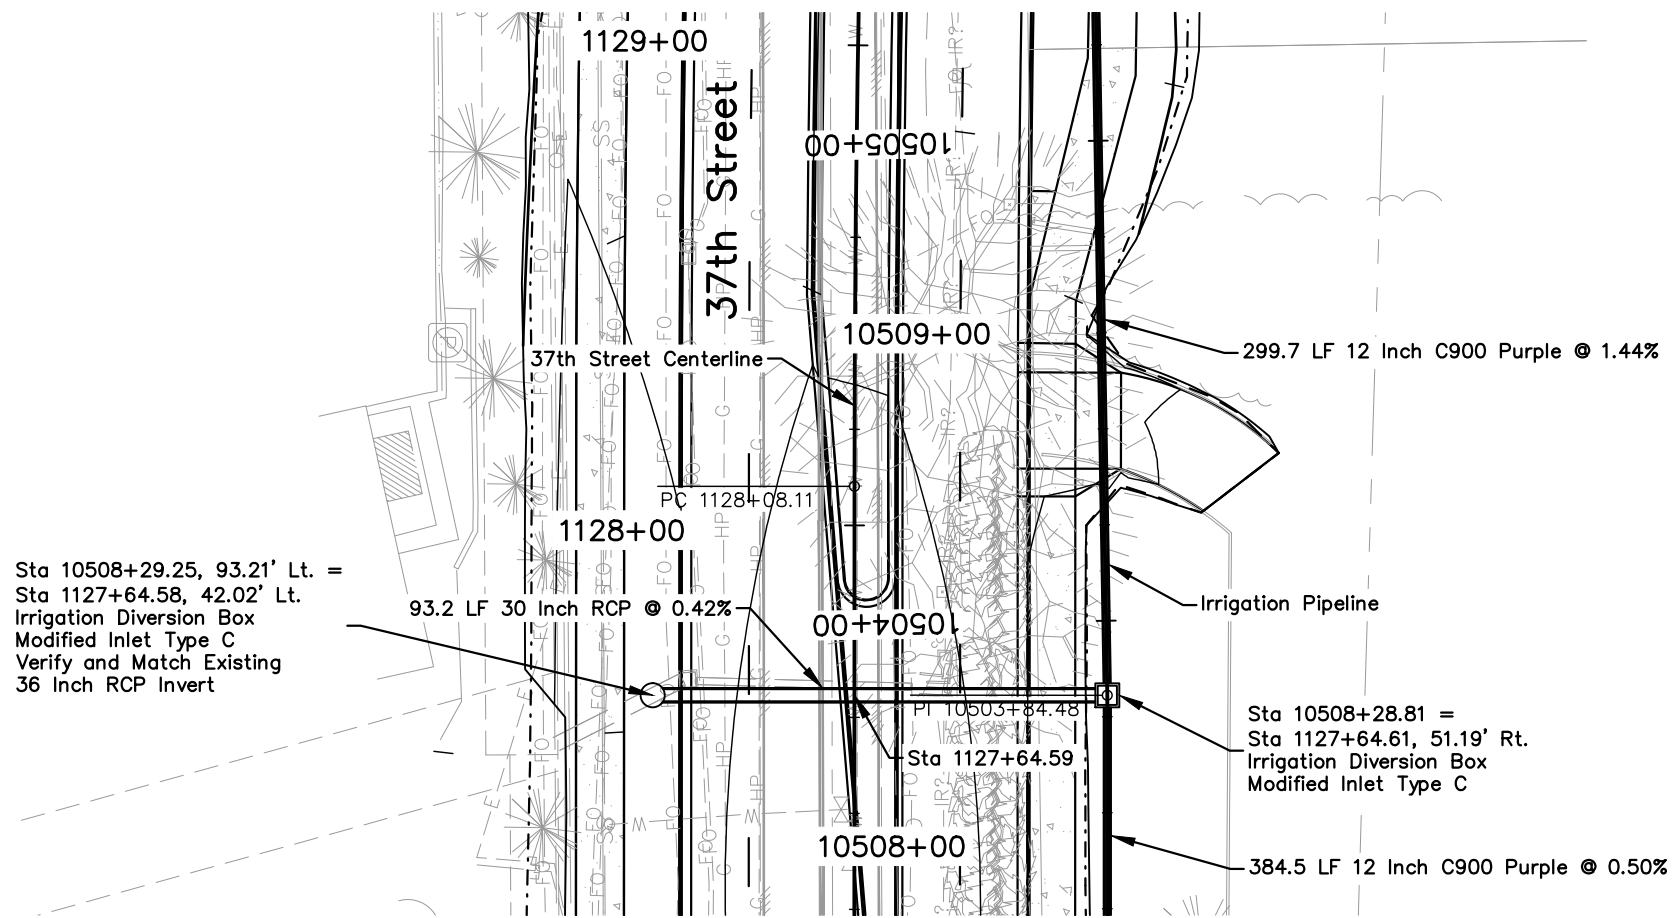
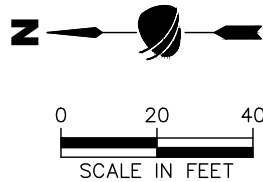
Sheet Revisions		
Date	Comments	Initials
4/16/25	Added Irrigation work to plan set	SAH

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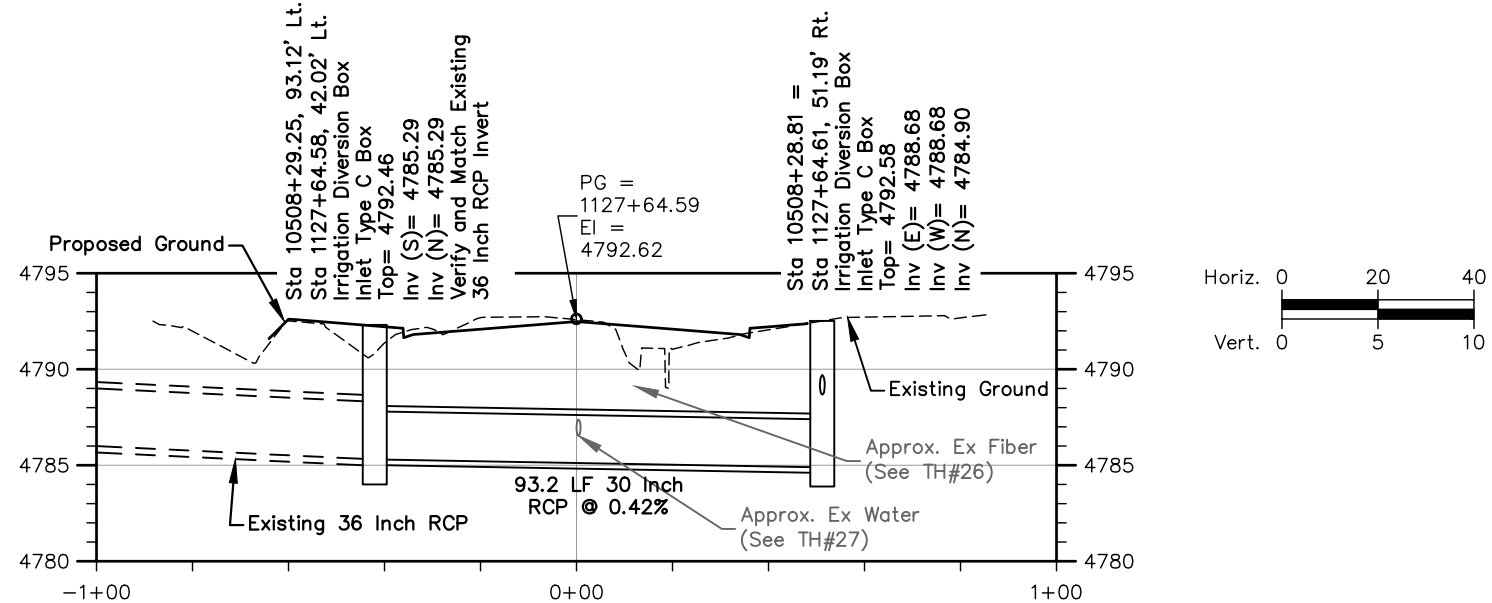
37TH STREET WIDENING PHASE 2B IRRIGATION PLAN & PROFILE TRUNKLINE		
Designer:	T. Tuttle	Structure Numbers
Detailer:	J. Jensen	
Sheet Subset:	IRR P&P	Subset Sheets: 3 of 4

Project No.	
37TH STREET 2B	
Drawing Number IRR-003	
Sheet Number 51D	

FOR CONSTRUCTION 5/1/2025



STA 1127+64.59 IRRIGATION PLAN




STA 1127+64.59 IRRIGATION PROFILE



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4/16/25	Added Irrigation work to plan set	SAH



As Constructed	37TH STREET WIDENING PHASE 2B IRRIGATION PLAN & PROFILE LATERAL		Project No.
	No Revisions:		37TH STREET 2B
Revised:	Designer: T. Tuttle	Structure Numbers	Drawing Number IRR-004
Void:	Detailer: J. Jensen		
Sheet Subset: IRR P&P		Subset Sheets: 4 of 4	Sheet Number 51E

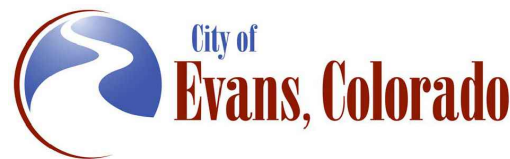Plot Date: 5/2/2025 6:46 AM Plotted By: Sarah Hemler
C:\Q-PROJECTS\WATER PROJECTS\33001\EVANS 37TH ST AND 47TH AVE PLAN\2020 COMPUTER DESIGN FILES\P2 - PHASE 2B\802_SHEET FILES\WTR-001 TAB AND NOTES.DWG

WATER LINE NOTES

TABULATION OF WATER ITEMS								REMARKS
STATION	SIDE	619-00007	619-50640	619-50800	619-75064	619-75080	623-07006	
		CONNECT TO EXISTING WATERLINE	8 INCH PVC C900 DR18	10 INCH PVC C900 DR18	8 INCH GATE VALVE	10 INCH GATE VALVE	3/4 INCH WATER METER	
		EACH	LF	LF	EACH	EACH	EACH	
1118+26.43	Rt.						1	Includes work for 3/4 Inch Copper Pipe and Removal of Existing Meter
1121+39.00	Rt.		59		1			Includes work for installation and incidental items
1126+18.00	Rt.						1	Includes work for 3/4 Inch Copper Pipe and Removal of Existing Meter
1131+50.00	Lt.	1						
1131+50.00 to 1137+00.00	Lt.			570				Includes work for installation and incidental items
1135+67.91	Lt.	1						
1135+71.50	Lt.		29		1	2		Includes work for installation and incidental items
1136+18.20	Lt.	1						
1137+00.00	Lt.	1						
TOTAL		4	88	570	2	2	2	

Note: For removal of valve, reset valve, reset of fire hydrant, and adjust manhole, see Tabulation of Removals, Resets, and Adjustments.

1. WATER LINE DIMENSIONS ARE CALCULATED TO THE CENTER OF FITTINGS.
2. THE SIZE, TYPE AND LOCATION OF ALL KNOWN UNDERGROUND UTILITIES ARE APPROXIMATE WHEN SHOWN ON THESE DRAWINGS. IT SHALL BE THE RESPONSIBILITY OF THE CONTRACTOR TO VERIFY THE EXISTENCE OF ALL UNDERGROUND UTILITIES BEFORE COMMENCING NEW CONSTRUCTION. THE CONTRACTOR SHALL BE RESPONSIBLE FOR LOCATING ALL UNDERGROUND UTILITIES AND SHALL BE RESPONSIBLE FOR ALL UNKNOWN UNDERGROUND UTILITIES.
3. WATERLINE, FITTINGS, AND JOINT RESTRAINT TO BE CONSTRUCTED PER CITY OF EVANS STANDARD SPECIFICATIONS.
4. ALL WATERLINES SHALL BE CONSTRUCTED OF C900 PVC (DR-18).
5. ALL 6" WATERLINES SERVICING FIRE HYDRANTS SHALL BE CONSTRUCTED OF DUCTILE IRON PIPE WITH MECHANICAL JOINTS OR C900 PVC (DR-18).
6. MECHANICAL JOINT RESTRAINT DEVICES FOR PVC PIPE SHALL BE EITHER MEGALUG 2000 PV SERIES OR APPROVED EQUAL AND SHALL BE INSTALLED PER MANUFACTURER'S SPECIFICATIONS.
7. ALL PIPE SHALL BE INSTALLED WITH A MINIMUM OF FOUR (4) FEET SIX (6) INCHES OF COVER FROM FINISHED GRADE OF STREET TO THE TOP OF THE PIPE BARREL. 2" BLUEBOARD INSULATION SHALL BE PLACED DIRECTLY ABOVE THE PIPE IF LESS THAN FOUR (4) FEET SIX (6) INCHES OF COVER. BLUEBOARD INSULATION IS INCIDENTAL TO THE PROJECT.
8. FITTINGS, TEES, THRUST BLOCKS AND MEGALUGS ARE INCIDENTAL TO THE WATER MAIN.
9. TRACING WIRE, WATER MAIN CP TEST STATIONS, AND CATHODIC PROTECTION SHALL BE INCIDENTAL TO THE WATER MAIN. TRACER WIRE SHALL BE INSTALLED ON ALL PVC WATERLINES.



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37TH STREET WIDENING PHASE 2B WATERLINE TAB AND NOTES

Designer: R. Parks

Detailer: R. Parks

Sheet Subset: WTR P&P

Structure Numbers

Subset Sheets: 1 of 2


Project No.

37TH STREET 2B


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STA 6000+00 to STA 6005+72 WATERLINE PLAN




STA 6000+00 to STA 6005+72 WATERLINE PROFILE
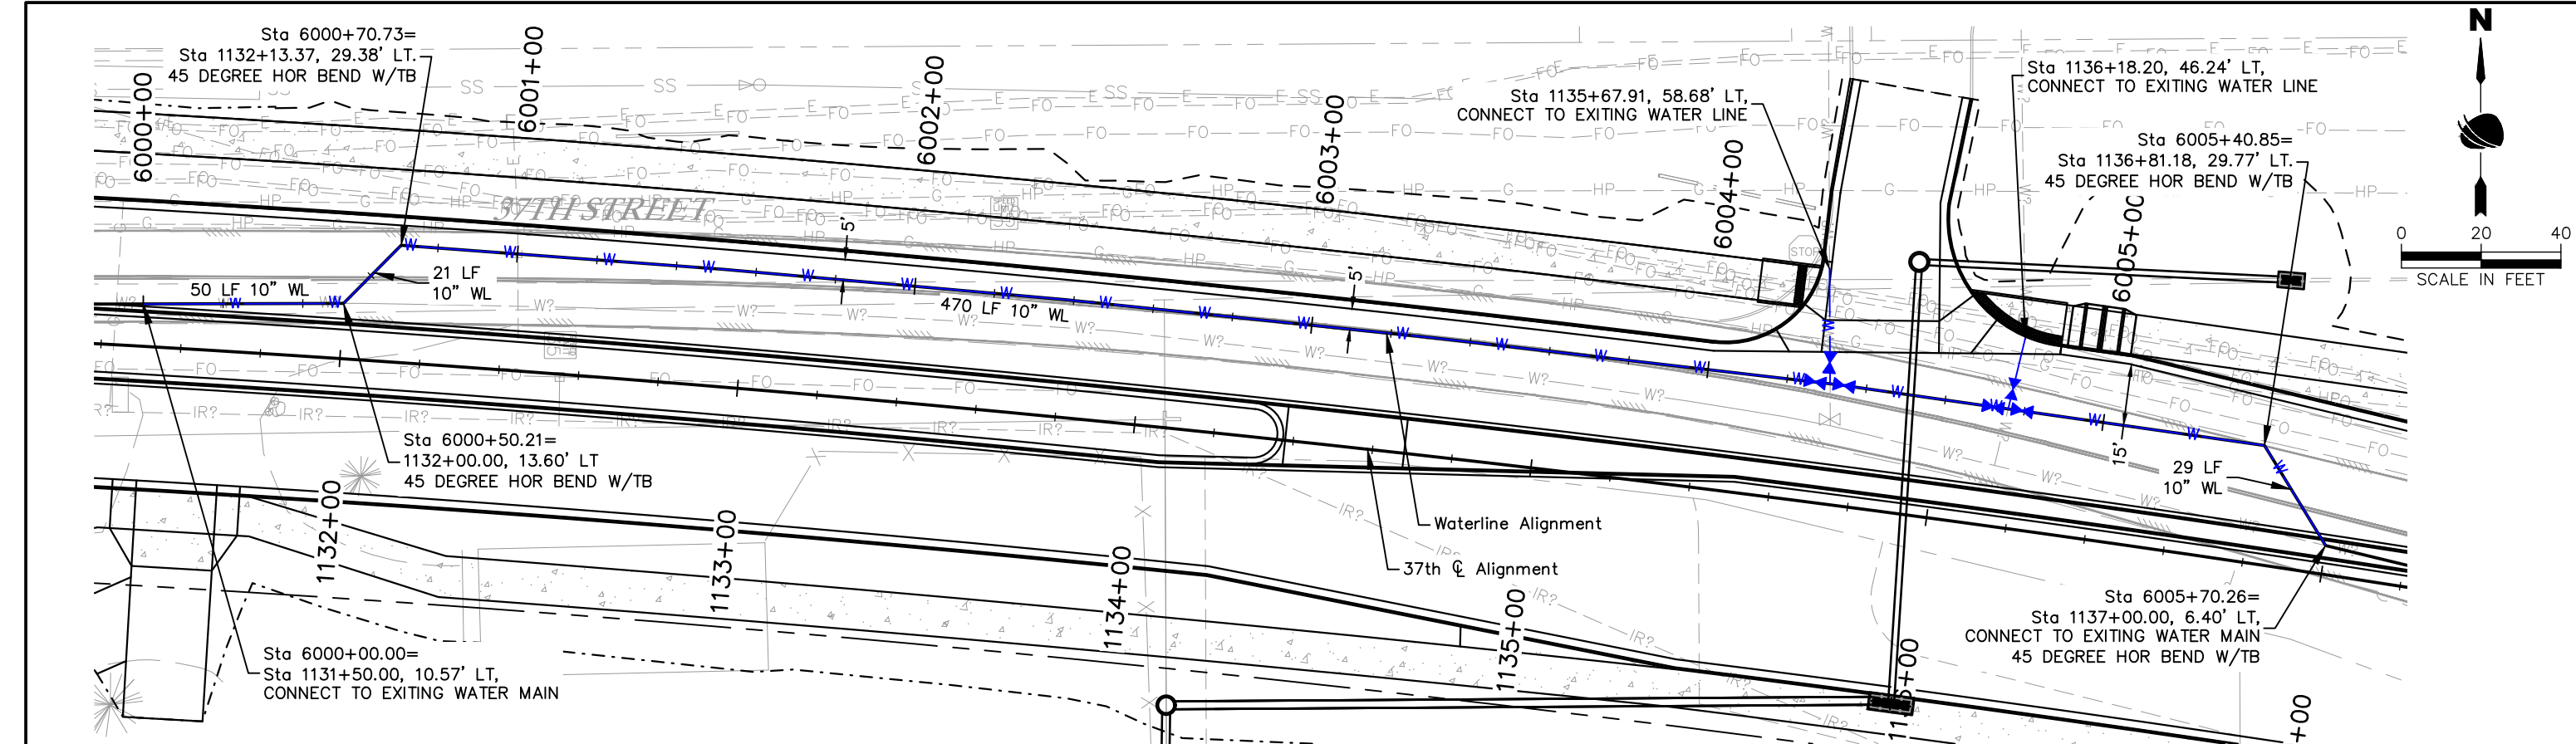
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37TH STREET WIDENING PHASE 2B WATERLINE PLAN & PROFILE		
Designer:	R. Parks	Structure Numbers
Detailer:	H. Pugh	
Sheet Subset:	WTR P&P	Subset Sheets: 2 of 2

Project No.
37TH STREET 2B
Drawing Number WTR-001
Sheet Number 53

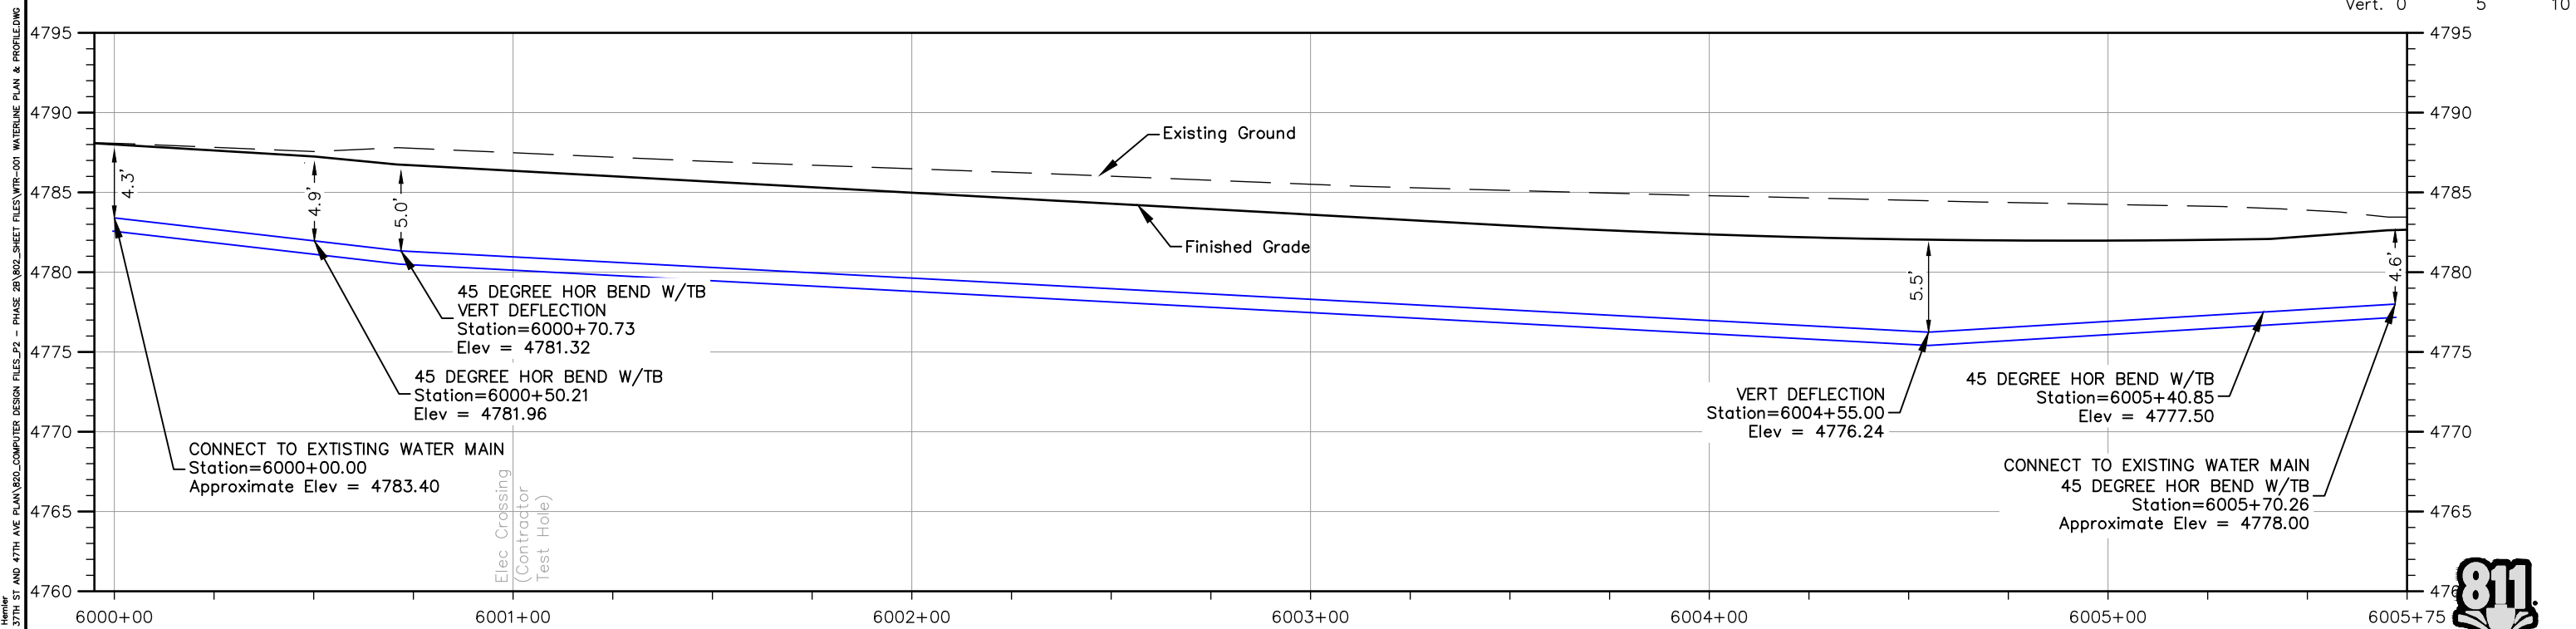FOR CONSTRUCTION 5/1/2025

Plot Date: 5/2/2025 6:47 AM Plotted By: Sarah Hemler
C:\Q-PROJECTS\UTG PROJECTS\33001\EVANS\37TH ST AND 47TH AVE PLAN\202 COMPUTER DESIGN FILES\P2 - PHASE 2B\202 SHEET PLEVISION P2B-001 UTILITY GENERAL NOTES.DWG

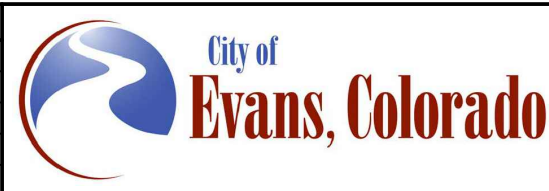PROJECT LIST OF UTILITY CONTACTS

NO.	COMPANY	ABBREVIATION	UTILITY TYPE	CONTACT NAME	EMAIL	PHONE
1	Atmos Energy	ATMOS	Gas	Jerry Adams	jerry.adams@atmosenergy.com	970-304-2075
2	CenturyLink	CTL	Fiber Optic	Gary Crispe	gcrispe@terratechllc.net	303-995-1456
3	City of Evans	City of Evans	Water and Sewer	Leon Blasco	lblasco@evanscolorado.gov	970-371-9089
4	Comcast	COMCAST	Fiber Optic	John Hamburg	john_hamburg@comcast.com	970-567-4797
5	DCP Midstream	DCP	Gas	Ivan Ansel	iansel@dcpmidstream.cpm	970-539-1806
6	Level 3 Communications	Level 3	Fiber Optic	Thomas Longan	thomas.longan@centurylink.com	720-878-6311
7	XCEL Energy Distribution	XCEL	Overhead and Underground Electric	Shayla Montano	shayla.a.montano@xcelenergy.com	970-381-9734
8	XCEL Energy Transmission	XCEL	Overhead and Underground Electric	William Braasch	william.braasch@xcelenergy.com	303-571-7082
9	Zayo	ZAYO	Fiber Optic	Tony Belford	tony@sctrl.com	801-364-1063

UTILITY GENERAL NOTES

- UTILITIES ARE DEPICTED ON THESE PLANS IN ACCORDANCE WITH THEIR ACHIEVED "QUALITY LEVELS" AS DEFINED IN THE AMERICAN SOCIETY OF CIVIL ENGINEERS' DOCUMENT ASCE 38, "STANDARD GUIDELINE FOR THE COLLECTION AND DEPICTION OF EXISTING SUBSURFACE UTILITY DATA." LOCATION OF EXISTING UTILITIES IS DEPICTED ACCORDING TO THE BEST AVAILABLE INFORMATION AND REPRESENT CONDITIONS AT THE TIME OF DATA COLLECTION. THESE PLANS DO NOT RELIEVE THE CONTRACTOR FROM FOLLOWING ALL APPLICABLE UTILITY DAMAGE PREVENTION STATUTES AND PROCEDURES DURING EXCAVATION. PRIOR TO CONSTRUCTION, CONTRACTOR VERIFICATION OF LOCATION AND DEPTHS OF UTILITIES FOR DAMAGE PREVENTION SHALL BE BORNE BY THE CONTRACTOR AND SHALL BE COMPLETED PRIOR TO THE COMMENCEMENT OF ANY CONSTRUCTION. THE CONTRACTOR SHALL NOTIFY THE ENGINEER OF ANY DISCREPANCIES.
- PRIOR TO COMMENCEMENT OF CONSTRUCTION, THE CONTRACTOR SHALL CONTACT ALL UTILITIES TO COORDINATE SCHEDULING. SHOULD ANY CONFLICTS, RECONSTRUCTION, OR INTERRUPTIONS IN SERVICE BE REQUIRED, THE CONTRACTOR SHALL COORDINATE UTILITY SCHEDULING.
- THE CONTRACTOR SHALL CORRECTLY SHOW ON SUBMITTED DRAWINGS THE LOCATIONS OF ALL UTILITIES IN THE VICINITY WHERE THE CONTRACTOR MAY BORE, TRENCH, EXCAVATE, AND INSTALL CONDUIT, FIBER, FIBER ENCLOSURES, VAULTS, AND HANDHOLDS. IN THE EVENT THAT THE CONDUIT RUN, FIBER ENCLOSURES, VAULTS, OR HANDHOLDS ARE LOCATED WITHIN THE VICINITY OF ANY UTILITY, THE CONTRACTOR SHALL BE RESPONSIBLE FOR THE DESIGN AND INSTALLATION THAT WILL PREVENT DAMAGE TO THE INSTALLATION UNDER NORMAL UTILITY OPERATING CONDITIONS. IT IS THE RESPONSIBILITY OF THE CONTRACTOR TO OBTAIN INFORMATION ON EACH OF THE UTILITIES AS APPLICABLE SUCH AS GAS PRESSURE, STEAM, AND WATER PRESSURES, TEMPERATURES, ETC.
- IT IS THE RESPONSIBILITY OF THE CONTRACTOR TO EXAMINE THE SITE FOR EVIDENCE OF FAILURES OF OR DEFICIENCIES IN UTILITY COMPANY FACILITIES (I.E. XCEL, CENTURYLINK, ETC) AND TO IMMEDIATELY CALL ANY SUCH EVIDENCE OF PRE-EXISTING DAMAGE TO THE ATTENTION OF THE UTILITY COMPANY ALONG WITH PROPER DOCUMENTATION. THE CONTRACTOR HEREBY AGREES THAT THE REPAIR OF ANY AND ALL DAMAGES (DIRECT AND INDIRECT), THAT MAY BE SUBSEQUENTLY DISCOVERED AND PROVEN TO HAVE BEEN CAUSED BY THE CONSTRUCTION ACTIVITIES, IS THE SOLE RESPONSIBILITY OF THE CONTRACTOR WITHOUT SUCH EVIDENCE OF PRE-EXISTING DAMAGE. THE CONTRACTOR HEREBY AGREES THAT ANY AND ALL DAMAGES (DIRECT OR INDIRECT) TO UTILITY COMPANY FACILITIES, WHICH ANY BE SUBSEQUENTLY DISCOVERED WITHIN THOSE AREAS WHERE CONSTRUCTION OCCURRED WITHIN SIX FEET OF UTILITY COMPANY FACILITIES (DIRECT OR INDIRECT), AND WITHIN A PERIOD OF THREE YEARS FROM THE DATE OF CONSTRUCTION, WERE CAUSED BY THE CONSTRUCTION ACTIVITIES. FURTHERMORE, THE REPAIR IS AGREED TO BE THE SOLE RESPONSIBILITY OF THE CONTRACTOR. IT SHALL BE THE CONTRACTOR'S RESPONSIBILITY TO PROTECT ALL UTILITY COMPANY FACILITIES WITHIN THE AREA OF CONSTRUCTION. THIS INCLUDES ALL STEPS NECESSARY TO PREVENT SUBSIDENCE OF THE SOIL ADJACENT TO OR NEAR UTILITY COMPANY FACILITIES.
- IT IS THE CONTRACTORS RESPONSIBILITY TO MAINTAIN ANY TEMPORARY ROADWAY PATCHES THAT MAY OCCUR IN ORDER TO REOPEN A ROADWAY WHILE CONSTRUCTION ACTIVITY PROGRESSES, UNTIL SUCH TIME A PERMANENT PATCH CAN BE INSTALLED.
- DURING CONSTRUCTION WHENEVER ANY PIPELINE IS LEFT UNATTENDED, TEMPORARY PLUGS SHALL BE INSTALLED AT ALL OPENINGS. TEMPORARY PLUGS SHALL BE WATERTIGHT, AND OF SUCH DESIGN AS TO PREVENT CHILDREN AND ANIMALS FROM ENTERING THE PIPE.
- THE CONTRACTOR SHALL NOTIFY ALL RESIDENTS IN WRITING PRIOR TO ANY DISTURBANCE IN SERVICE. THE NOTICES MUST HAVE THE CONTRACTORS PHONE NUMBER, THE NAME OF A CONTACT PERSON, AND AN EMERGENCY PHONE NUMBER FOR AFTER HOURS CALLS. NOTICES SHALL BE LEFT IN MAILBOXES UNLESS PROPERLY SENT THROUGH THE U.S. POST OFFICE.
- COMPACTION OF ALL UTILITY TRENCHES INCLUDING DRY UTILITIES SHALL BE PERFORMED TO 95% DENSITY OF THE STANDARD PROCTOR +/-2%.
- ALL POTABLE WATER, NON-POTABLE WATER, AND SANITARY SEWER SERVICES SHALL HAVE THEIR APPROXIMATE LOCATIONS STAMPED IN THE CONCRETE CURB AND GUTTER WITH THE INITIALS "W", "NP", AND "S" RESPECTIVELY. ADDITIONAL STAMPS FOR GAS "G" AND ELECTRIC "E" MAY ALSO BE NECESSARY AND ARE AT THE DISCRETION OF THE CONTRACTOR TO PERFORM.

UTILITY LEGEND

EXISTING	PROPOSED
OIL LINE (EXISTING QLB)	NP/W NON-POTABLE WATER LINE (PROPOSED)
OIL LINE (EXISTING QLD)	WATER LINE (PROPOSED)
GAS LINE LOW PRESSURE (EXISTING QLB)	STORM SEWER PIPE (PROPOSED)
GAS LINE LOW PRESSURE (EXISTING QLD)	IRRIGATION LINE (PROPOSED)
GAS LINE HIGH PRESSURE (EXISTING QLB)	FIRE HYDRANT
GAS LINE HIGH PRESSURE (EXISTING QLD)	WATER METER
NON-POTABLE WATER LINE (EXISTING QLD)	WATER VALVE
WATER LINE (EXISTING QLB)	WATER MANHOLE
WATER LINE (EXISTING QLD)	
STORM SEWER PIPE (EXISTING QLD)	
SANITARY SEWER PIPE (EXISTING QLB)	
SANITARY SEWER (EXISTING QLD)	
IRRIGATION LINE (EXISTING QLD)	
FIBER OPTICS UNDERGROUND CABLE (EXISTING QLB)	
FIBER OPTICS UNDERGROUND CABLE (EXISTING QLD)	
ELECTRICAL UNDERGROUND LINE (EXISTING QLB)	
ELECTRICAL UNDERGROUND LINE (EXISTING QLD)	
ELECTRICAL OVERHEAD LINE (EXISTING QLB)	
ELECTRICAL OVERHEAD LINE (EXISTING QLD)	
TEST HOLE LOCATION (QLA)	
SANITARY SEWER MANHOLE	
ELECTRICAL BOX	
POWER POLE	
GUY WIRE	
ELECTRICAL MANHOLE	
ELECTRICAL VAULT OR TRANSFORMER	
FIBER OPTIC PULLBOX	
FIBER OPTIC MANHOLE	
FIBER OPTIC PEDESTAL	
FIBER OPTIC MARKER	
GAS MARKER	
OIL MARKER	
IRRIGATION VALVE BOX	


QLA = QUALITY LEVEL A
QLB = QUALITY LEVEL B
QLD = QUALITY LEVEL D



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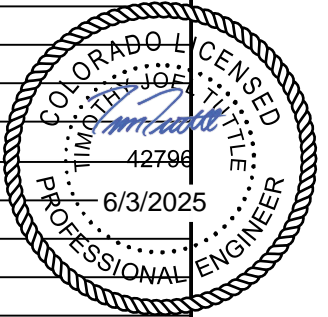
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	No Revisions:			37TH STREET
Revised:	Designer: R. Parks	Structure		Drawing Number UTGN-001
	Detailer: R. Parks	Numbers		
Void:	Sheet Subset: UTIL GEN	Subset Sheets: 1 of 2		Sheet Number 54

TEST HOLE TABLE (QUALITY LEVEL A)

POTHOLE NUMBER	UTILITY TYPE	UTILITY OWNER	UTILITY SIZE	UTILITY MATERIAL	SURFACE ELEVATION	DEPTH TO TOP OF UTILITY (IN.)	DEPTH TO TOP OF UTILITY (FT.)	UTILITY TOP OF PIPE (TOP) ELEV.	NOTES
16	FIBER OPTIC	CENTURYLINK	1/4-INCH	PVC	4787.2	31	2.58	4784.6	
17	WATER	CITY OF EVANS	10-INCH	STEEL	4788.1	58	4.83	4783.3	
18A	GAS	ATMOS	6-INCH	STEEL	4788.3	35.5	2.96	4785.3	
18B	GAS	ATMOS	4-INCH	STEEL	4788.3	50	4.17	4784.1	
19	FIBER OPTIC	LEVEL 3	2 X 4-INCH	PVC	4787.3	43.5	3.63	4783.7	
20	FIBER OPTIC	ZAYO	2-INCH & 1/2-INCH	PVC	4787.7	61	5.08	4782.6	
121	HP GAS	ATMOS	6-INCH	BLACK STEEL	4789.3	38	3.17	4786.1	
122	HP GAS	ATMOS	4-INCH	RED STEEL	4788.9	48	4.00	4784.9	
123	FIBER OPTIC	CENTURYLINK	2 x 6-INCH	WHITE PVC	4788.2	40	3.33	4784.8	Side by Side
124	FIBER OPTIC	CENTURYLINK	3-INCH	ORANGE POLY	4787.9	47	3.92	4783.9	
21	WATER	CITY OF EVANS	10-INCH	STEEL	4790.2	50.25	4.19	4786.0	
22A	GAS	ATMOS	6-INCH	STEEL	4790.3	38	3.17	4787.1	
22B	GAS	ATMOS	4-INCH	STEEL	4790.1	41	3.42	4786.7	
23	FIBER OPTIC	LEVEL 3	2 X 4-INCH	PVC	4790.2	87	7.25	4783.0	
24	FIBER OPTIC	CENTURYLINK	2-INCH & 1/2-INCH	PVC	4790.3	72	6.00	4784.3	
25	FIBER OPTIC	ZAYO	2 X 2-INCH	PVC	4790.1	34	2.83	4787.3	
125	HP GAS	ATMOS	6-INCH	BLACK STEEL	4791.2	32	2.67	4788.5	
126	HP GAS	ATMOS	4-INCH	RED STEEL	4791.2	57	4.75	4786.5	
127	FIBER OPTIC	CENTURYLINK	2 x 6-INCH	BLACK POLY	4790.8	36	3.00	4787.8	Side by Side
128	FIBER OPTIC	CENTURYLINK	2 x 3-INCH	ORANGE POLY	4790.4	55	4.58	4785.8	Stacked
26	FIBER OPTIC	CENTURYLINK	1/2-INCH	PVC	4790.6	13	1.08	4789.5	
27	WATER	CITY OF EVANS	10-INCH	STEEL	4792.5	63	5.25	4787.3	
28	GAS	ATMOS	6-INCH	STEEL	4792.6	40	3.33	4789.3	
29	GAS	ATMOS	2-INCH	STEEL	4791.9	48	4.00	4787.9	
30	FIBER OPTIC	LEVEL 3	2 X 4-INCH	PVC	4791.7	44	3.67	4788.0	
31					4791.2				Did Not Testhole
129	HP GAS	ATMOS	6-INCH	BLACK STEEL	4789.0	55	4.58	4784.4	
130	HP GAS	ATMOS	4-INCH	RED STEEL	4788.2	32	2.67	4785.5	
131	FIBER OPTIC	CENTURYLINK	2 x 6-INCH	PVC	4787.7	35	2.92	4784.8	
132	FIBER OPTIC	CENTURYLINK	4-INCH & 1-INCH	ORANGE POLY & BLACK POLY	4788.3	61	5.08	4783.2	Stacked
133	FIBER OPTIC	ZAYO	2 x 2-INCH	ORANGE POLY & BLUE POLY	4788.6	82	6.83	4781.8	Side by Side
32	WATER	CITY OF EVANS	10-INCH	STEEL	4787.1	55.5	4.63	4782.5	
33	GAS	ATMOS	6-INCH	STEEL	4787.7	46	3.83	4783.9	
34	GAS	ATMOS	4-INCH	STEEL	4786.9	58	4.83	4782.1	
35	FIBER OPTIC	ZAYO	2 X 4-INCH	PVC	4787.0	38	3.17	4783.8	
36	FIBER OPTIC	ZAYO	3 X 2-INCH	PVC	4788.3				Did Not Testhole
37	WATER	CITY OF EVANS	10-INCH	STEEL	4784.1	64.5	5.38	4778.7	
38	GAS	ATMOS	6-INCH	STEEL	4783.9	30	2.50	4781.4	
39	FIBER OPTIC	CENTURYLINK	2-INCH & 1-INCH	PVC	4783.5	49.5	4.13	4779.4	
40	FIBER OPTIC	CENTURYLINK	2 X 4-INCH	PVC	4783.4	43	3.58	4779.8	

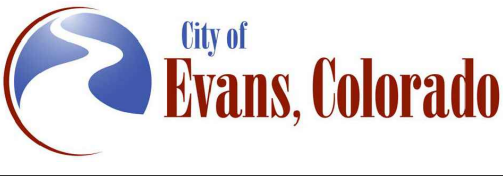

- Notes:
1. Testholes 16–40 performed on March 1, 2, 3, 4, 7, 2022.
 2. Testholes 121–133 performed on September 19, 20, 21, 2023

Print Date: 5/2/2025

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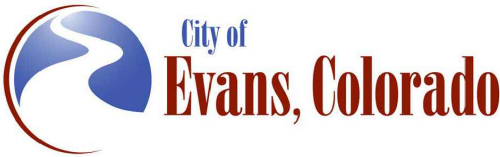
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37TH STREET WIDENING PHASE 2B
TEST HOLE TABLE


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37TH STREET WIDENING PHASE 2B
UTILITY PLANS

Designer: R. Parks
Detailer: R. Parks
Sheet Subset: UTILITIES

Structure Numbers
Subset Sheets: 1 of 4


Project No.

37TH STREET 2B

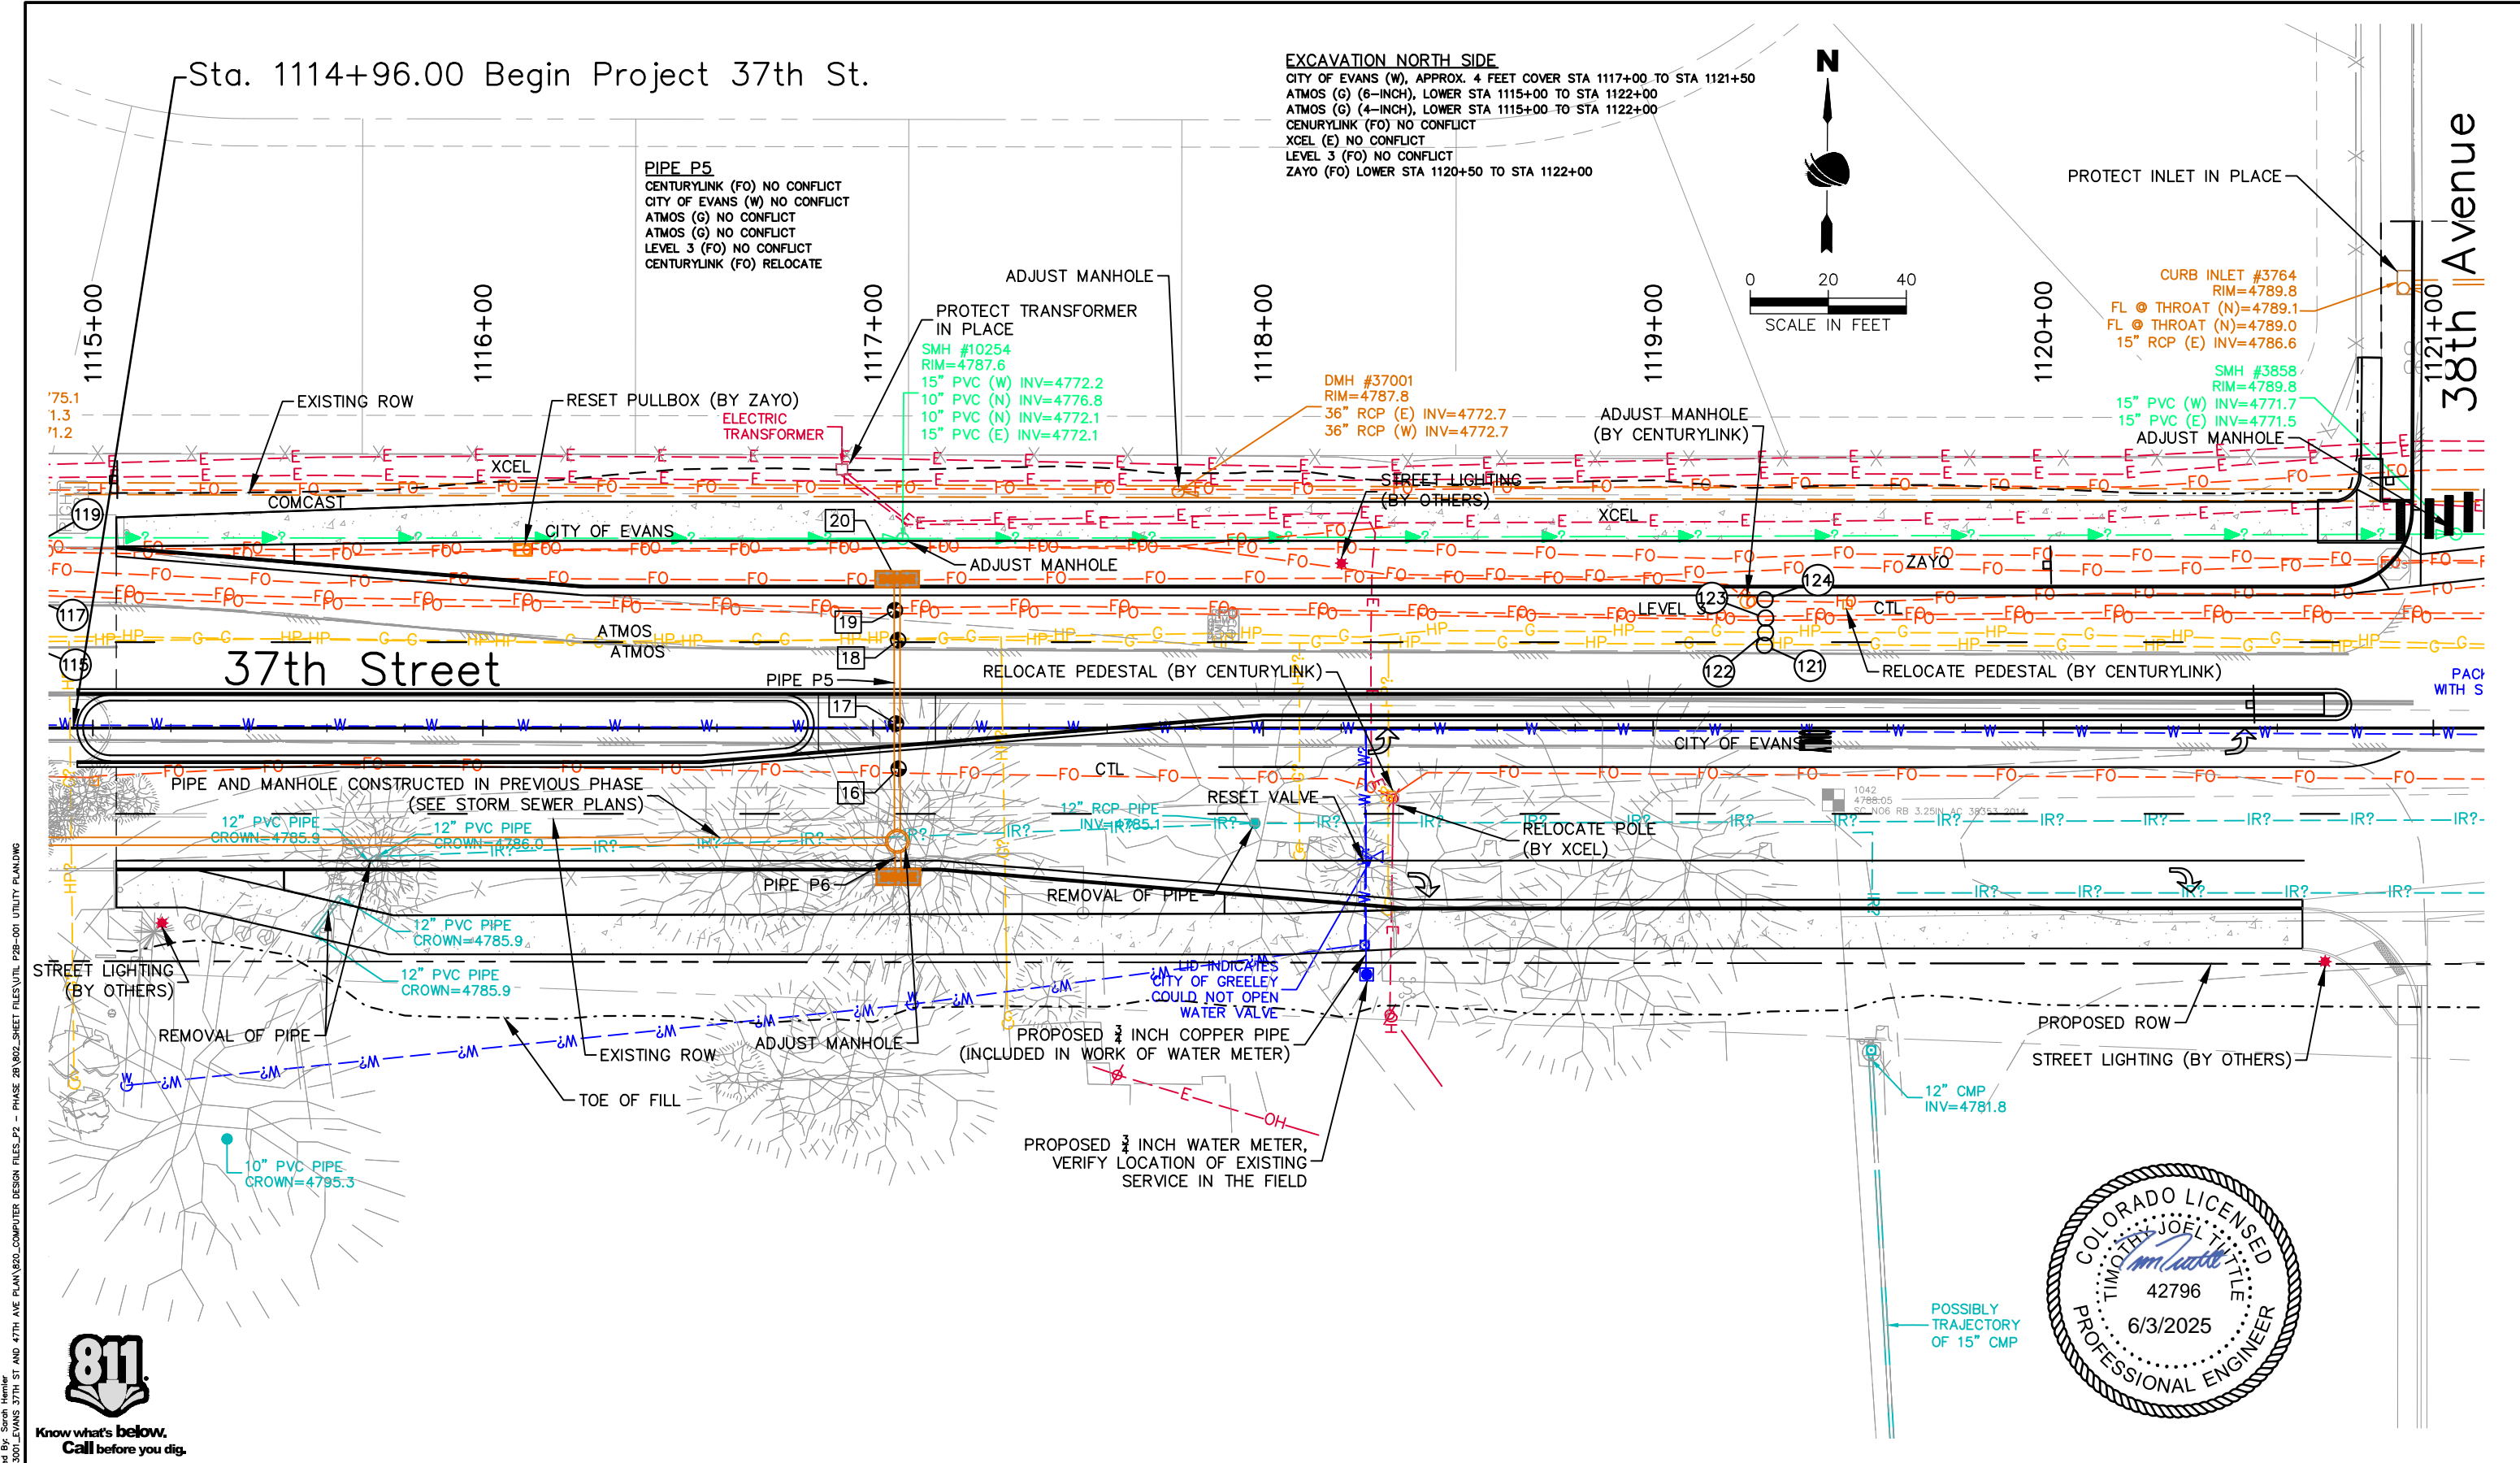Drawing Number UTIL-001

Sheet Number 56

FOR CONSTRUCTION 5/1/2025

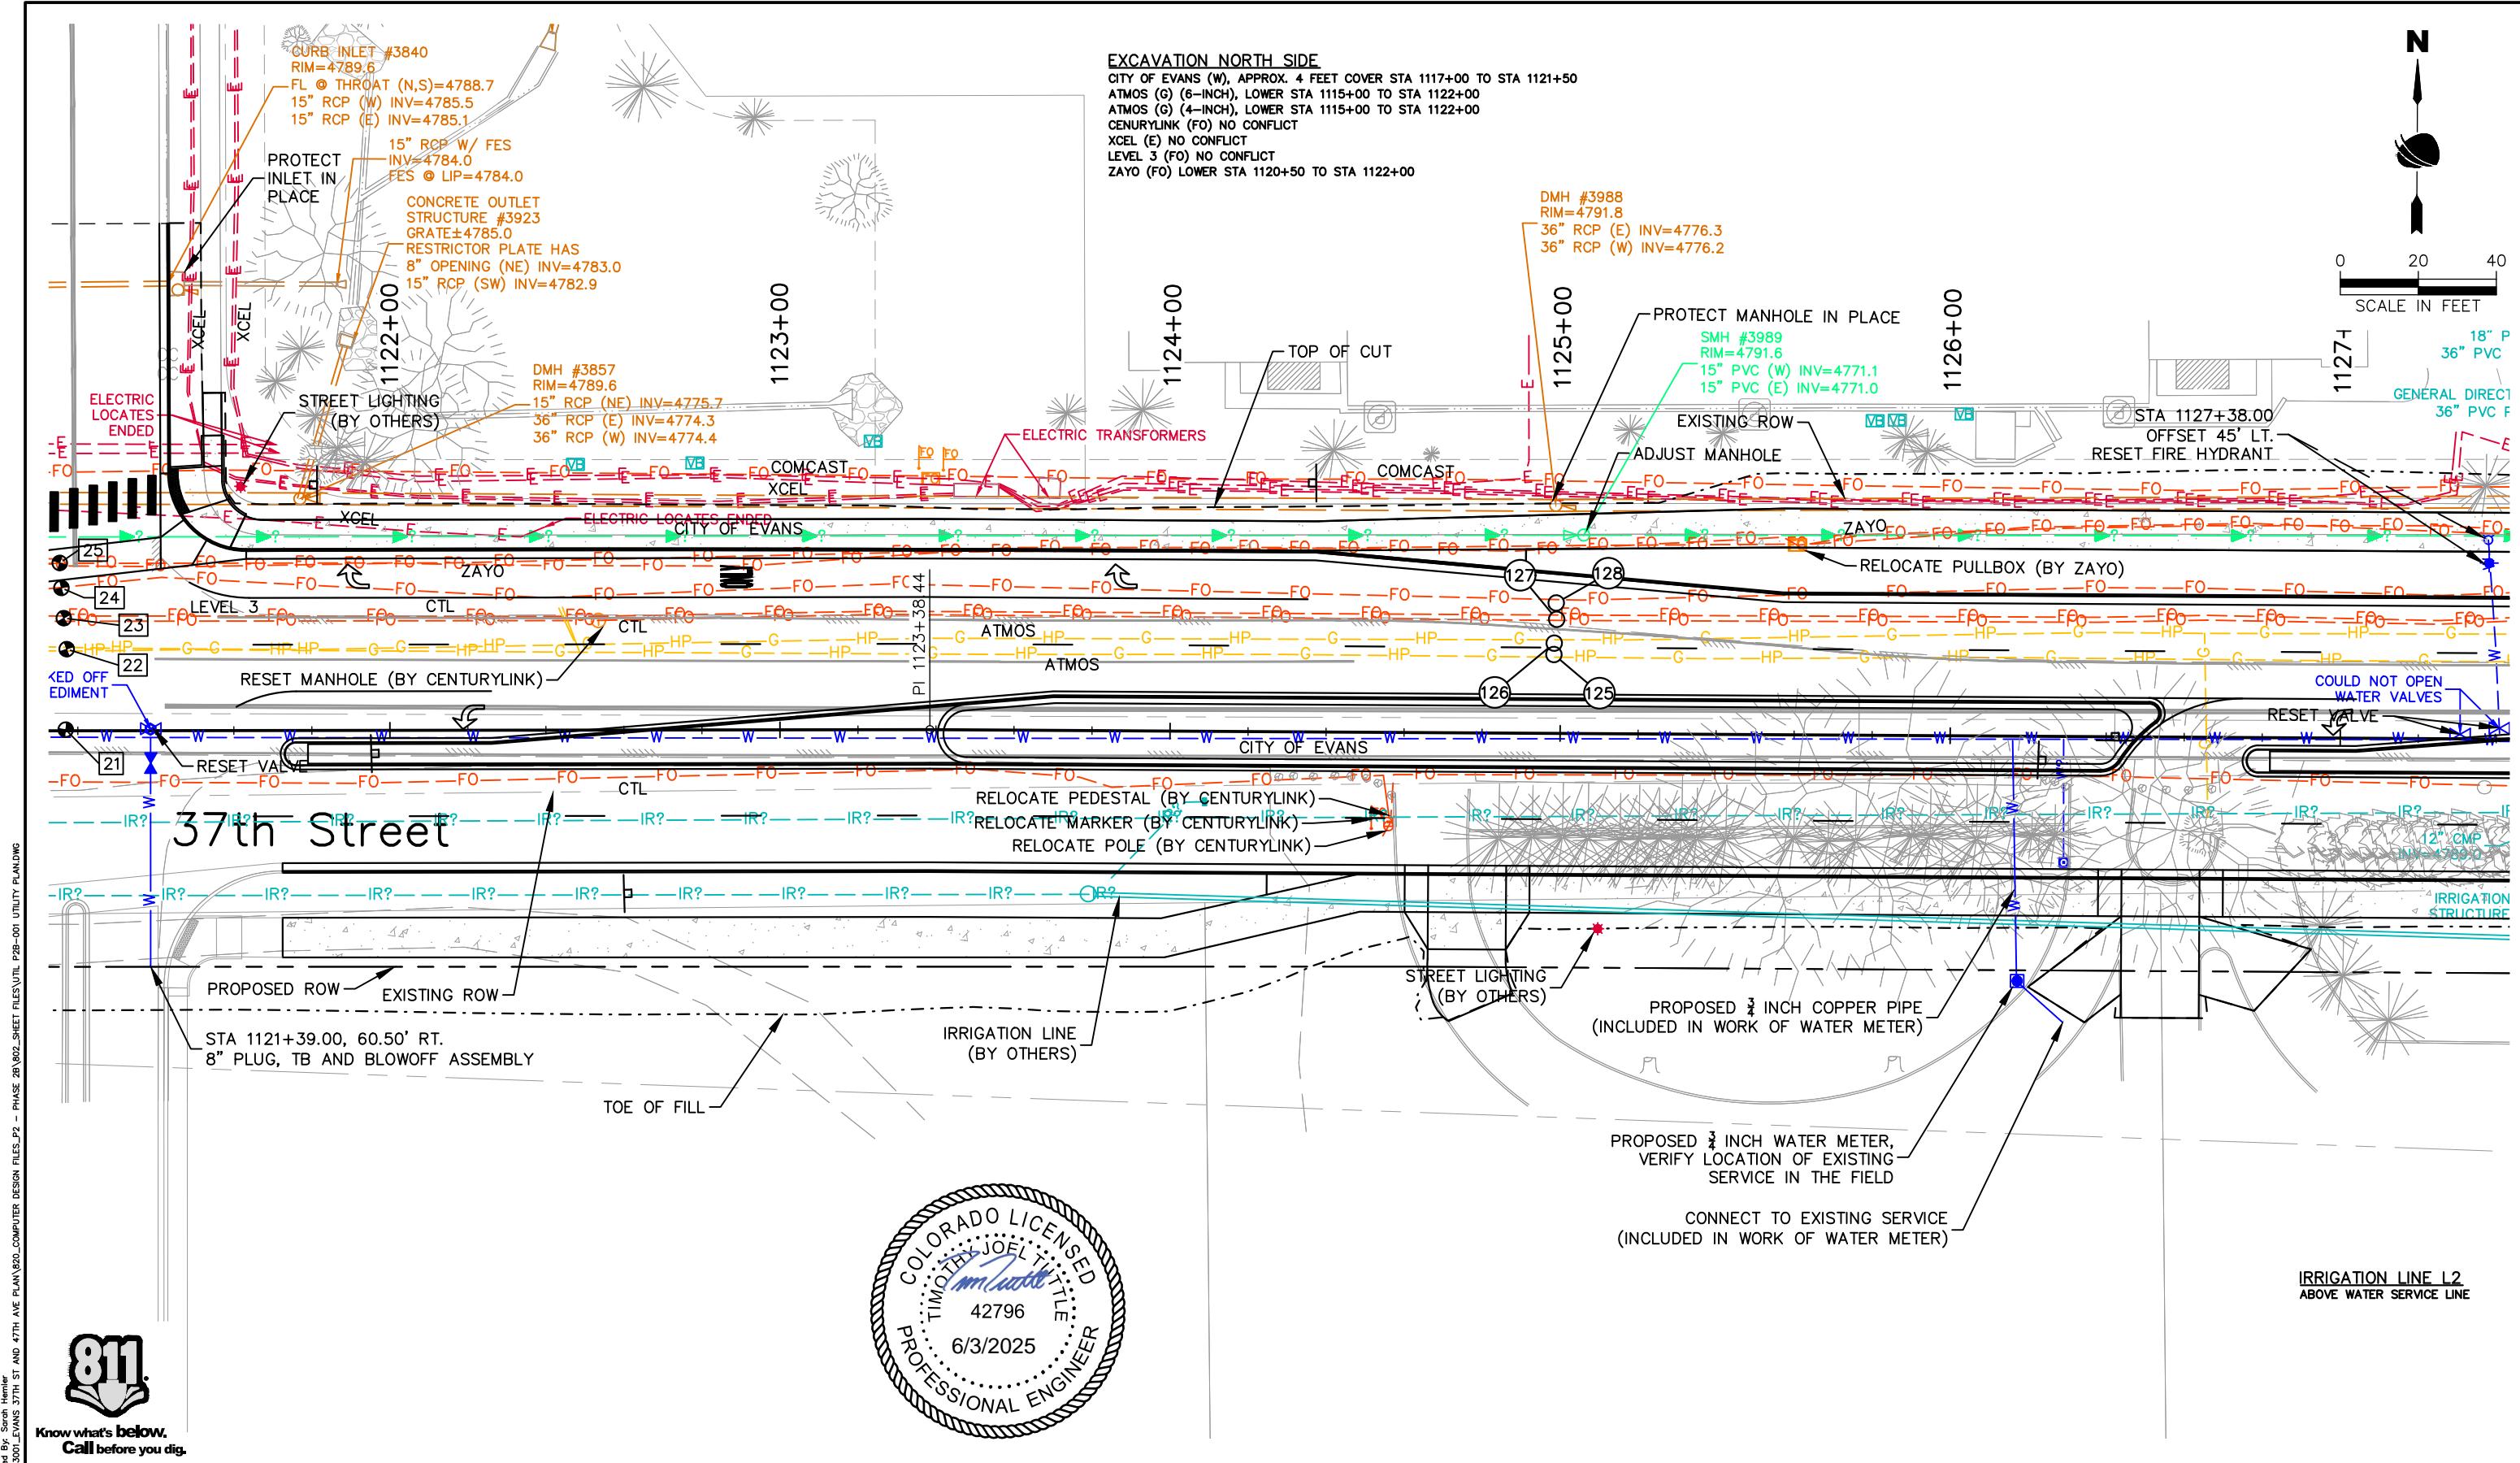

811

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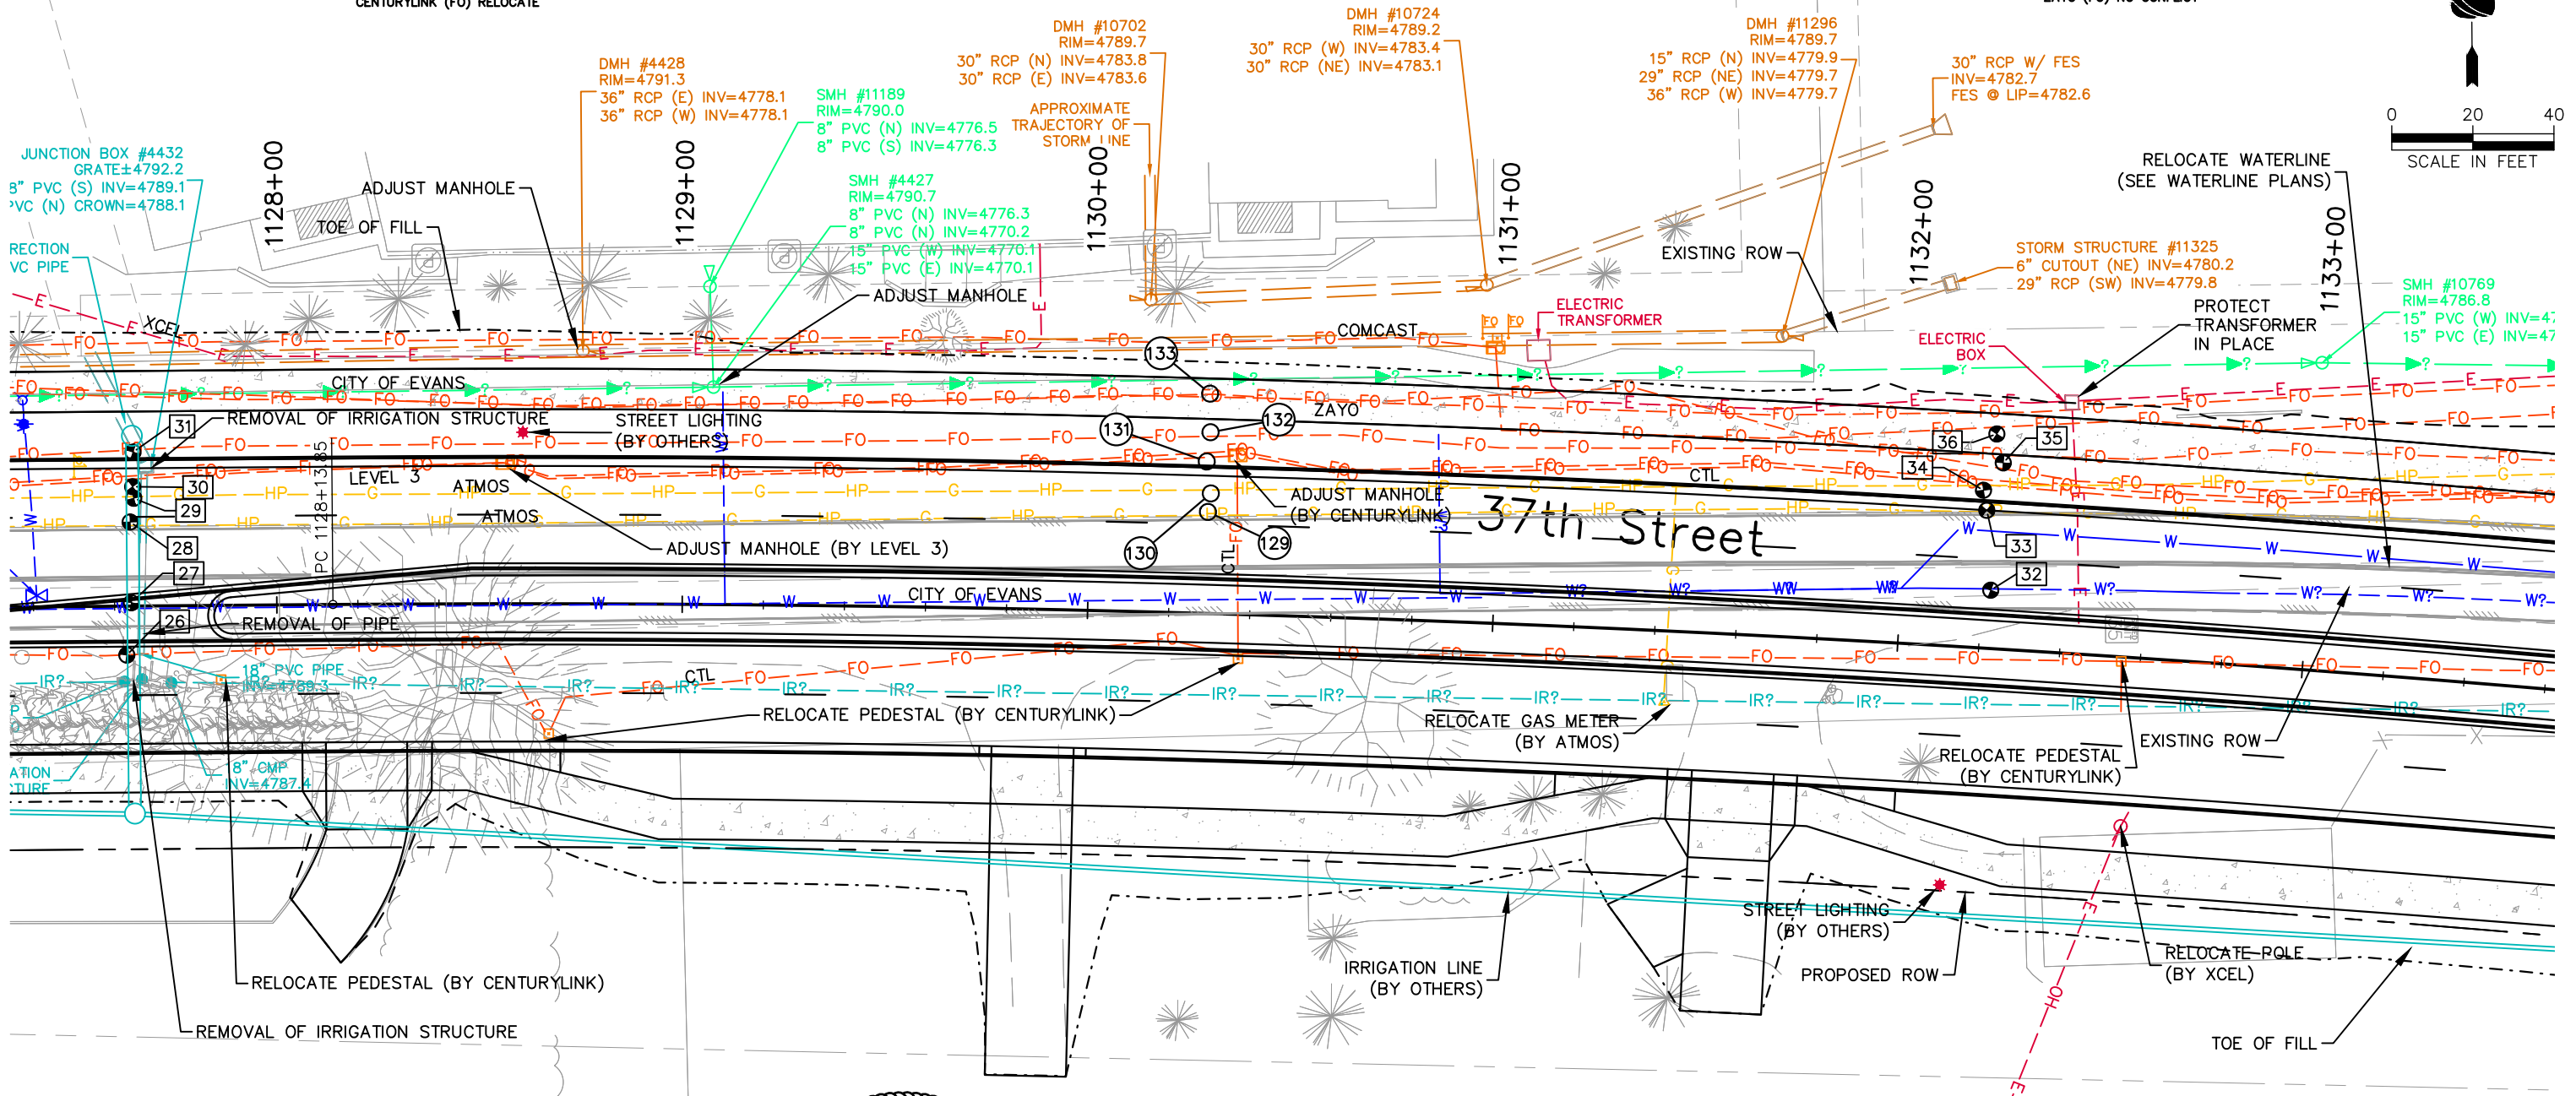
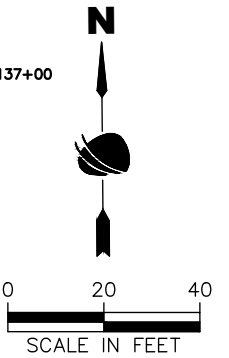
37TH STREET WIDENING PHASE 2B UTILITY PLANS		
Designer:	R. Parks	Structure Numbers
Detailer:	R. Parks	
Sheet Subset:	UTILITIES	Subset Sheets: 2 of 4

Project No.
37TH STREET 2B
Drawing Number UTIL-002
Sheet Number 57

FOR CONSTRUCTION 5/1/2025

IRRIGATION LINE
CENTURYLINK (FO) NO CONFLICT
CITY OF EVANS (W) RELOCATE
ATMOS (G) NO CONFLICT
ATMOS (G) RELOCATE
LEVEL 3 (FO) RELOCATE
CENTURYLINK (FO) RELOCATE

EXCAVATION NORTH SIDE
CITY OF EVANS (W) (SEE WATERLINE PLANS)
ATMOS (G) (6-INCH), LOWER STA 1131+50 TO STA 1137+00
ATMOS (G) (4-INCH) NO CONFLICT
CENTURYLINK (FO) NO CONFLICT
XCEL (E) NO CONFLICT
ZAYO (FO) NO CONFLICT



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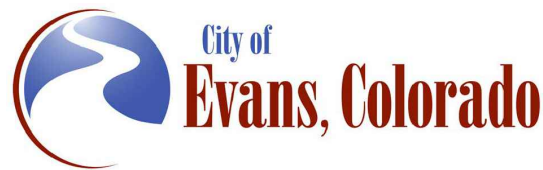
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37TH STREET WIDENING PHASE 2B UTILITY PLANS

Designer:	R. Parks	Structure	
Detailer:	R. Parks	Numbers	
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Project No.

37TH STREET 2B

Drawing Number UTIL-003

Sheet Number 58

FOR CONSTRUCTION 5/1/2025

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STORMWATER MANAGEMENT PLAN

1. SITE DESCRIPTION

The Contractor shall comply with all contractual requirements and all requirements associated with the CDPS-SCP on this project. The SWMP Administrator for Construction shall update to reflect current project site conditions.

- A. PROJECT SITE LOCATION: The project is located along 37th Street between Stampede Drive to the intersection at 35th Street.
- B. PROJECT SITE DESCRIPTION: The project will include roadway widening from two lanes to four lanes, raised medians, curb and gutter, landscaping, extended sidewalks, and storm sewer system with offsite outfall to Ashcroft Draw.
- C. PROPOSED SEQUENCING FOR MAJOR CONSTRUCTION ACTIVITIES: Construction activities include, clearing and grubbing, grading, drainage improvements, and landscaping. Construction will begin with installation of initial control measures before clearing and grubbing. Followed by grading activities, paving, signing and striping, median landscaping, and permanent revegetation.
- D. ACRES OF DISTURBANCE:

1. Total area of construction site (LOC (PERMITTED AREA)): 8.9 acres

2. Total area of proposed disturbance (LDA): 8.1 acres

3. Total area of seeding: 2.1 acres
- E. EXISTING SOIL DATA: Dominant site soils consist of Otero sandy loam and Aquolls and Aquents, gravelly substratum. Other small percentages include Otero sandy loam, Kim loam soil types, and Vona loamy sand. Otero soil type consists of Hydrologic Soil Group A, with a very low surface runoff potential. Aquolls and Aquents soil type consists of Hydrologic Soil Group D, with a high surface runoff potential when thoroughly wet.

Data Source: <https://websoilsurvey.sc.egov.usda.gov/App/HomePage.htm>

F. EXISTING VEGETATION, INCLUDING PERCENT COVER:
A survey including general description of existing vegetation shall be conducted by the SWMP Administrator for Construction prior to any ground disturbance on the project. The SWMP Administrator shall photo-document existing vegetation where all work will be occurring.

G. POTENTIAL POLLUTANTS SOURCES: See First Construction Activities under Potential Pollutant Sources. The SWMP Administrator for Construction shall prepare a list of all potential pollutants and their locations in accordance with subsection 107.25 of CDOT Standards and Specifications.

- H. RECEIVING WATER:

1. Outfall locations: This project outfalls to the City of Evans MS4

2. Names of immediate receiving water(s) on site: Unnamed roadside ditches

3. Ultimate receiving water(s): Ashcroft Draw, South Platte River

4. Horizontal distance to nearest ultimate receiving water from project: Approximately 0.2 miles to Ashcroft Draw and approximately 1.6 miles to South Platte River

5. Description of all stream crossings located within the Construction Site Boundary: Not applicable

I. NON-STORMWATER DISCHARGES: SWMP Administrator for Construction shall provide a method statement of how discharge will be handled.

Discharge Description	Location (Site Map #)	Method Statement (Location)
Dewatering*		
Uncontaminated Spring		
Concrete Wash Water (in-ground washout structure)		
Landscape Irrigation Return Flows		
Emergency Fire Fighting		
Concrete Saw Water		

ALLOWABLE: Refer to CDPHE Low Risk Discharge Guidance Document of Uncontaminated Groundwater to Land.
<https://www.colorado.gov/pacific/sites/default/files/WQ%20LOW%20RISK%20GW.pdf>

*If ground water does not meet water quality standards for receiving water a separate CDPS Dewatering Permit shall be obtained by the Contractor from CDPHE in accordance with subsections 107.02 and 107.25 of CDOT Standards and Specifications.

2. SITE MAP COMPONENTS:

Pre-construction

- A. PROJECT CONSTRUCTION POTENTIAL SITE BOUNDARIES – See SWMP Site Maps
- B. ALL AREAS OF GROUND SURFACE DISTURBANCE – See SWMP Site Maps
- C. AREAS OF CUT AND FILL – See SWMP Site Maps
- D. LOCATION OF ALL STRUCTURAL CONTROL MEASURES IDENTIFIED IN THE SWMP – See SWMP Site Maps
- E. LOCATION OF NON-STRUCTURAL CONTROL MEASURES AS APPLICABLE IN THE SWMP – See SWMP Site Maps
- F. STREAMS, SPRINGS, WETLANDS AND OTHER STATE WATERS, INCLUDING AREAS THAT REQUIRE PRE-EXISTING VEGETATION BE MAINTAINED WITHIN 50 FEET OF A RECEIVING WATER – Not applicable
- G. PROTECTION OF TREES, SHRUBS AND CULTURAL RESOURCES – See Landscape Plans and Tree Protection Notes in Landscape Plans
- H. FLOW ARROWS THAT DEPICT STORMWATER FLOW DIRECTIONS ON-SITE AND RUNOFF DIRECTION – See SWMP Site Maps
- I. AREAS USED FOR STORING AND STOCKPILING MATERIALS, STAGING AREAS (field trailer, fueling, etc.) WASTE ACCUMULATION AND BATCH PLANTS INCLUDING MASONARY MIXING STATIONS – See SWMP Site Maps
- J. LOCATIONS OF ALL STREAM CROSSINGS LOCATED WITHIN THE CONSTRUCTION SITE BOUNDARY – See SWMP Site Maps

3. QUALIFIED STORMWATER MANAGERS:

A. SWMP ADMINISTRATOR FOR DESIGN:

Name/Title	Contact Information	CDOT SWMP Preparer Certification #
Jovonna Kirkling/Environmental Specialist	kirkling@rocksol.com/303-913-2193	2FE4F476


B. SWMP Administrator for Construction: (As defined in Section 208 of CDOT Standards and Specifications) The Contractor shall designate a SWMP Administrator for Construction upon co-permittee of the permit. The SWMP Administrator for Construction shall become the operator for the SWMP and assume responsibility for all design changes to the SWMP implementation and maintenance in accordance to subsection 208.03 of the CDOT Standards and Specifications. The SWMP Administrator for Construction shall be responsible for implementing, maintaining and revising SWMP, including the title and contact information. The activities and responsibilities of the SWMP Administrator for Construction shall address all aspects of the project's SWMP. (Update the information below for each new SWMP Administrator for Construction).

Print Date: 5/2/2025

File Name: ENVI P2B-001 SWMP NARRATIVE.DWG


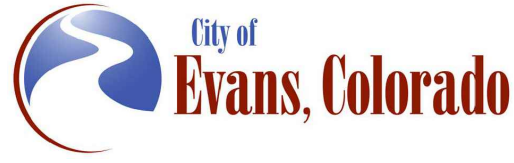
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37TH STREET WIDENING PHASE 2B
STORMWATER MANAGEMENT PLAN
SWMP NARRATIVE

Designer: J. Kirkling

Detailer: J. Kirkling

Sheet Subset: SWMP

Structure Numbers

Subset Sheets: 1 of 18

Project No.

37TH STREET 2B

Drawing Number ENVI-001

Sheet Number 60

Name/Title	Contact Information (phone & email)	CDOT TECS Certification #	Start Date	Engineer Approval

C. **EROSION CONTROL INSPECTOR:** (As defined in Section 208 of CDOT Standards and Specifications)
The Contractor may designate an Erosion Control Inspector. The Erosion Control Inspector shall complete duties in accordance with subsection 208.03(c)of CDOT Standards and Specifications.

Name/Title	Contact Information (phone & email)	CDOT TECS Certification #	Start Date	Engineer Approval

4. STORMWATER MANAGEMENT CONTROLS FIRST CONSTRUCTION ACTIVITIES

THE CONTRACTOR SHALL PERFORM THE FOLLOWING:

A. **POTENTIAL POLLUTANT SOURCES**

Evaluate, identify, locate and describe all potential sources of pollutants at the site in accordance with subsection 107.25 of CDOT Standards and Specifications, CDPS-SCP and place in the SWMP. All control measures related to potential pollutants shall be shown on the SWMP Site Map by the Contractor's SWMP Administrator for Construction.

B. **OFFSITE DRAINAGE (RUN ON WATER)**

1. Describe and record control measures on the SWMP Site Map that have been implemented to address off site run-on water in accordance with subsection 208.03 of CDOT Standards and Specifications.

C. **VEHICLE TRACKING CONTROL STRIP**

1. Control measures shall be implemented in accordance with Section 2.01.10 of City of Evans Standards and Specifications.

D. **PERIMETER CONTROL**

1. Perimeter control shall be established as the first item on the SWMP to prevent the potential for pollutants leaving the construction site boundaries, entering the stormwater drainage system, or discharging to state waters. Perimeter control shall be in accordance with subsection 208.04 of CDOT Standards and Specifications.
2. Perimeter control may consist of berms, silt fence, erosion logs, existing landforms, or other control measures as approved.

5. DURING CONSTRUCTION

RESPONSIBILITIES OF THE SWMP Administrator for Construction

The SWMP is a "living document" that is continuously reviewed and modified throughout the construction phasing. During construction, the following items shall be added, updated, or amended as needed by the SWMP Administrator for Construction in accordance with subsection 208.03 of CDOT Standards and Specifications. During construction, indicate how items that have not been addressed during design are being handled in construction.

A. **STOCKPILE MANAGEMENT:** Shall be done in accordance with Section 2.01.10 of City of Evans Standards and Specifications.

B. **CONCRETE WASHOUT:** Concrete wash out water or waste from field laboratories and paving equipment shall be contained in accordance with subsection 208.05 of CDOT Standards and Specifications.

C. **SAW CUTTING:** Shall be done in accordance with subsections 107.25, 208.04, and 208.05 of CDOT Standards and Specifications.

D. **STREET SWEEPING:** Shall be done in accordance with subsection 208.04 of CDOT Standards and Specifications.

6. INSPECTIONS

A. Inspections shall be in accordance with Section 2.01.06 of City of Evans Standards and Specifications and subsection 208.03(c) of CDOT Standards and Specifications.

7. CONTROL MEASURE MAINTENANCE

A. Maintenance shall be in accordance with Section 2.01.10 of City of Evans Standards and Specifications and subsection 208.04(f) of CDOT Standards and Specifications.

8. RECORD KEEPING

A. Records shall be kept in accordance with subsection 208.03(d) of CDOT Standards and Specifications.

9. INTERIM, PERMANENT STABILIZATION, and LONG-TERM STORMWATER MANAGEMENT

The Contractor shall comply with all interim stabilization and permanent stabilization requirements in accordance with Section 2.01.11 of City of Evans Standards and Specifications.

A. **SEEDING PLAN**

Seeding will be required for an estimated total of 2.4 acres of disturbed area within the right-of-way limits which are not surfaced. The following types and rates shall be used:

Type I Seed Mix: For use in ground surface disturbance between curb and sidewalk, areas shown on site maps.

COMMON NAME	BOTANICAL NAME	LBS. PLS PER ACRE
buffalograss	<i>Buchloe dactyloides</i>	13.2
blue grama grass	<i>Bouteloua gracilis</i>	8.8
TOTAL		22.0

Type II Seed Mix: Short grass for use in all other ground surface disturbances including, from sidewalk to edge of cut/fill areas. Areas shown on site maps. Refer to Landscaping Plans for ornamental tree/shrub plantings within these areas.

COMMON NAME	BOTANICAL NAME	% LBS. PLS PER ACRE (11 LBS. PER ACRE)
blue grama grass	<i>Bouteloua gracilis</i>	3.0
Sideoats grama	<i>Bouteloua curtipendula</i>	3.0
little bluestem (Pastura, Blaze)	<i>Schizachyrium scoparium</i>	2.8
sand dropseed	<i>Sporobolus cryptandrus</i>	1.1
sand lovegrass (Nebraska 27)	<i>Eragrostis trichoides</i>	1.1
TOTAL		11.0

B. **SEEDING APPLICATION:** Drill seed 0.25 inch to 0.75 inch into the soil at the specified PLS per acre rate with a mechanical grass drill with depth bands and an agitator in the seed box. Rows shall be spaced not more than seven inches apart in accordance with Section 2.01.11 of City of Evans Standards and Specifications. In small areas not accessible to a drill, hand broadcast or hydroseed at double the PLS rate per acre and rake 0.25 inch to 0.5 inch into the soil per Section 212 of CDOT Standards and Specifications.

C. **MULCHING APPLICATION:** Apply a minimum of 4,000 pounds of certified weed free straw per acre and in accordance with Chapter 2 of City of Evans Standards and Specifications, and mechanically crimp it into the soil in combination with an organic mulch tackifier.

1. Prior to winter shutdown or the summer seeding window closure: Uncompleted slopes shall be mulched with 2 tons of mulching (weed free straw) per acre, mechanically crimped into the topsoil in combination with an organic mulch tackifier in accordance with Sections 208 and 213 of CDOT Standards and Specifications.


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
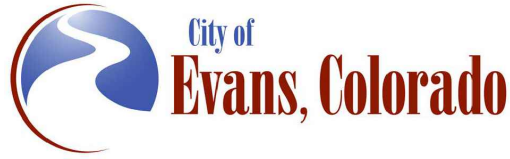
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37TH STREET WIDENING PHASE 2B
STORMWATER MANAGEMENT PLAN
SWMP NARRATIVE

Designer: J. Kirkling

Detailer: J. Kirkling

Sheet Subset: SWMP

Structure Numbers

Subset Sheets: 2 of 18

Project No.

37TH STREET 2B

Drawing Number ENVI-002

Sheet Number 61

- D. SPECIAL REQUIREMENTS:
1. Due to high failure rates, hydroseeding will not be allowed for permanent stabilization.
- E. SOIL AMENDMENTS REQUIREMENTS: Minimum amendment material requirements for all disturbances to receive seeding.
1. Compost shall be applied at 4 CY per 1000 SF over the designated areas in accordance with Section 2.01.11 of City of Evans Standards and Specifications.
- F. SOIL RETENTION COVERING: On slopes and ditches requiring a blanket or turf reinforcement mat (trm), the blanket/trm shall be placed in lieu of mulch and mulch tackifier and placed after seeding (native). See SWMP Site Map for blanket/trm locations.
- G. RESEEDING OPERATIONS/CORRECTIVE STABILIZATION:
Prior to partial acceptance.
1. Bare areas caused by surface or gully erosion, blown away mulch, etc. shall be re-graded, seeded, and have the designated mulching applied as necessary, at no additional cost to the project.

10. PRIOR TO PROJECT FINAL ACCEPTANCE

- A. Partial Acceptance shall be in accordance with Section 2.01.10 of City of Evans Standards and Specifications and subsections 107.25 (d), 208.10 and 214.04 of CDOT Standards and Specifications. At the Partial Acceptance of the project, it shall be determined by the SWMP Administrator for Construction and the Engineer which temporary control measures shall remain until 80% revegetation is established or which shall be removed.
- B. At the end of the project, all ditch checks shall either consist of temporary erosion logs (or equivalent) or permanent riprap.

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
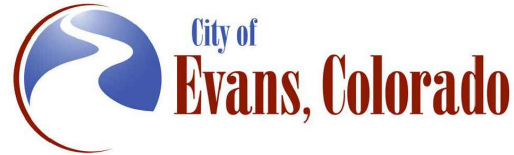
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No Revisions:				37TH STREET 2B
Revised:	Designer: J. Kirkling	Structure		Drawing Number ENVI-003
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Sheet Subset: SWMP		Subset Sheets: 3 of 18	Sheet Number 62	

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11. NARRATIVES:

Control Measure Matrixes During Construction:

1. Control measure narratives have been included for the CDOT Standard Specifications and Standard Plan M-208 and M-216 along with any non-standard control measures approved during the design process. If a Non-Standard Control Measure not included in the SWMP is proposed and approved by the Engineer the SWMP Administrator for Construction shall do the following: Place an "X" in the column for non-standard and complete a Non-Standard Control Measure Specification and Narrative covering the what, when, where and why the control measure is being used shall be add to the SWMP. The appropriate "X" shall also be added to the implementation phase(s).
2. The SWMP Administrator for Construction shall place an "X" in the column In Use on-site when the control measure has been installed.
3. A "P" in the Initial Activities Column indicates that the control measure shall be installed before construction activity starts. Locations and quantities will be discussed during the Environmental Pre-construction Conference with the Regional Water Pollution Control Manager.

STRUCTURAL Control Measures that may be potentially used on the project for erosion and sediment control; practices may include, but are not limited to the following:

APPLICATION, CONTROL MEASURE	NARRATIVE	M- 208 STANDARD or "X" for NON- STANDARD	IN USE ON SITE	CONTROL MEASURE IMPLEMENTATION PHASE		
				INITIAL ACTIVITIES	INTERIM ACTIVITIES	PERMANENT STABILIZATION
PROTECTION OF EXISTING WETLANDS Fence (plastic) and erosion logs	Fence (plastic) shall be placed in combination with erosion logs to prevent encroachment of construction traffic and sediment into state waters prior to start of construction disturbances. Fence (plastic) shall be placed adjacent to the wetlands; erosion logs shall be placed between the plastic fence and disturbance area. Logs shall be placed to direct flows away from or filter water running into wetlands from disturbance areas.			P	X	
PROTECTION OF EXISTING TREES/LANDSCAPING Fence (plastic)	Fence (plastic) shall be used in areas indicated in the plans to prevent encroachment of construction traffic and sediment for the protection of mature trees and/or existing landscaping prior to start of construction disturbances.			P or X	X	
CHECK DAM/DITCH CHECK Erosion log, silt berm, silt dike, rock check dam	Placed in ditches immediately upon completion of ditch grading to reduce velocity of runoff in ditch. For existing ditches, place prior to start of construction disturbances.	M-208		X	X	
STORM DRAIN INLET PROTECTION IN PAVED ROADWAYS (Type 1, 2 and 3 as shown on M-208-1, sheet 5 of 11)	Manufactured storm drain inlet protection placed prior to construction disturbances as detailed in M-208-1, to protect existing inlets or immediately upon completion of new inlets to prevent sediment from entering the inlet throughout construction.	M-208		P or X	X	X
STORM DRAIN INLET PROTECTION IN NATIVE SEED AREAS (M-604 Standard Inlets Type C and D)	Erosion logs or aggregate bags placed around inlet grate to prevent sediment from entering inlet. Place prior to construction disturbances to protect existing inlets or immediately upon completion of new inlets.	M-208		P or X		
CULVERT INLET/OUTLET PROTECTION Erosion logs, aggregate bags	Placed at mouth of culvert inlets and over top of culvert at inlet and outlet where disturbance may be occurring adjacent to pipe to prevent sediment laden water from entering pipe or drainage. Place prior to start of construction disturbances.	M-208		P	X	X
TYPE C, TYPE D, AND TYPE 13 PROTECTION Erosion logs, aggregate bags, erosion bales	Placed around inlet grate or slope and ditch paving to prevent sediment from entering inlet. Place prior to start of construction disturbances.	M-208		P	X	X
STOCKPILE PROTECTION Temporary berm, erosion logs, aggregate bags*	Placed within specified distance, in accordance with subsection 208.06, from toe to contain sediment around stockpile. *Aggregate bags are easily moved and replaced for access during the work day. Place prior to start of stockpile, increase control as stockpile increases size.	M-208			X	
TOE OF FILL PROTECTION Erosion logs, temporary berm, silt fence, topsoil windrow*	Place prior to slope/embankment work to capture sediment and protect and delineate undisturbed areas. *Can be used to stockpile topsoil for salvage.	M-208		X	X	
PERIMETER CONTROL Erosion logs, silt fence, temporary berm, topsoil windrow*	Placed prior to construction commencing to address potential run-on water from off site, and to divert around disturbed area. *Can be used to stockpile topsoil for salvage.	M-208		P or X	X	
SEDIMENT CONTROL/SLOPE CONTROL Silt fence, erosion logs	Placed on the contour of a slope to contain and slow down construction runoff. Place prior to start of construction disturbances.	M-208		X	X	
TEMPORARY SEDIMENT TRAP	Used to capture sediment laden runoff from disturbed areas < 5 acres during construction. Place prior to start of construction disturbances. Outlets that withdraw water from or near the surface may be installed when discharging from basins and impoundments.	M-208		X	X	
EMBANKMENT PROTECTION OR TEMPORARY SLOPE DRAIN	Placed as a conduit or chute to drain runoff down slope and to prevent erosion of slope.	M-208			X	X
OUTLET PROTECTION Riprap, or approved other	Material placed as energy dissipator to prevent erosion at outlet structure.	M-601-12			X	X
CONCRETE WASHOUT In-ground or fabricated	Construction control, used for waste management of concrete and concrete equipment cleaning. Place prior to start of concrete activities.	M-208		X	X	
VEHICLE TRACKING PAD	Source control, placed to prevent tracking of sediment from disturbed area to offsite surface. Place prior to start of construction disturbances.	M-208		P	X	
ENGINEERED SEDIMENT BASIN	Constructed early in project, prior to storm sewer/ditches and in accordance with 208.05(p) to capture storm flow. Outlet structure and/or outfall shall be modified for temporary sediment control using an approved non-standard detail. Outlets that withdraw water from or near the surface shall be installed when discharging from basins and impoundments, unless infeasible			X	X	

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
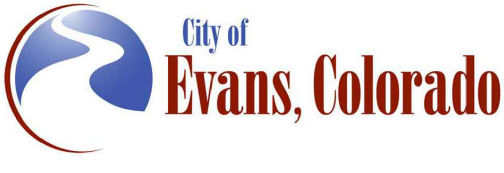
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37TH STREET WIDENING PHASE 2B
STORMWATER MANAGEMENT PLAN
SWMP NARRATIVE

Designer: J. Kirkling

Detailer: J. Kirkling

Sheet Subset: SWMP

Structure Numbers

Subset Sheets: 4 of 18

Project No.

37TH STREET 2B

Drawing Number ENVI-004

Sheet Number 63

Plot Date: 5/2/2025 6:49 AM Plotted By: Sarah Hemler
C:\Q-PROJECTS\WASTE PROJECTS\33001\EVANS\37TH ST AND 47TH AVE PLAN\302-COMPUTER DESIGN FILES\DWG - PHASE 2B\302-SHEET FILES\ENV P2B-001 SWMP NARRATIVE.DWG

DEWATERING (Contractor is responsible for obtaining a permit from Colorado Department of Health and Environment.)	Shall be done in such a manner to prevent potential pollutants from entering state waters.			X	X	
TEMPORARY STREAM CROSSING	Constructed over stream or drainage to prevent discharge of pollutants from construction equipment into water.					
CLEAN WATER DIVERSION	Placed to divert clean surface or ground water around disturbance area to prevent it from mixing with construction runoff.					
OTHER						

NON-STRUCTURAL Control Measures that may be potentially used on the project for erosion and sediment control; practices may include, but are not limited to:
Erosion control devices are used to limit the amount of soil loss on site. Sediment control devices are designed to capture sediment on the project site. Construction controls are control measures related to construction access and staging. Control Measure locations are indicated on the SWMP Site Map.

*** Use of vegetative buffer strip requirements.** The CDPHE Water Quality Control Division Technical Memorandum dated August 27, 2015 clarifies the requirements for utilization of existing vegetation as a buffer type of sediment control measure, while maintaining compliance with the CDPS permit for Stormwater Discharges Associated with Construction Activity – CDPS Permit No. COR4000000. In general, the division does not recommend that vegetated buffers be implemented as a sediment removal control measure for runoff from disturbed areas at construction sites, unless implemented as a “finishing” component of a treatment train comprised of additional, adequate up-gradient Control Measures. The entire memorandum can be found at: <https://www.colorado.gov/pacific/sites/default/files/Vegetative%20Buffer%20Memo.pdf>


APPLICATION, CONTROL MEASURE	NARRATIVE	M- STANDARD or “For NON- STANDARD	IN USE ON SITE	CONTROL MEASURE IMPLEMENTATION PHASE		
				INITIAL ACTIVITY	INTERIM ACTIVITIES	PERMANENT STABILIZATION
* VEGETATIVE BUFFER STRIP Fence (plastic)	Finishing component for filtering sediment-laden runoff from disturbance area. Area within CDOT ROW or temporary easement to be identified on SWMP prior to construction starting.					
GRADING APPLICATIONS (LANDFORM)	Existing or created landforms may be used as a control measure if they prevent sediment from entering or leaving the disturbance area. If a landform directs flow of water to a concentrated outfall point, the outfall point shall be protected to prevent erosion. Area to be identified on SWMP prior to construction starting.	M-208		X	X	
TOPSOIL MANAGEMENT STOCKPILE/SALVAGE Windrow or stockpile	Prior to any site disturbance work commencing, existing topsoil shall be scraped to a depth four inches, or as specified, and placed in stockpiles or windrows. Upon completion of final grading, topsoil shall be evenly distributed over embankment to a depth of four inches or as specified.	M-208		X	X	X
SURFACE ROUGHENING / GRADING TECHNIQUES	Temporary stabilization of disturbance and to minimize wind and erosion.				X	
SEEDING (TEMPORARY)	Temporary stabilization used for over wintering of disturbance or used to control erosion for areas scheduled for future construction.					
BONDED FIBER MATRIX or MULCHING (HYDRAULIC)	Not to be used in areas of concentrated flows, i.e. ditch lines. To be for either Interim or Permanent Stabilization placed as a surface cover for erosion control. May be used as surface cover when work is temporarily halted and as approved by the Engineer for stockpiles.					
STRAW or HAY MULCH/MULCH TACKIFIER	Interim or Permanent Stabilization placed as a surface cover for erosion control and or seeding establishment. To be installed as Interim Stabilization as a surface cover when work is temporarily halted and as approved by the Engineer				X	X
SPRAY-ON MULCH BLANKET (Not to be used in areas of concentrated flows, i.e. ditch lines.)	Interim or Final Stabilization placed as a surface cover for erosion control and or seeding establishment. To be installed as temporary surface cover when work is temporarily halted and as approved by the Engineer				X	X
SEEDING PERMANENT (NATIVE)	Final Stabilization of disturbance and to reduce runoff and control erosion on disturbed areas.					X
SOIL RETENTION BLANKET (SRB)	Final Stabilization of disturbance and to reduce runoff and control erosion on disturbed areas.	M-216				
TURF REINFORCEMENT MAT (TRM)	Final Stabilization of disturbance and to reduce runoff and control erosion on disturbed areas. Placed in channels or on slopes for erosion control, channel liner and seeding establishment.	M-216				
SWEEPING	Source control, used to remove sediment tracked onto paved surfaces and to prevent sediment from entering drainage system. Sweep daily and at the end of the construction shift as needed. Kick brooms shall not be permitted.			X	X	X

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
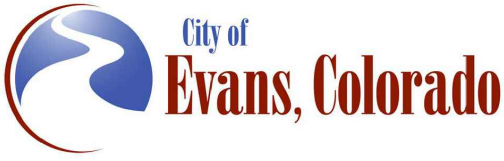
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Vert. Scale: N/A



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Sheet Revisions		
Date	Comments	Initials



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Revised:

Void:

37TH STREET WIDENING PHASE 2B
STORMWATER MANAGEMENT PLAN
SWMP NARRATIVE

Designer: J. Kirkling

Detailer: J. Kirkling

Sheet Subset: SWMP

Structure Numbers

Subset Sheets: 5 of 18

Project No.

37TH STREET 2B

Drawing Number ENVI-005

Sheet Number 64

Plot Date: 5/2/2025 6:49 AM Plotted By: Sarah Hemler
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12. TABULATION OF STORMWATER QUANTITIES

- A. Control Measure sediment removal and disposal shall be paid for as: 208 Removal and Disposal of Sediment (Equipment) and 208 Removal and Disposal of Sediment (Labor). All other control measure maintenance shall be included in the cost of the control measure.
- B. Establishment of seeded areas from Substantial Landscape Completion shall be included in the price of the work. This shall include mowing, weed control, reseeding/mulch/tackifier.

Pay Item	Description	Pay Unit	Initial Const.	Interim Const.	Permanent Stabilization	*Total Quantity
203-01500	Blading	Hour		20		20
203-01550	Dozing	Hour		20		20
207-00205	Topsoil	CY		751		751
208-00002	*Erosion Log (Type I)(12 inch)	LF	3100	500		3100
208-00035	*Aggregate Bag	LF		300		300
208-00046	Pre-fabricated Concrete Washout Structure (Type I)	Each	2			2
208-00053	Storm Drain Inlet Protection (Type I) (84 Inch)	Each	2	6		6
208-00054	Storm Drain Inlet Protection (Type II)	Each	3	1		3
208-00075	Pre-fabricated Vehicle Tracking Pad	Each	4	2		4
208-00103	Removal and Disposal of Sediment (Labor)	Hour		10		10

208-00105	Removal and Disposal of Sediment (Equipment)	Hour		10	10	20
208-00106	Sweeping (Sediment Removal)	Hour		20		20
208-00107	Removal of Trash	Hour		10		10
208-00207	Erosion Control Management (ECM)	LS	1			1
212-00006	**Seeding (Type I)	Acre			1.0	1.0
212-00022	**Seeding (Type II)	Acre			0.9	0.9
212-00032	**Soil Conditioning	Acre			1.9	1.9
213-00004	**Mulching (Weed Free Straw)	Acre			1.9	1.9
213-00012	Spray-on Mulch Blanket	Acre			1	1 (b)
213-00061	**Mulch Tackifier	LB			420	420
607-11525	Fence (Plastic)	LF		50		50

*It is anticipated that additional control measures and control measure quantities not shown on the SWMP Site Maps shall be required on the project for unforeseen conditions and replacement of items that are beyond their useful service life, see subsections 208.03 and 208.04 of CDOT Standards and Specifications. **Quantities for all control measures shown above are estimated and have been increased for unforeseen conditions and normal control measure life expectancy.** Quantities shall be adjusted according to the conditions encountered in the field as directed and approved by the Engineer. Payment shall be for the actual work completed and material used.
**An additional 10% was added to account for use of broadcast seeding in confined areas where drill seeding cannot be achieved.

13. BIOLOGIC IMPACTS and DEWATERING

- A. ENVIRONMENTAL IMPACTS:
- 1. Wetland Impacts: NO
 - 2. Stream Impacts: NO
 - 3. Threatened and Endangered Species: No species are anticipated to be impacted by the project.
- B. DEWATERING (Not Covered Under the CDPHE Low Risk Discharge Guidance Document of Uncontaminated Groundwater to Land):
- 1. Dewatering: Refer to other environmental permits in accordance with subsection 107.02 of CDOT Standards and Specifications.

14. NOTES

- (a). An additional 10% was added to account for replacement and maintenance of silt fence.
- (b). Spray-on Mulch Blanket was added for an as-needed basis.

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
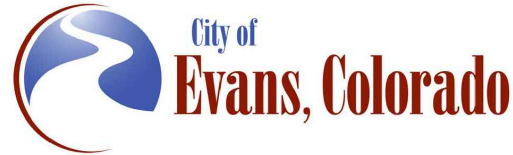
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37TH STREET WIDENING PHASE 2B
STORMWATER MANAGEMENT PLAN
SWMP NARRATIVE

Designer: J. Kirkling
Detailer: J. Kirkling
Sheet Subset: SWMP


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Subset Sheets: 6 of 18

Project No.

37TH STREET 2B

Drawing Number ENVI-006

Sheet Number 65

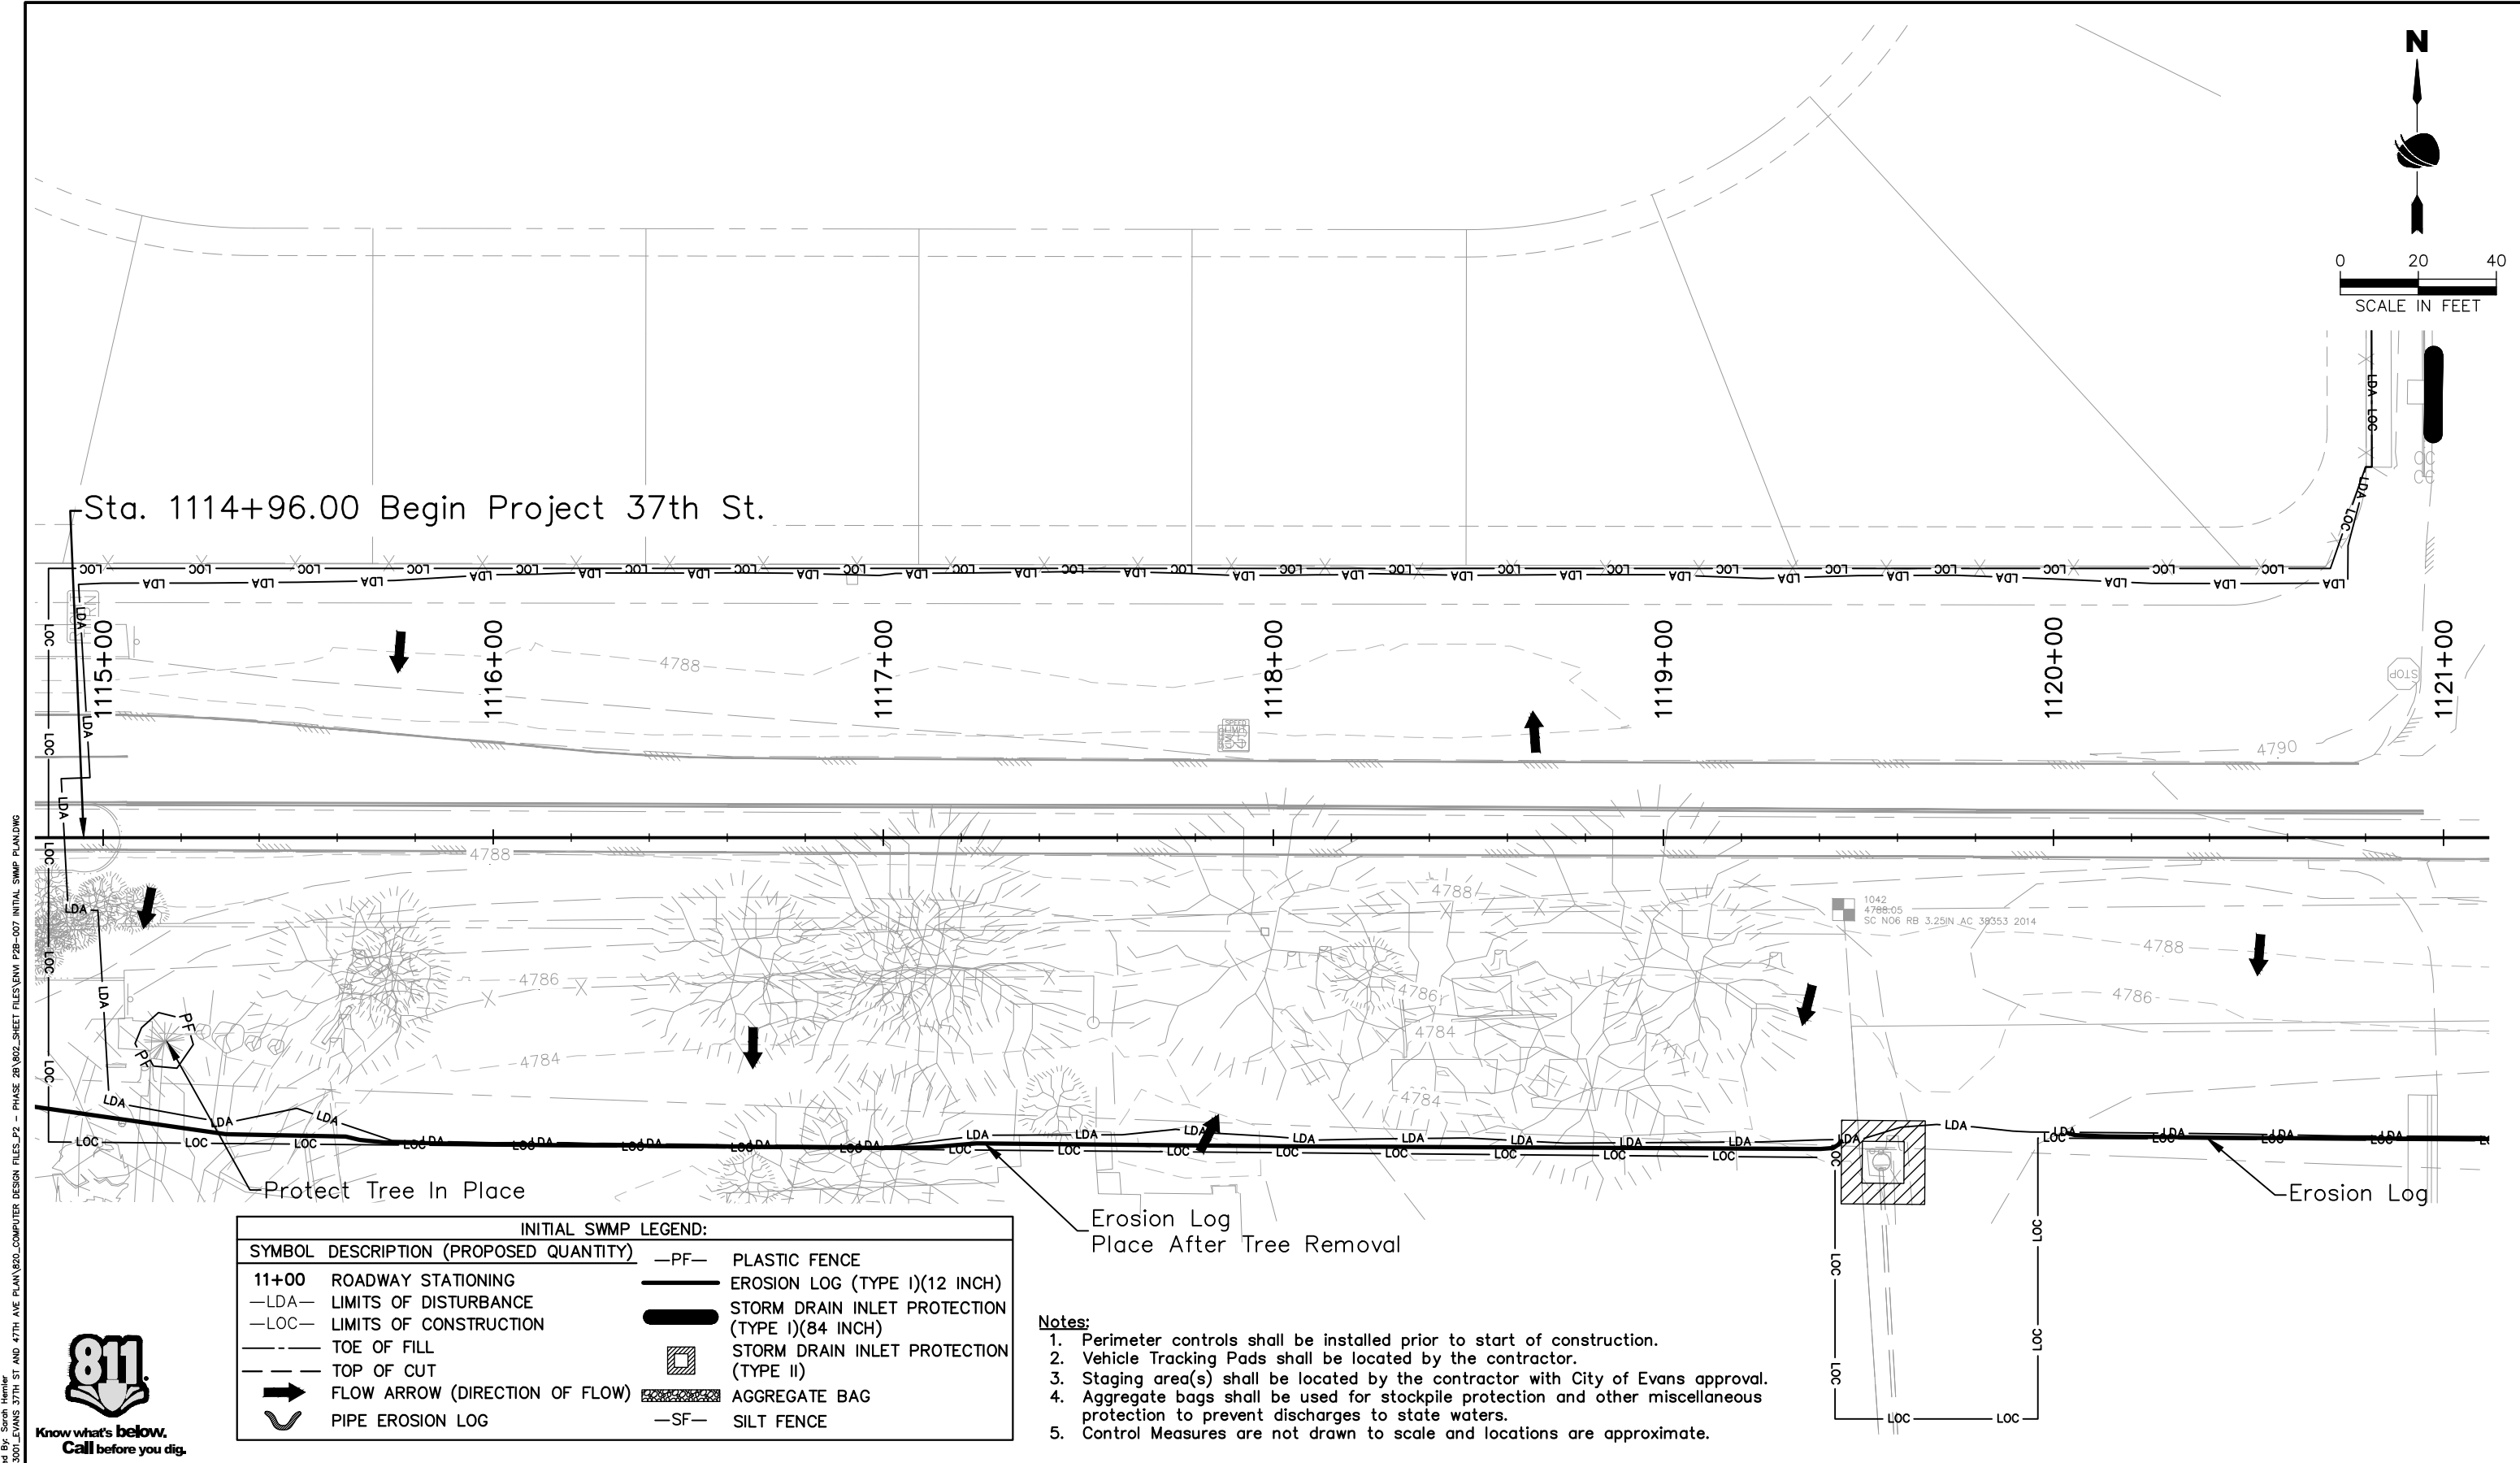

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City of Evans, Colorado

FREEDOM Parkway

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37TH STREET WIDENING PHASE 2B STORMWATER MANAGEMENT PLAN INITIAL SWMP SITE MAP	
Designer: J. Kirkling	Structure Numbers
Detailer: S. Hemler	
Sheet Subset: SWMP	Subset Sheets: 7 of 18

Project No.
37TH STREET 2B
Drawing Number ENVI-007
Sheet Number 66


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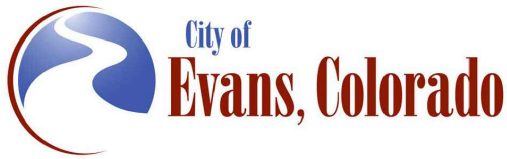
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Notes:

1. Perimeter controls shall be installed prior to start of construction.
2. Vehicle Tracking Pads shall be located by the contractor.
3. Staging area(s) shall be located by the contractor with City of Evans approval.
4. Aggregate bags shall be used for stockpile protection and other miscellaneous protection to prevent discharges to state waters.
5. Control Measures are not drawn to scale and locations are approximate.



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No Revisions:

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37TH STREET WIDENING PHASE 2B
STORMWATER MANAGEMENT PLAN
INITIAL SWMP SITE MAP

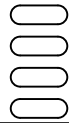
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Detailer:	S. Hemler	Numbers	
Sheet Subset:	SWMP	Subset Sheets:	8 of 18

Project No.

37TH STREET 2B


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Sheet Number 67

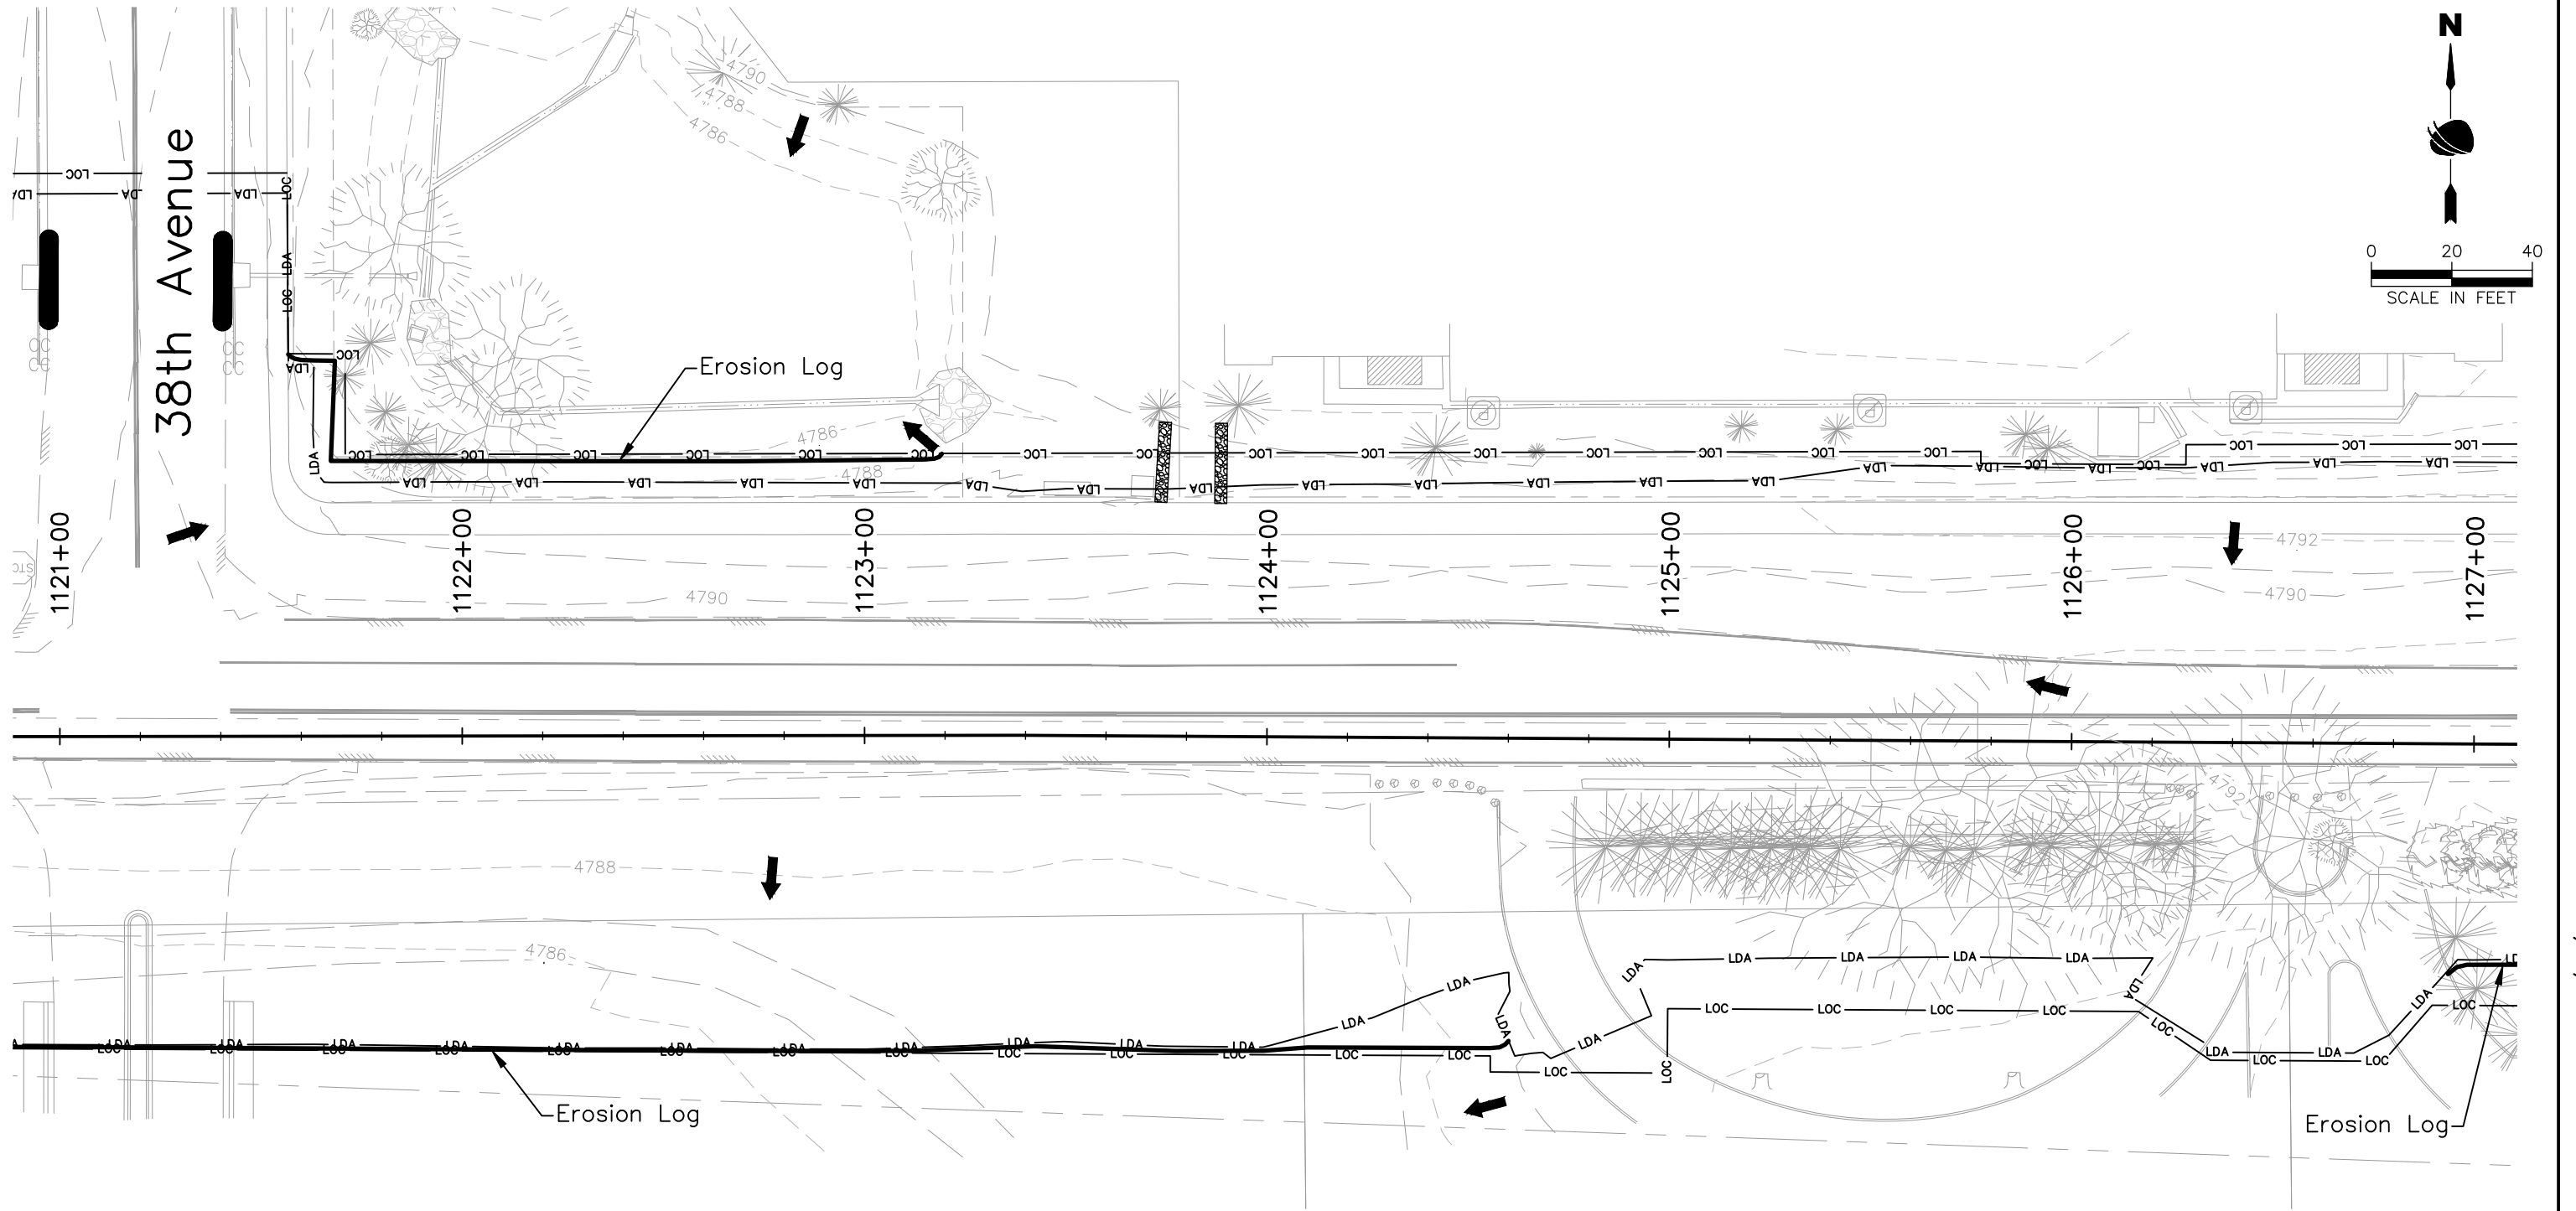

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—LDA—	LIMITS OF DISTURBANCE	—EL—	EROSION LOG (TYPE I)(12 INCH)
—LOC—	LIMITS OF CONSTRUCTION	—SDIP—	STORM DRAIN INLET PROTECTION (TYPE I)(84 INCH)
---	TOE OF FILL	—SDIP—	STORM DRAIN INLET PROTECTION (TYPE II)
---	TOP OF CUT	—AB—	AGGREGATE BAG
→	FLOW ARROW (DIRECTION OF FLOW)	—SF—	SILT FENCE
—PEL—	PIPE EROSION LOG		

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INITIAL SWMP LEGEND:			
SYMBOL	DESCRIPTION (PROPOSED QUANTITY)		
11+00	ROADWAY STATIONING	—PF—	PLASTIC FENCE
—LDA—	LIMITS OF DISTURBANCE	—	EROSION LOG (TYPE I)(12 INCH)
—LOC—	LIMITS OF CONSTRUCTION	—	STORM DRAIN INLET PROTECTION (TYPE I)(84 INCH)
---	TOE OF FILL	▨	STORM DRAIN INLET PROTECTION (TYPE II)
---	TOP OF CUT	▨	AGGREGATE BAG
➔	FLOW ARROW (DIRECTION OF FLOW)	—SF—	SILT FENCE
~	PIPE EROSION LOG		

- Notes:**
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Revised:		Detailer: S. Hemler	Structure Numbers	
Void:		Sheet Subset: SWMP	Subset Sheets: 9 of 18	Drawing Number ENVI-009
				Sheet Number 68
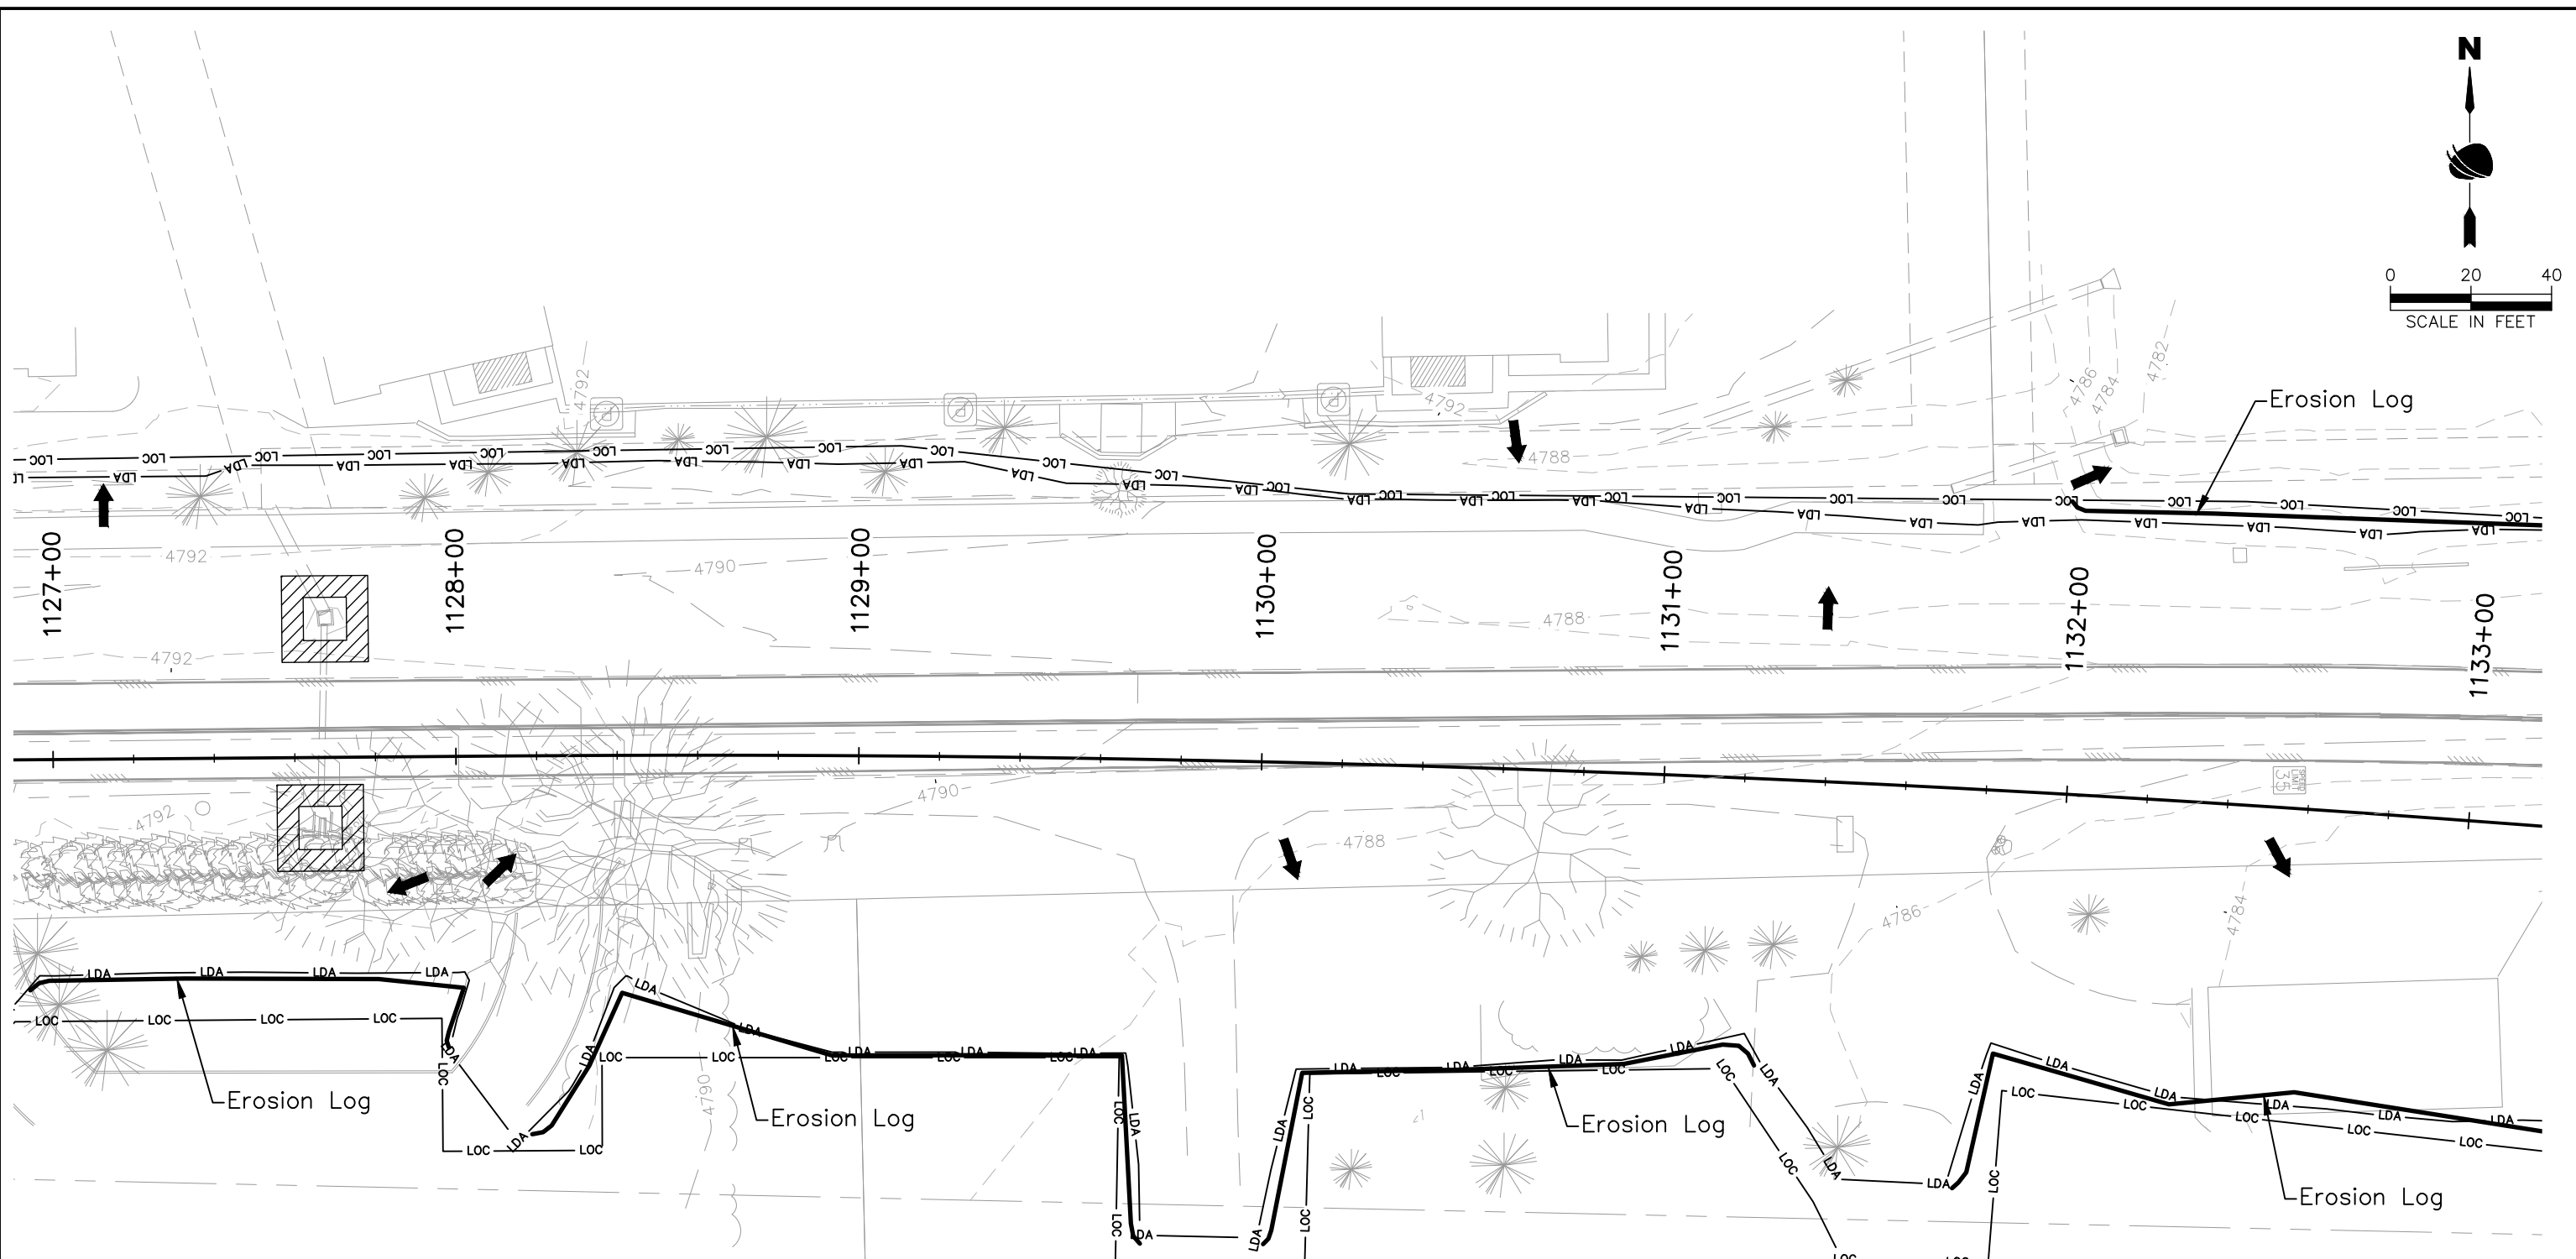
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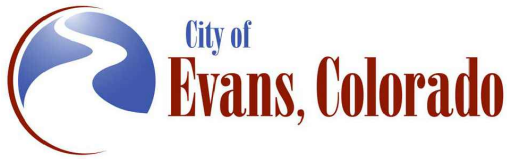
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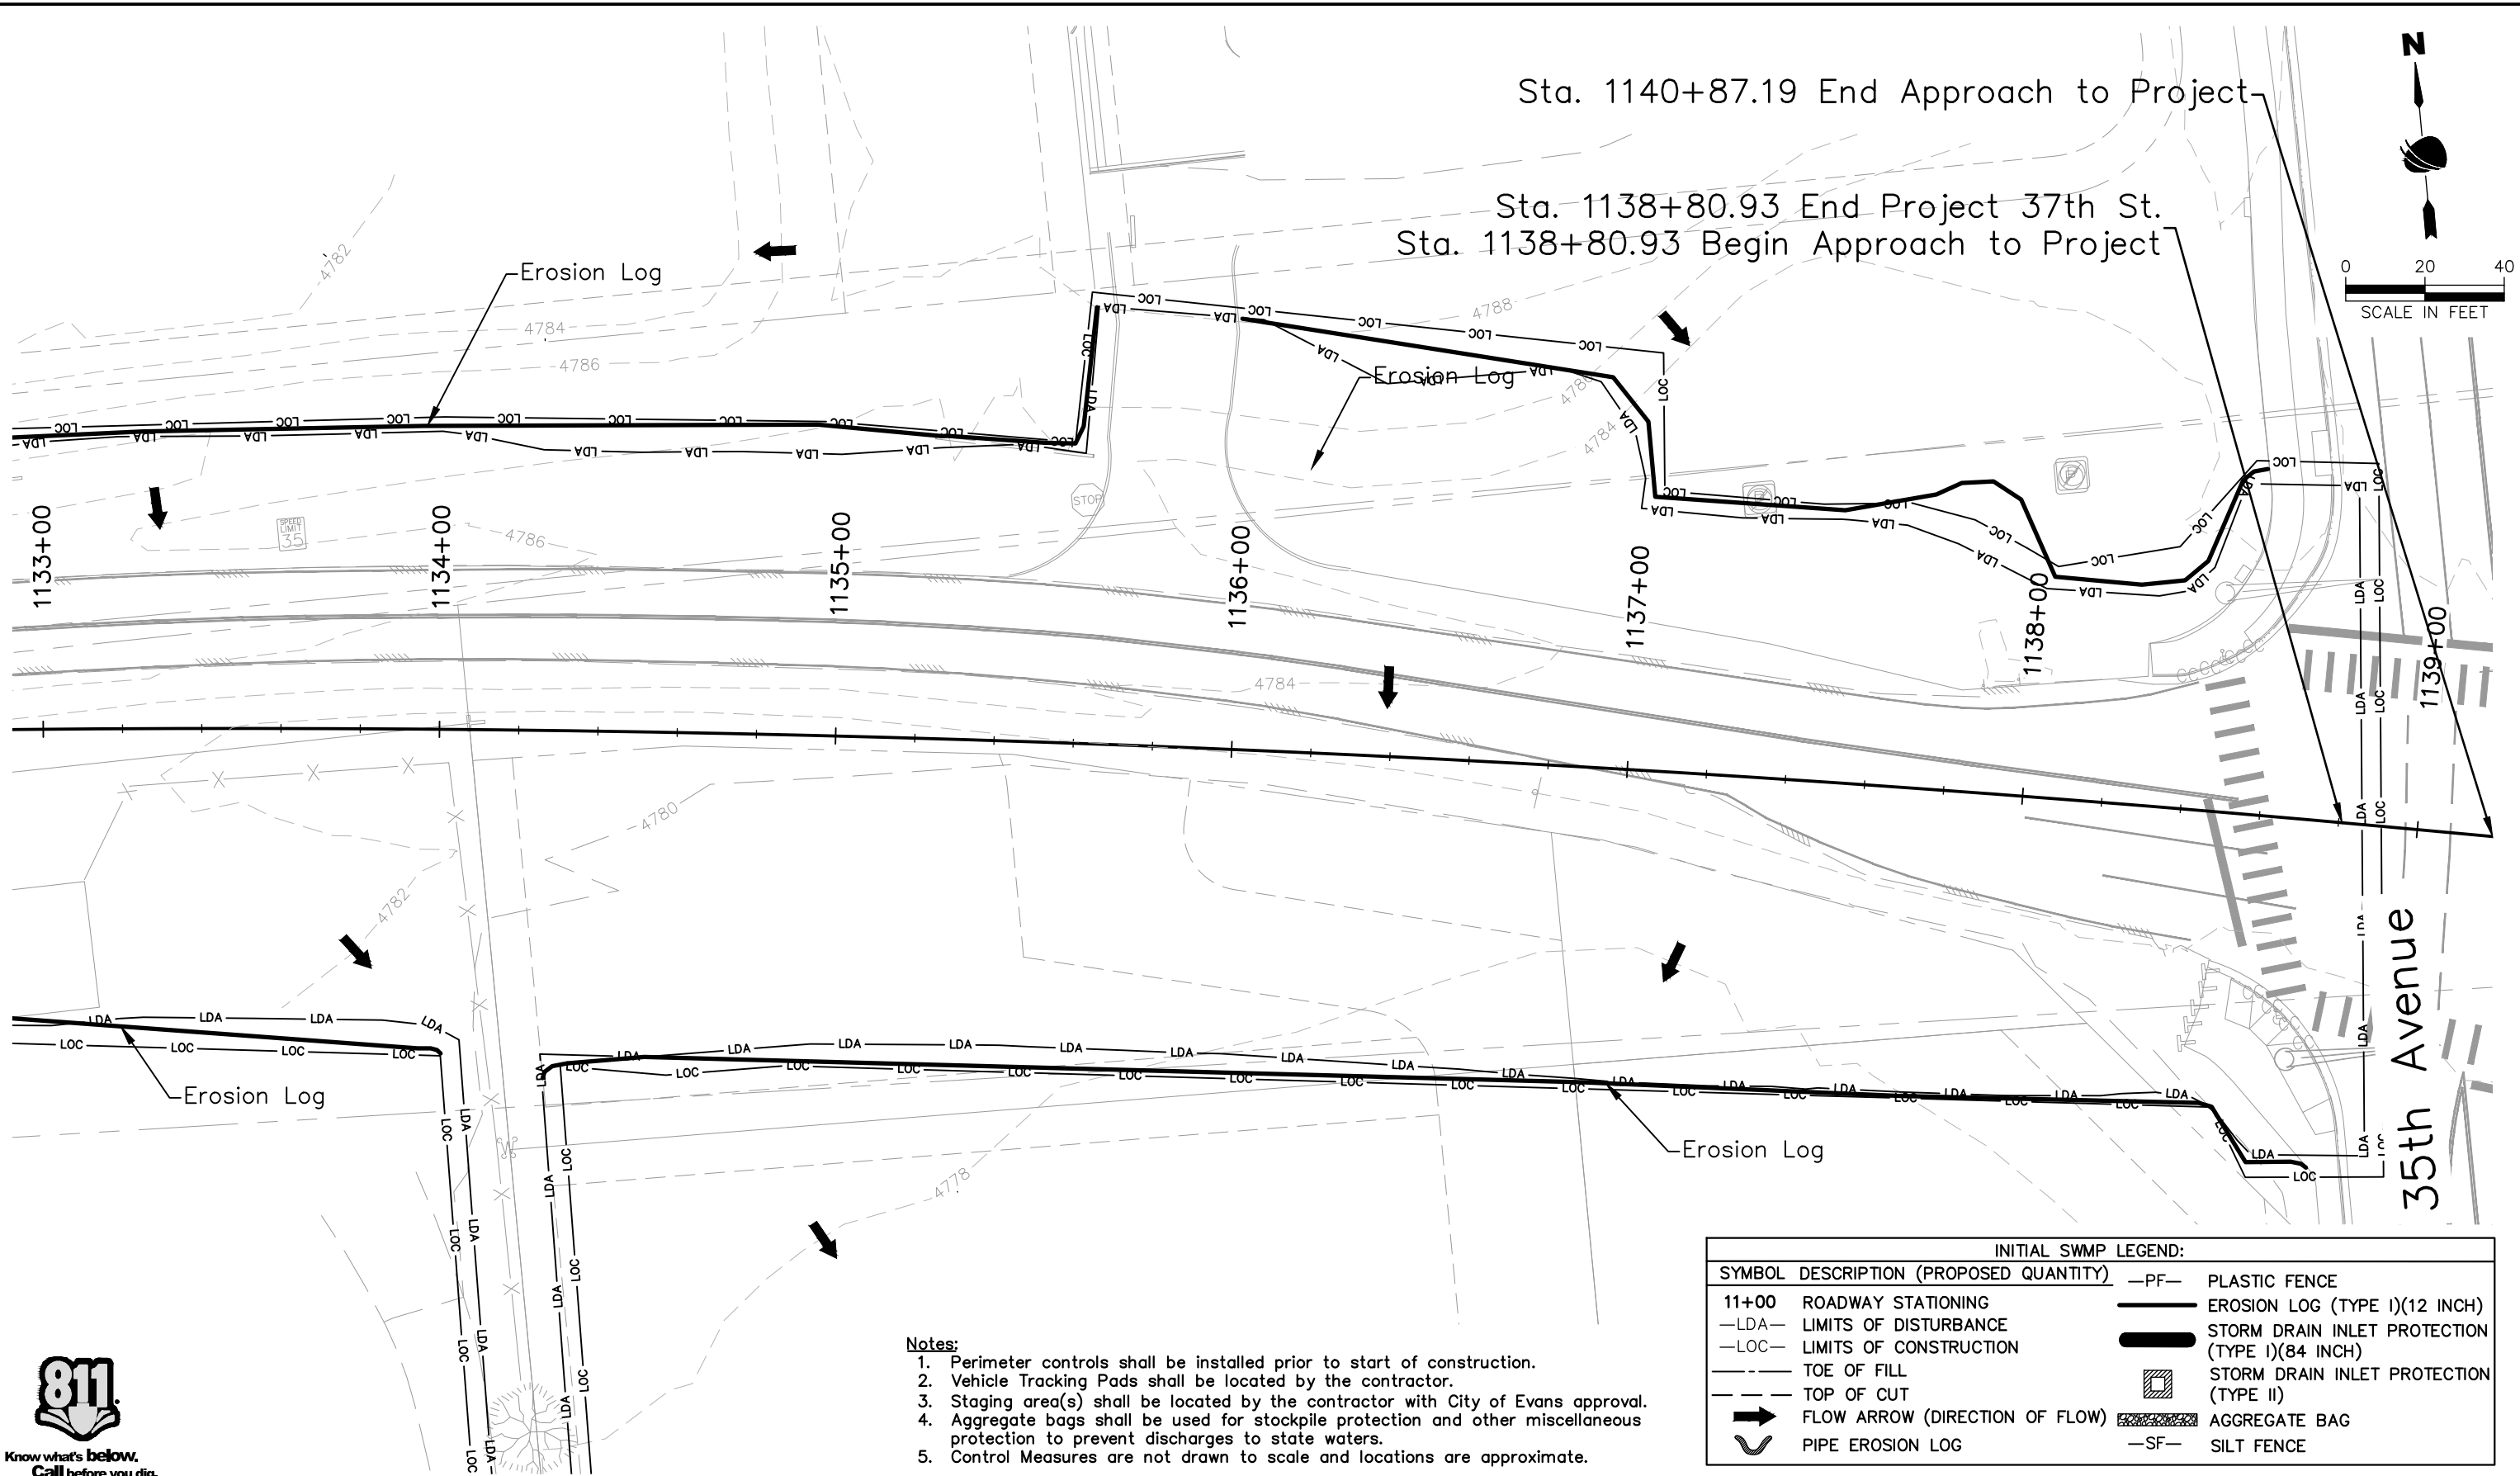
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37TH STREET WIDENING PHASE 2B
STORMWATER MANAGEMENT PLAN
INITIAL SWMP SITE MAP

Designer: J. Kirkling
Detailer: S. Hemler
Sheet Subset: SWMP
Structure Numbers:
Subset Sheets: 10 of 18

Project No.

37TH STREET 2B
Drawing Number ENVI-010
Sheet Number 69



INITIAL SWMP LEGEND:			
SYMBOL	DESCRIPTION (PROPOSED QUANTITY)	—PF—	PLASTIC FENCE
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—LDA—	LIMITS OF DISTURBANCE	—SDIP—	STORM DRAIN INLET PROTECTION (TYPE I)(84 INCH)
—LOC—	LIMITS OF CONSTRUCTION	—SDIP—	STORM DRAIN INLET PROTECTION (TYPE II)
---	TOE OF FILL	—AB—	AGGREGATE BAG
---	TOP OF CUT	—SF—	SILT FENCE
→	FLOW ARROW (DIRECTION OF FLOW)		
U	PIPE EROSION LOG		

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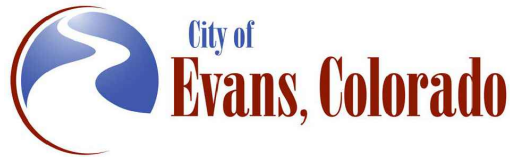
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No Revisions:		Designer: J. Kirkling		37TH STREET 2B
Revised:		Detailer: S. Hemler	Structure Numbers	Drawing Number ENVI-011
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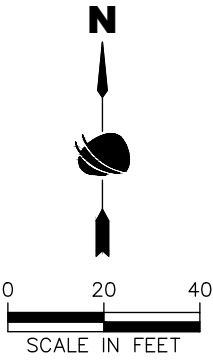
Notes:

1. Perimeter controls shall be installed prior to start of construction.
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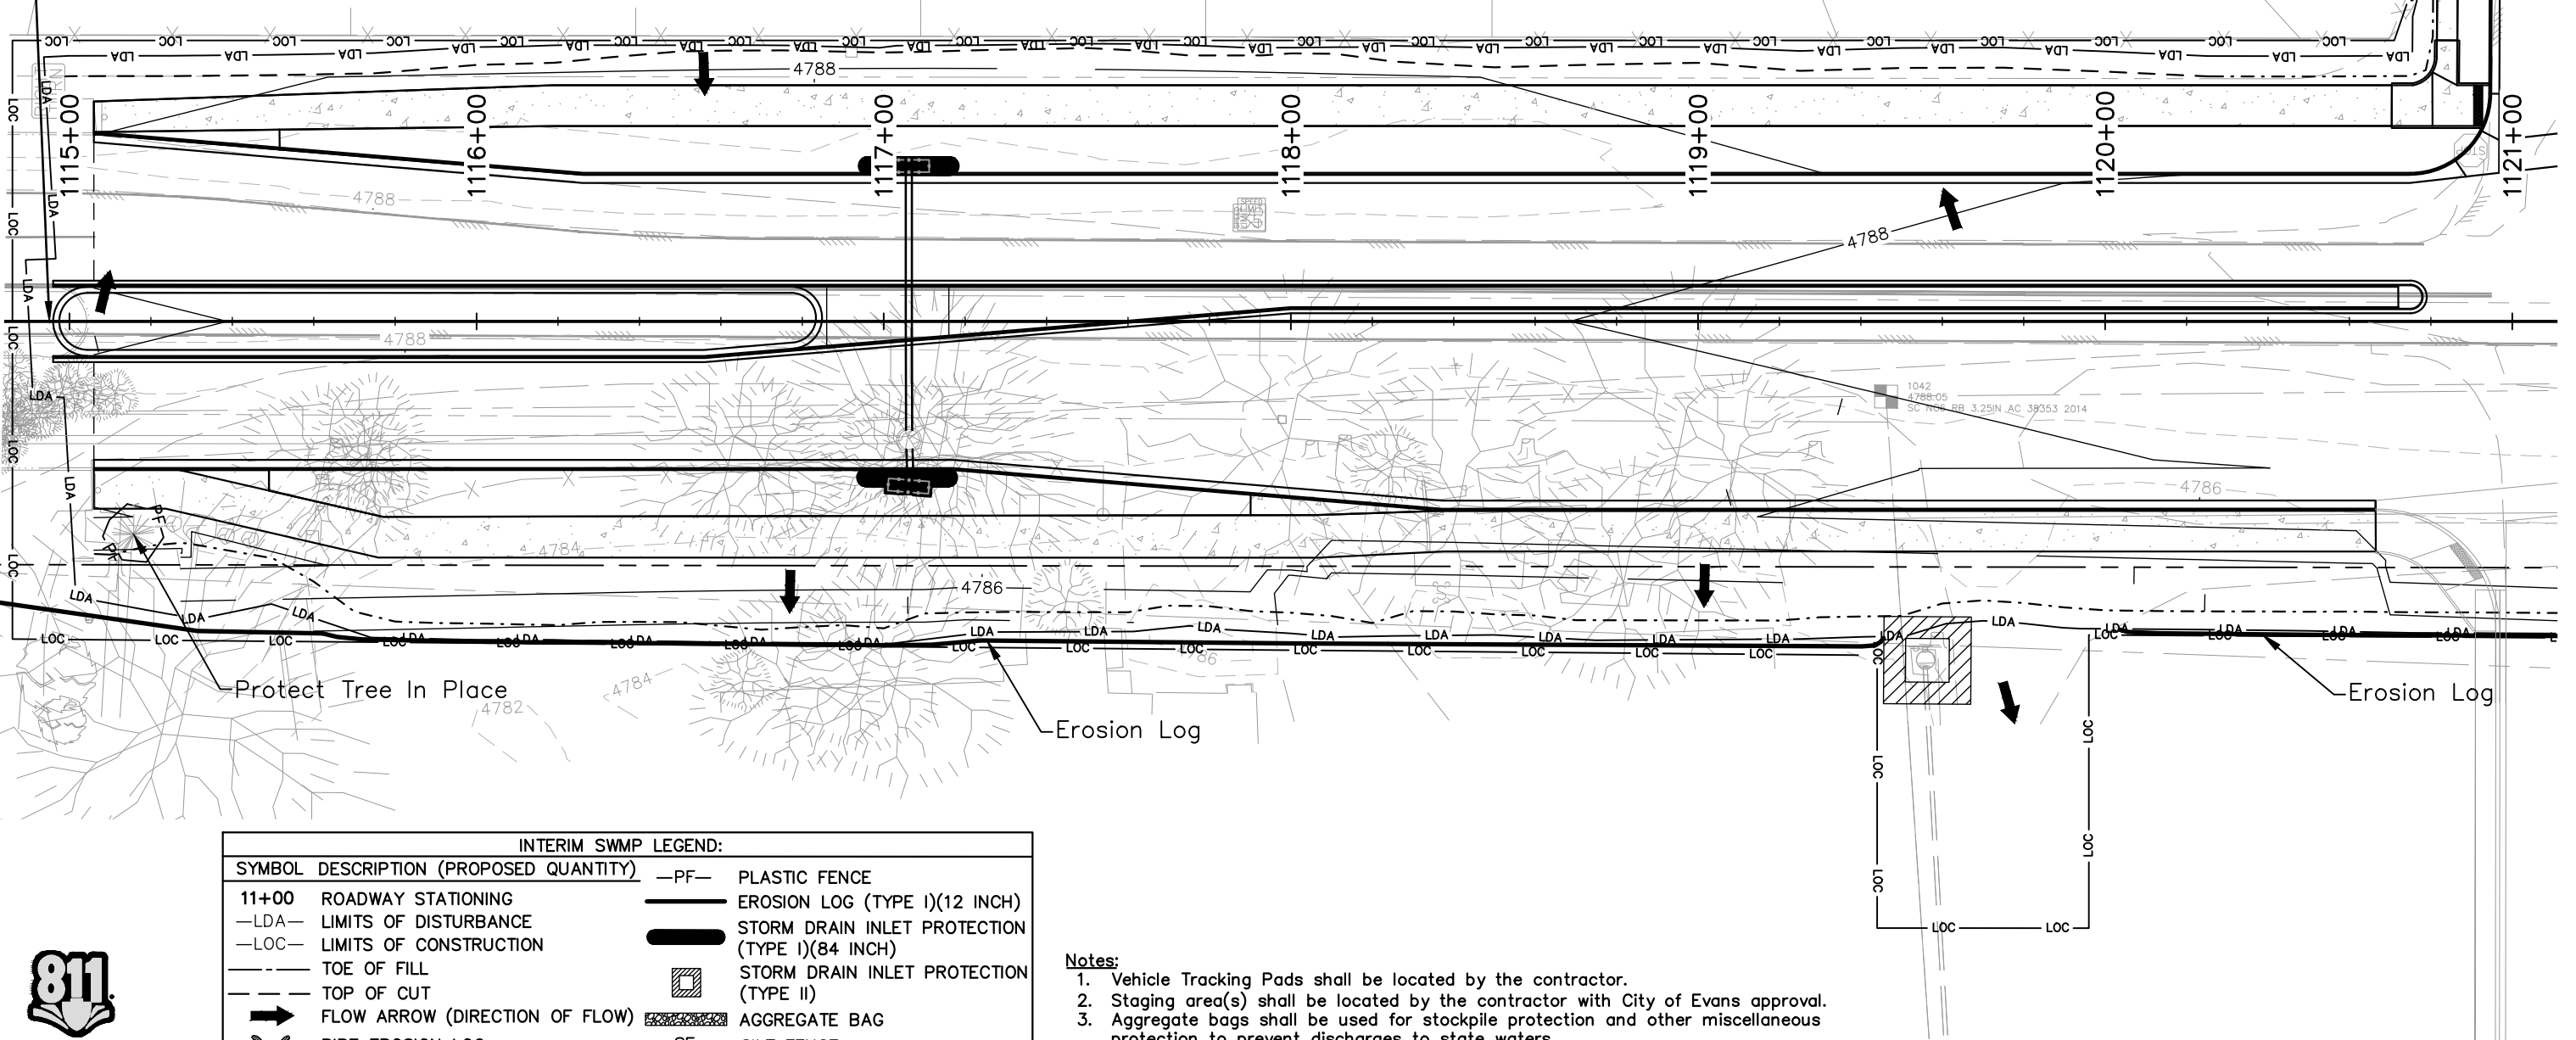
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—LDA—	LIMITS OF DISTURBANCE	—SDI—	STORM DRAIN INLET PROTECTION (TYPE I)(84 INCH)
—LOC—	LIMITS OF CONSTRUCTION	—SDI—	STORM DRAIN INLET PROTECTION (TYPE II)
---	TOE OF FILL	—AB—	AGGREGATE BAG
---	TOP OF CUT	—SF—	SILT FENCE
→	FLOW ARROW (DIRECTION OF FLOW)		
U	PIPE EROSION LOG		

FOR CONSTRUCTION 5/1/2025

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INTERIM SWMP LEGEND:			
SYMBOL	DESCRIPTION (PROPOSED QUANTITY)		
11+00	ROADWAY STATIONING	—PF—	PLASTIC FENCE
—LDA—	LIMITS OF DISTURBANCE	—	EROSION LOG (TYPE I)(12 INCH)
—LOC—	LIMITS OF CONSTRUCTION	—	STORM DRAIN INLET PROTECTION (TYPE I)(84 INCH)
---	TOE OF FILL	▣	STORM DRAIN INLET PROTECTION (TYPE II)
---	TOP OF CUT	▨	AGGREGATE BAG
➔	FLOW ARROW (DIRECTION OF FLOW)	—SF—	SILT FENCE
U	PIPE EROSION LOG		

- Notes:**
1. Vehicle Tracking Pads shall be located by the contractor.
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 3. Aggregate bags shall be used for stockpile protection and other miscellaneous protection to prevent discharges to state waters.
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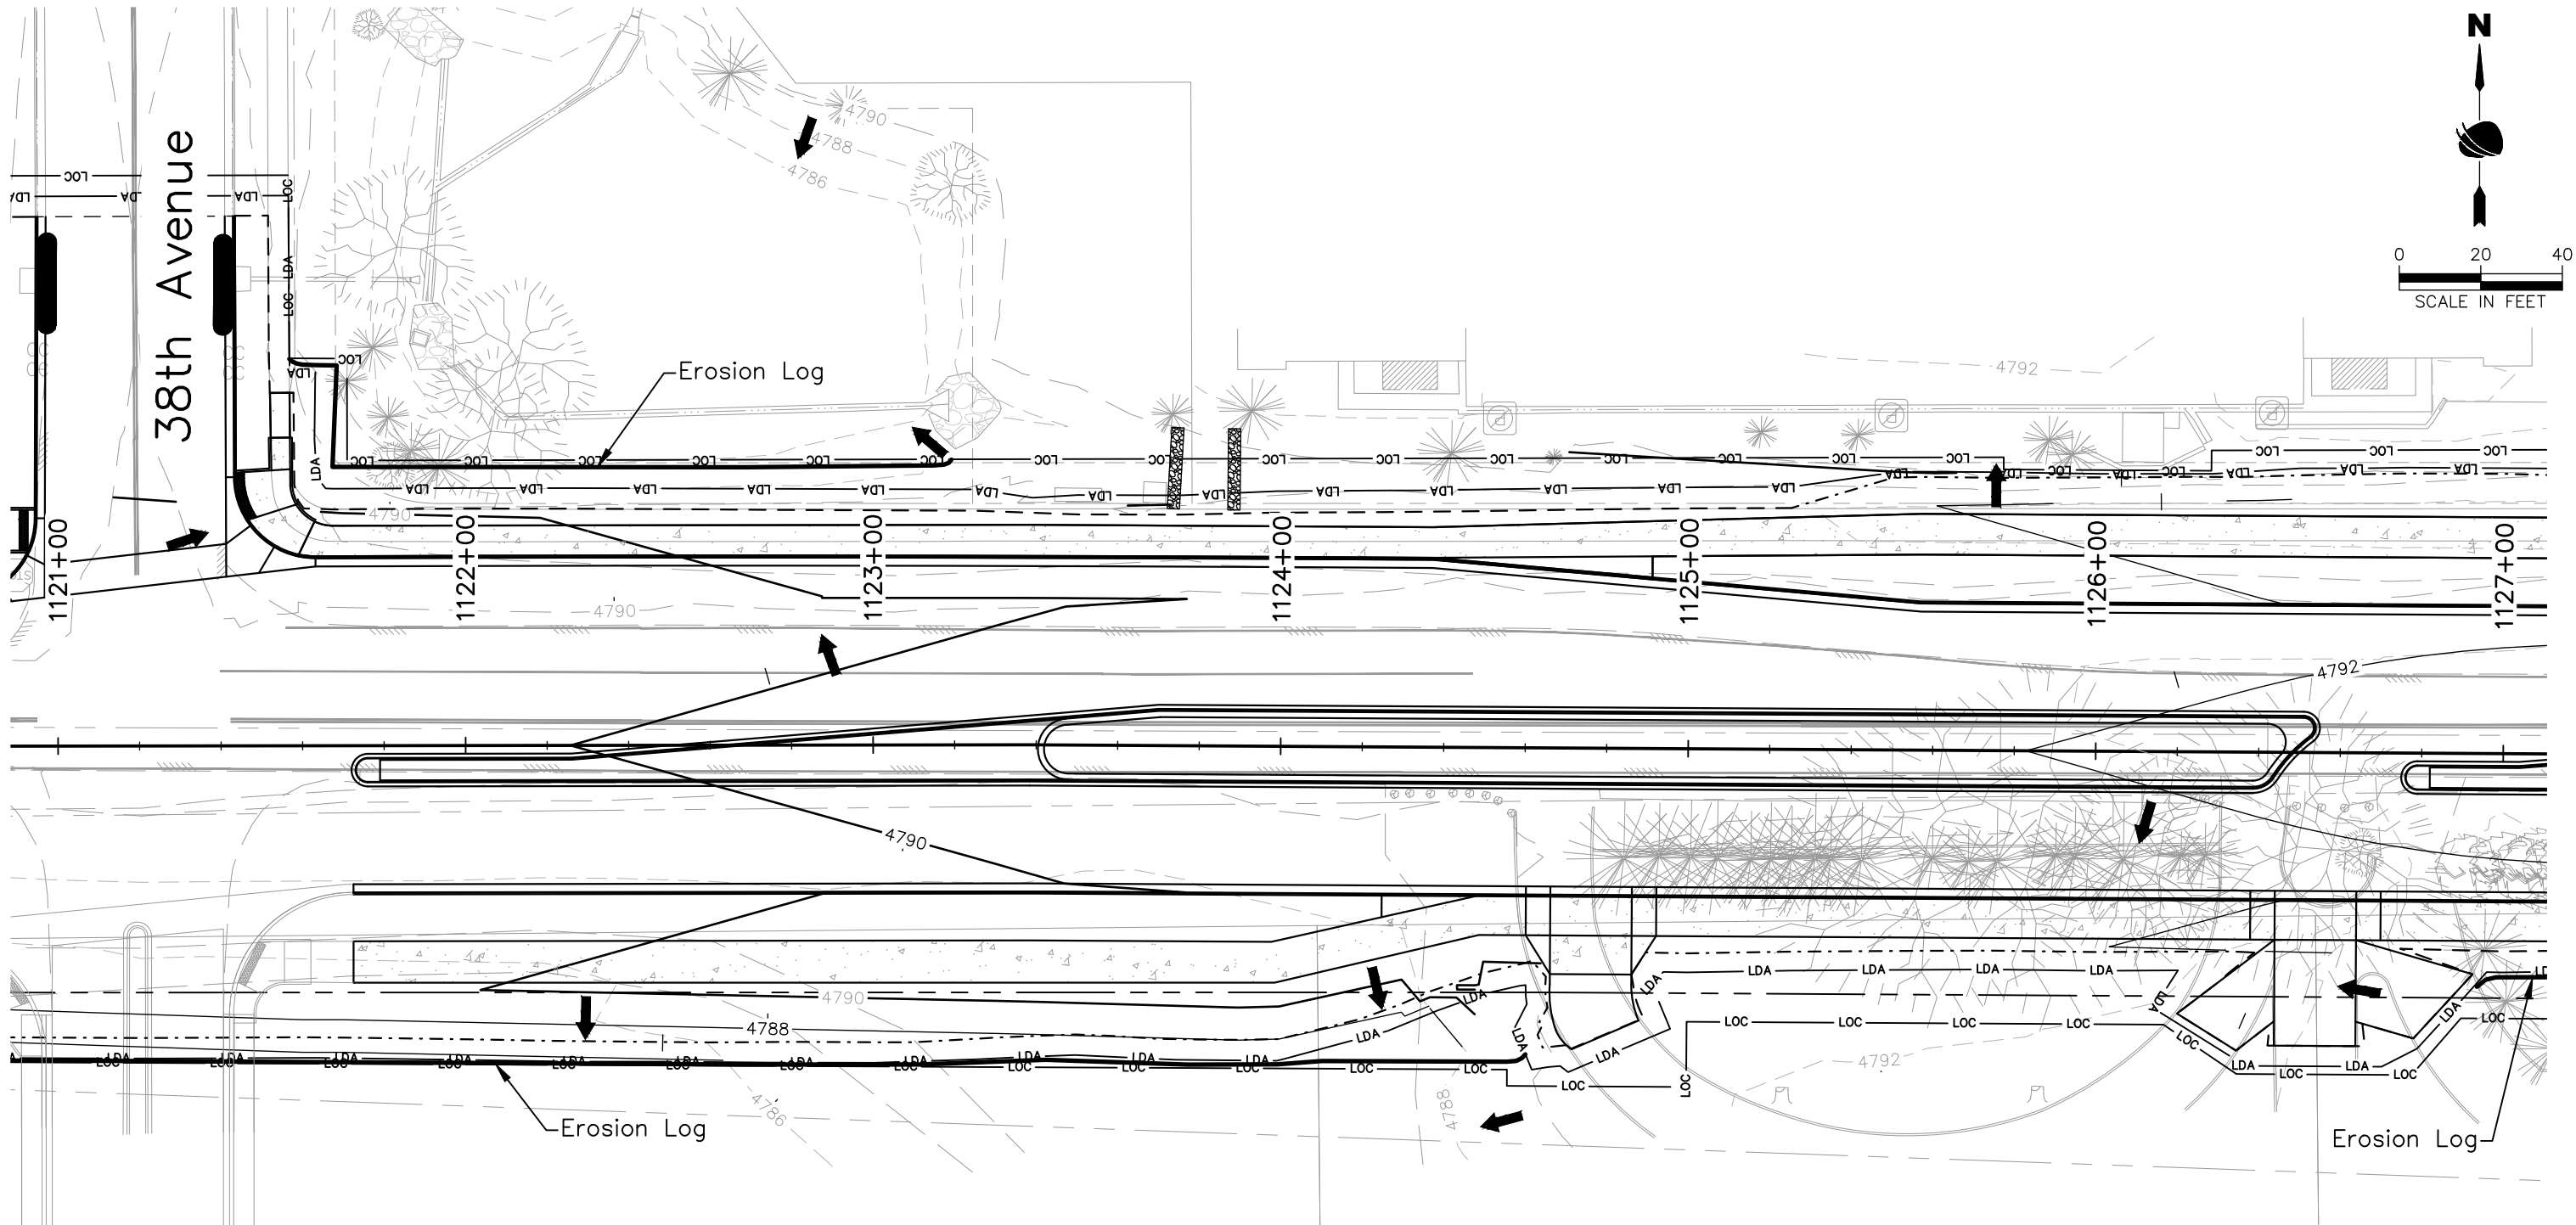


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No Revisions:		Designer: J. Kirkling		37TH STREET 2B
Revised:		Detailer: S. Hemler	Structure Numbers	Drawing Number ENVI-012
Void:		Sheet Subset: SWMP	Subset Sheets: 11 of 18	Sheet Number 71




- Notes:**
- 1. Vehicle Tracking Pads shall be located by the contractor.
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INTERIM SWMP LEGEND:			
SYMBOL	DESCRIPTION (PROPOSED QUANTITY)	SYMBOL	DESCRIPTION (PROPOSED QUANTITY)
11+00	ROADWAY STATIONING	—PF—	PLASTIC FENCE
—LDA—	LIMITS OF DISTURBANCE	—E—	EROSION LOG (TYPE I)(12 INCH)
—LOC—	LIMITS OF CONSTRUCTION	—S—	STORM DRAIN INLET PROTECTION (TYPE I)(84 INCH)
—TOF—	TOE OF FILL	—S—	STORM DRAIN INLET PROTECTION (TYPE II)
—TOC—	TOP OF CUT	—SF—	SILT FENCE
→	FLOW ARROW (DIRECTION OF FLOW)	—AG—	AGGREGATE BAG
—PE—	PIPE EROSION LOG		



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FOR CONSTRUCTION 5/1/2025

Plot Date: 5/2/2025 6:50 AM Plotted By: Sarah Hemler
C:\Q-PROJECTS\WASTE PROJECTS\33001\EVANS 37TH ST AND 47TH AVE PLAN\320 COMPUTER DESIGN FILES\DWG P2B-017 INTERIM SWMP PLAN.DWG

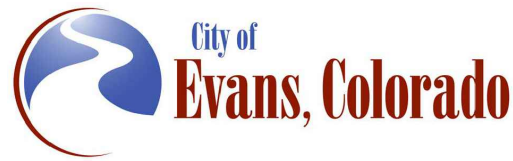

Know what's below.
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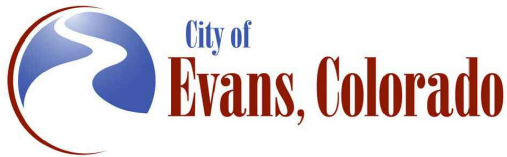
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File Name: ENVI P2B-017 INTERIM SWMP PLAN.DWG	
Horiz. Scale: As Noted	Vert. Scale: N/A
	12076 Grant Street
	Thornton, CO 80241
	Ph: (303) 962-9300
	Fax: (303) 962-9350

Sheet Revisions

Date	Comments	Initials

Notes:

1. Vehicle Tracking Pads shall be located by the contractor.
2. Staging area(s) shall be located by the contractor with City of Evans approval.
3. Aggregate bags shall be used for stockpile protection and other miscellaneous protection to prevent discharges to state waters.
4. Control Measures are not drawn to scale and locations are approximate.



As Constructed



No Revisions:
Revised:
Void:

37TH STREET WIDENING PHASE 2B
STORMWATER MANAGEMENT PLAN
INTERIM SWMP SITE MAP

Designer: J. Kirkling
Detailer: S. Hemler
Sheet Subset: SWMP
Structure Numbers:
Subset Sheets: 13 of 18

Project No.

37TH STREET 2B
Drawing Number ENVI-014
Sheet Number 73

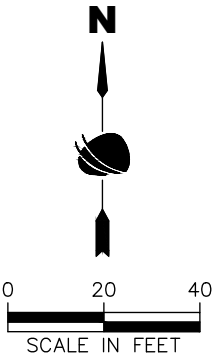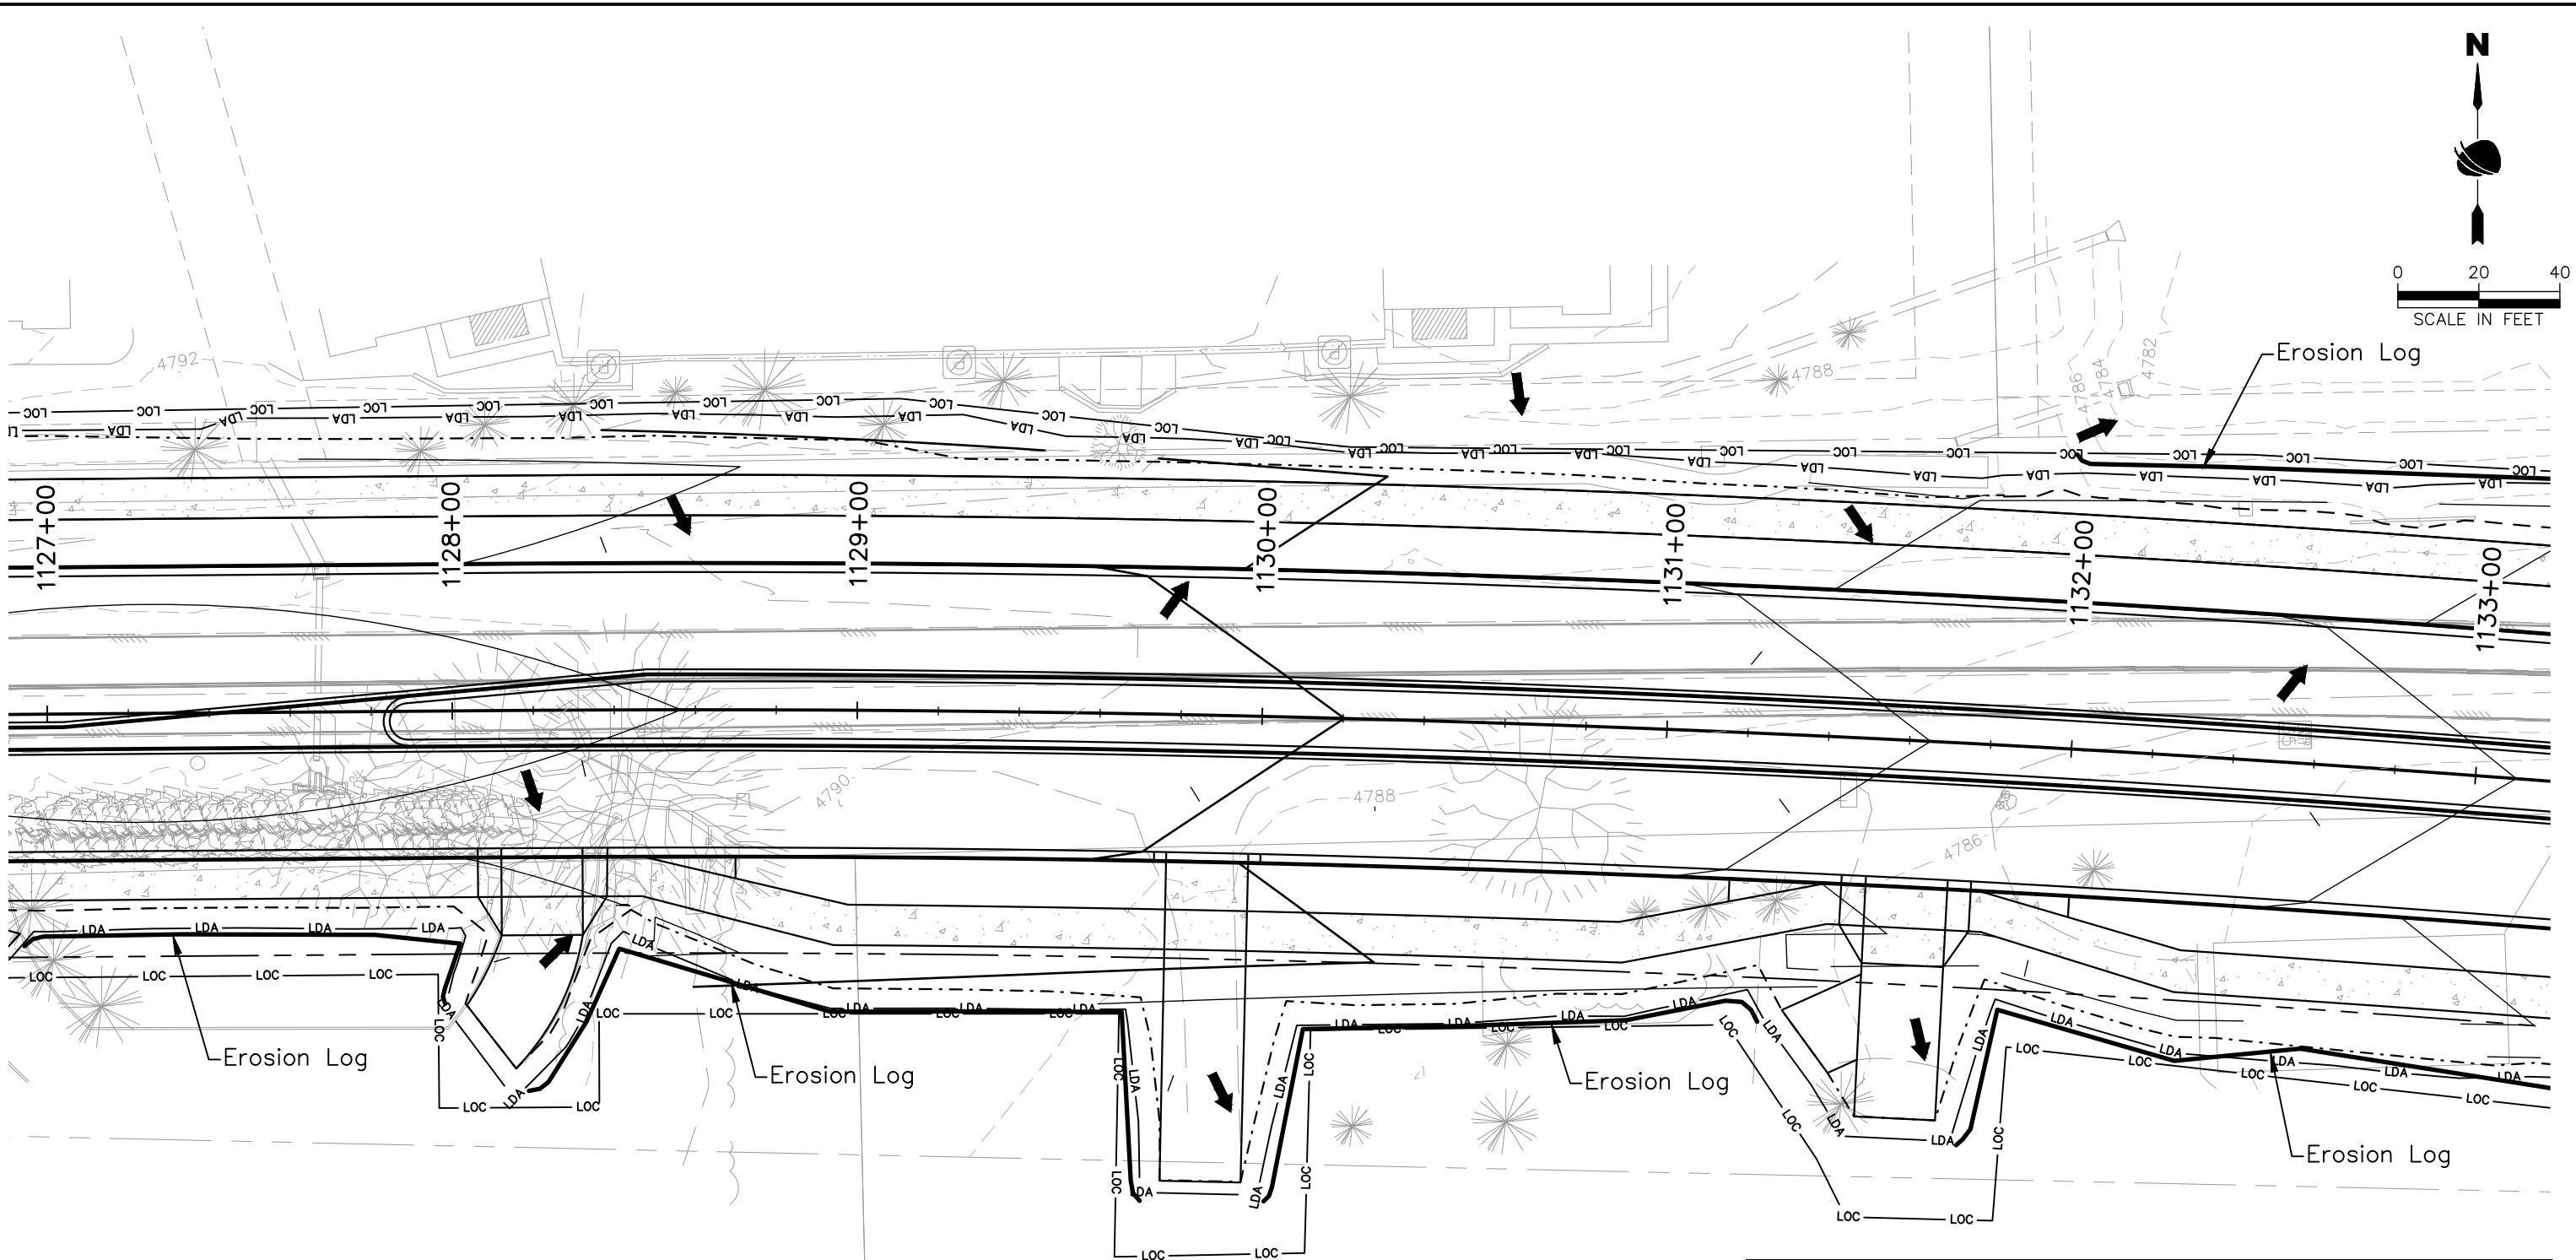

INTERIM SWMP LEGEND:	
SYMBOL	DESCRIPTION (PROPOSED QUANTITY)
11+00	ROADWAY STATIONING
—LDA—	LIMITS OF DISTURBANCE
—LOC—	LIMITS OF CONSTRUCTION
---	TOE OF FILL
- - -	TOP OF CUT
➔	FLOW ARROW (DIRECTION OF FLOW)
⤿	PIPE EROSION LOG
—PF—	PLASTIC FENCE
—	EROSION LOG (TYPE I)(12 INCH)
—	STORM DRAIN INLET PROTECTION (TYPE I)(84 INCH)
⊠	STORM DRAIN INLET PROTECTION (TYPE II)
▨	AGGREGATE BAG
—SF—	SILT FENCE

FOR CONSTRUCTION 5/1/2025


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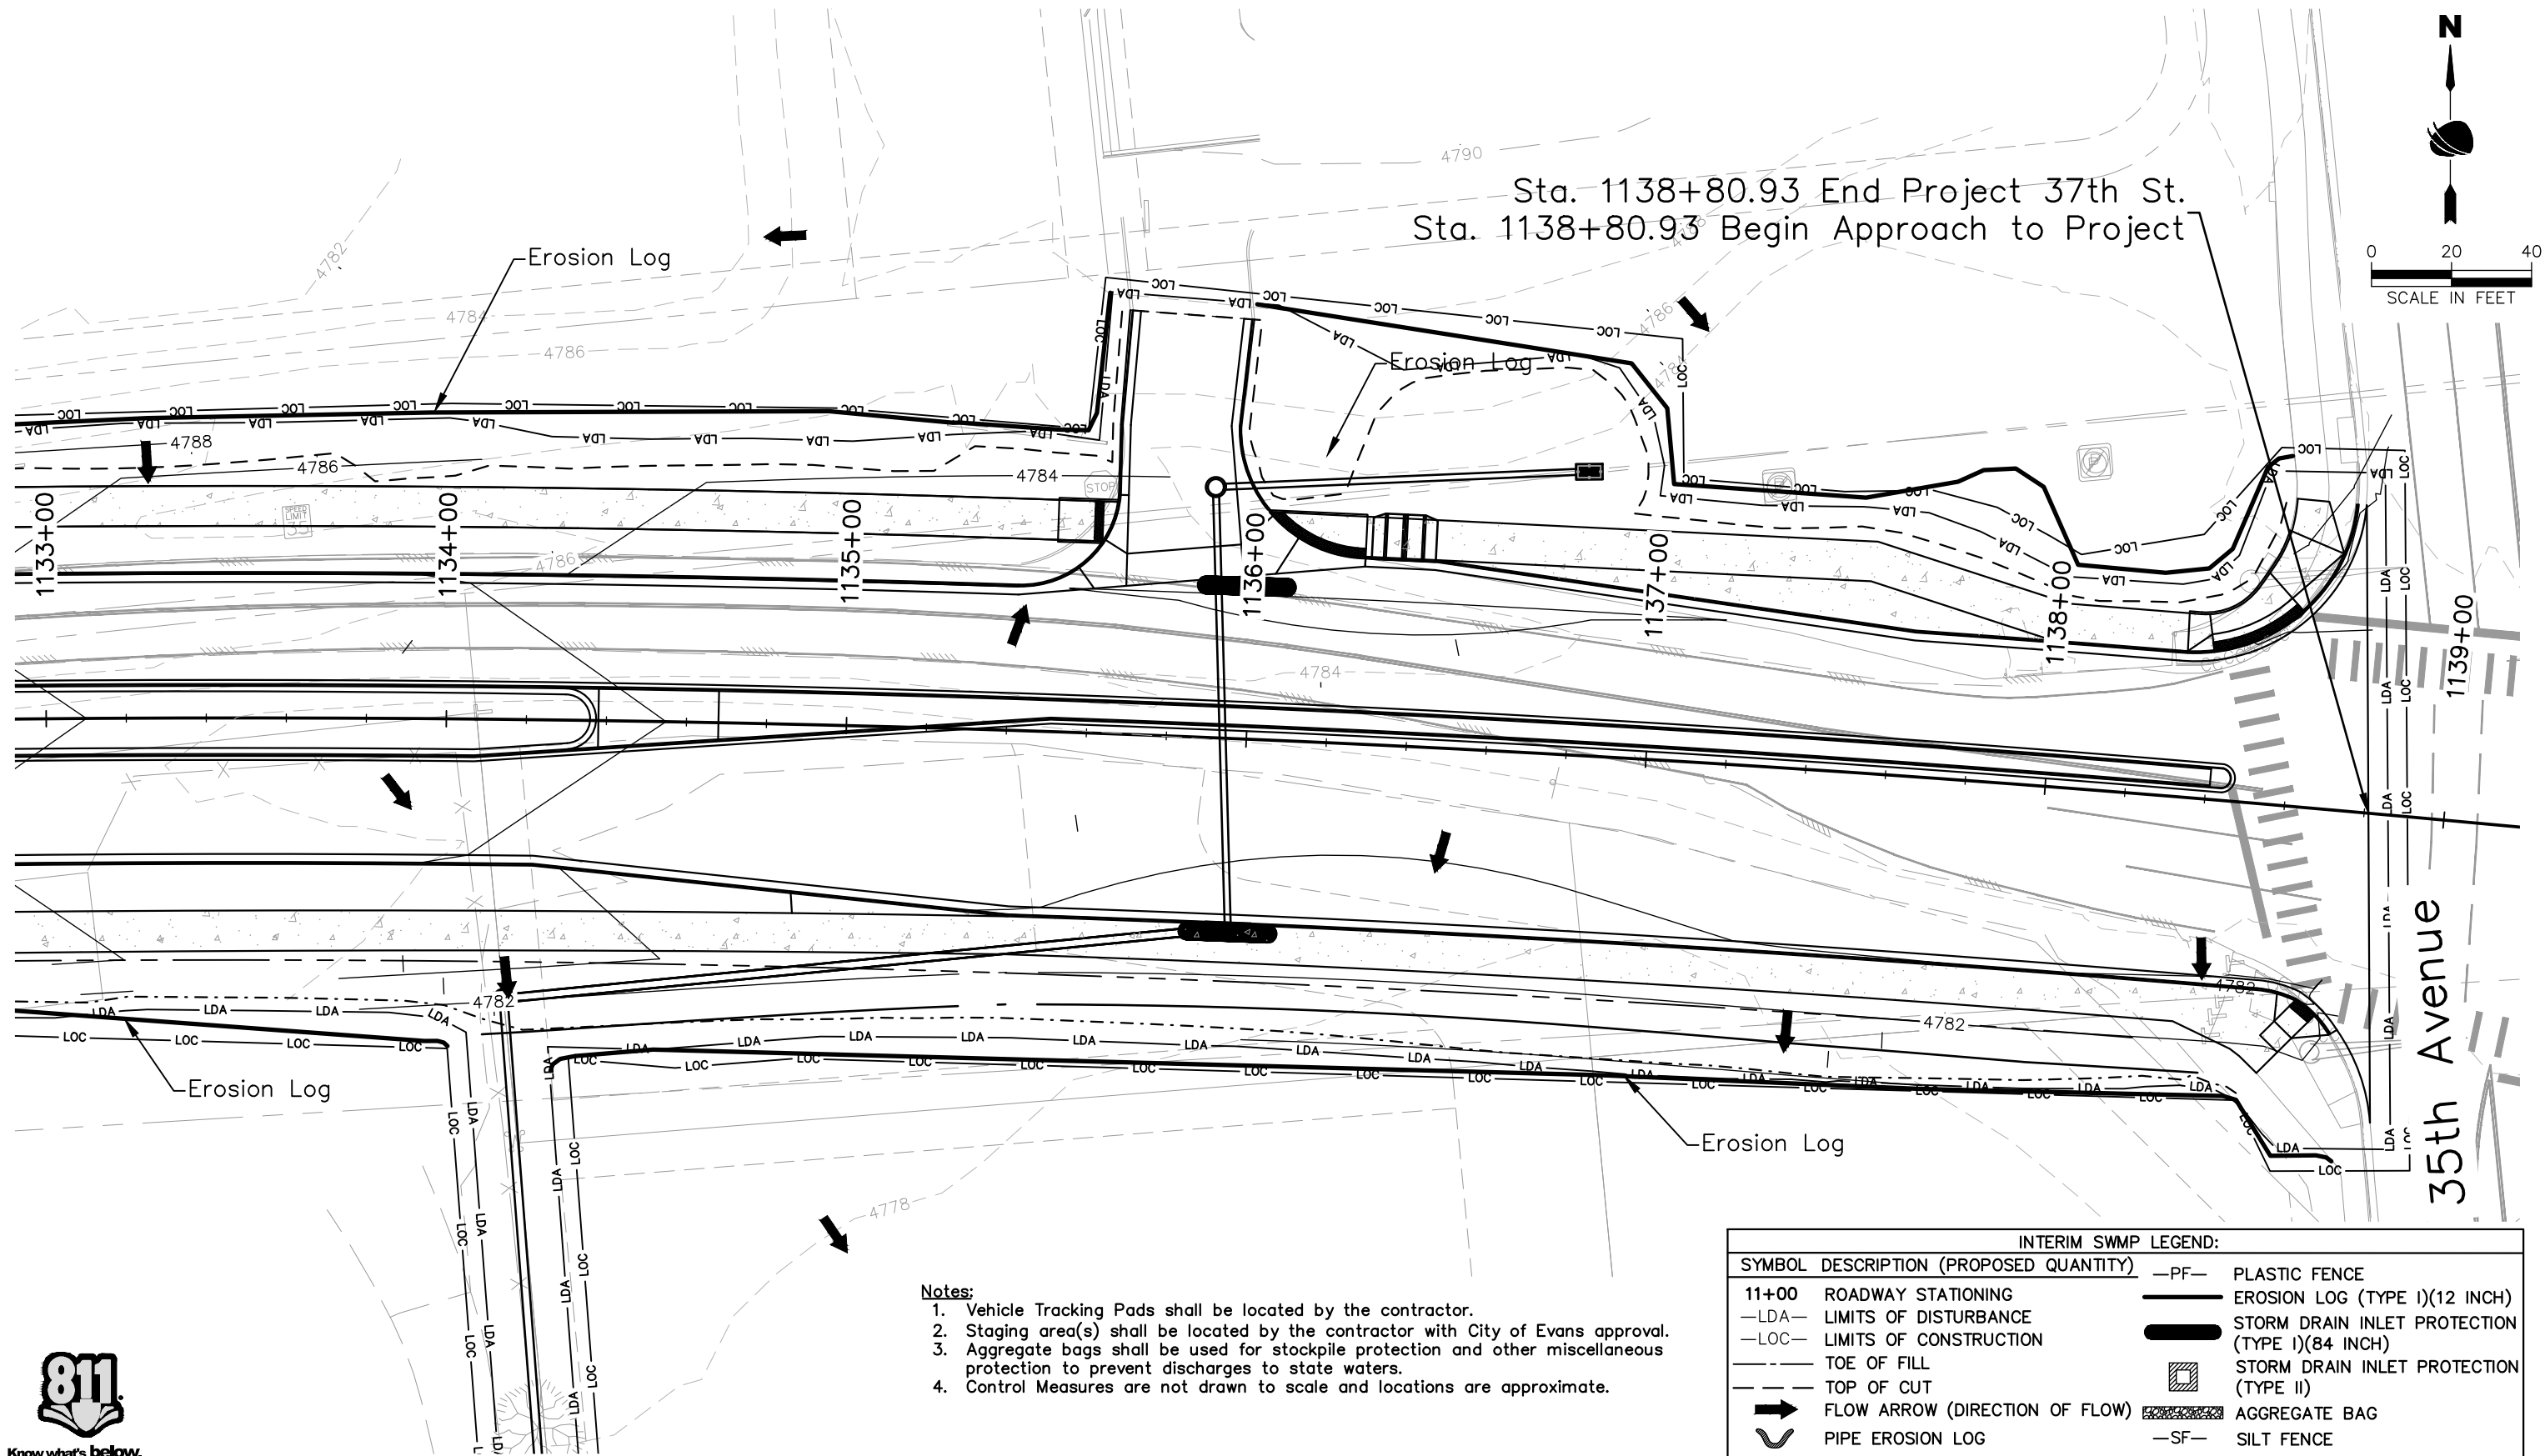
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Sheet Revisions		
Date	Comments	Initials



As Constructed		37TH STREET WIDENING PHASE 2B STORMWATER MANAGEMENT PLAN INTERIM SWMP SITE MAP		Project No.
No Revisions:		Designer: J. Kirkling		37TH STREET 2B
Revised:		Detailer: S. Hemler	Structure Numbers	Drawing Number ENVI-015
Void:		Sheet Subset: SWMP	Subset Sheets: 14 of 18	Sheet Number 74



FOR CONSTRUCTION 5/1/2025

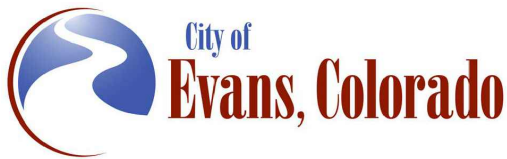
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Know what's below.
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Print Date: 5/2/2025	
File Name: ENVI P2B-017 INTERIM SWMP PLAN.DWG	
Horiz. Scale: As Noted	Vert. Scale: N/A
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	Thornton, CO 80241
	Ph: (303) 962-9300
	Fax: (303) 962-9350

Sheet Revisions		
Date	Comments	Initials




As Constructed		37TH STREET WIDENING PHASE 2B STORMWATER MANAGEMENT PLAN INTERIM SWMP SITE MAP		Project No.
No Revisions:		Designer: J. Kirkling		37TH STREET 2B
Revised:		Detailer: S. Hemler	Structure Numbers	
Void:		Sheet Subset: SWMP	Subset Sheets: 14 of 18	Drawing Number ENVI-016
				Sheet Number 75

Notes:

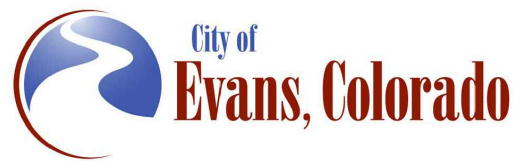
- Vehicle Tracking Pads shall be located by the contractor.
- Staging area(s) shall be located by the contractor with City of Evans approval.
- Aggregate bags shall be used for stockpile protection and other miscellaneous protection to prevent discharges to state waters.
- Control Measures are not drawn to scale and locations are approximate.

INTERIM SWMP LEGEND:			
SYMBOL	DESCRIPTION (PROPOSED QUANTITY)	—PF—	PLASTIC FENCE
11+00	ROADWAY STATIONING		EROSION LOG (TYPE I)(12 INCH)
—LDA—	LIMITS OF DISTURBANCE		STORM DRAIN INLET PROTECTION (TYPE I)(84 INCH)
—LOC—	LIMITS OF CONSTRUCTION		STORM DRAIN INLET PROTECTION (TYPE II)
---	TOE OF FILL		AGGREGATE BAG
- - -	TOP OF CUT		—SF— SILT FENCE
	FLOW ARROW (DIRECTION OF FLOW)		
	PIPE EROSION LOG		

FOR CONSTRUCTION 5/1/2025

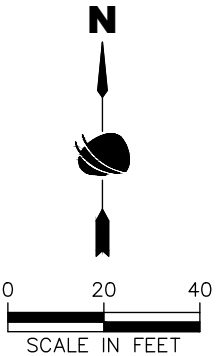

Sta. 1114+96.00 Begin Project 37th St.

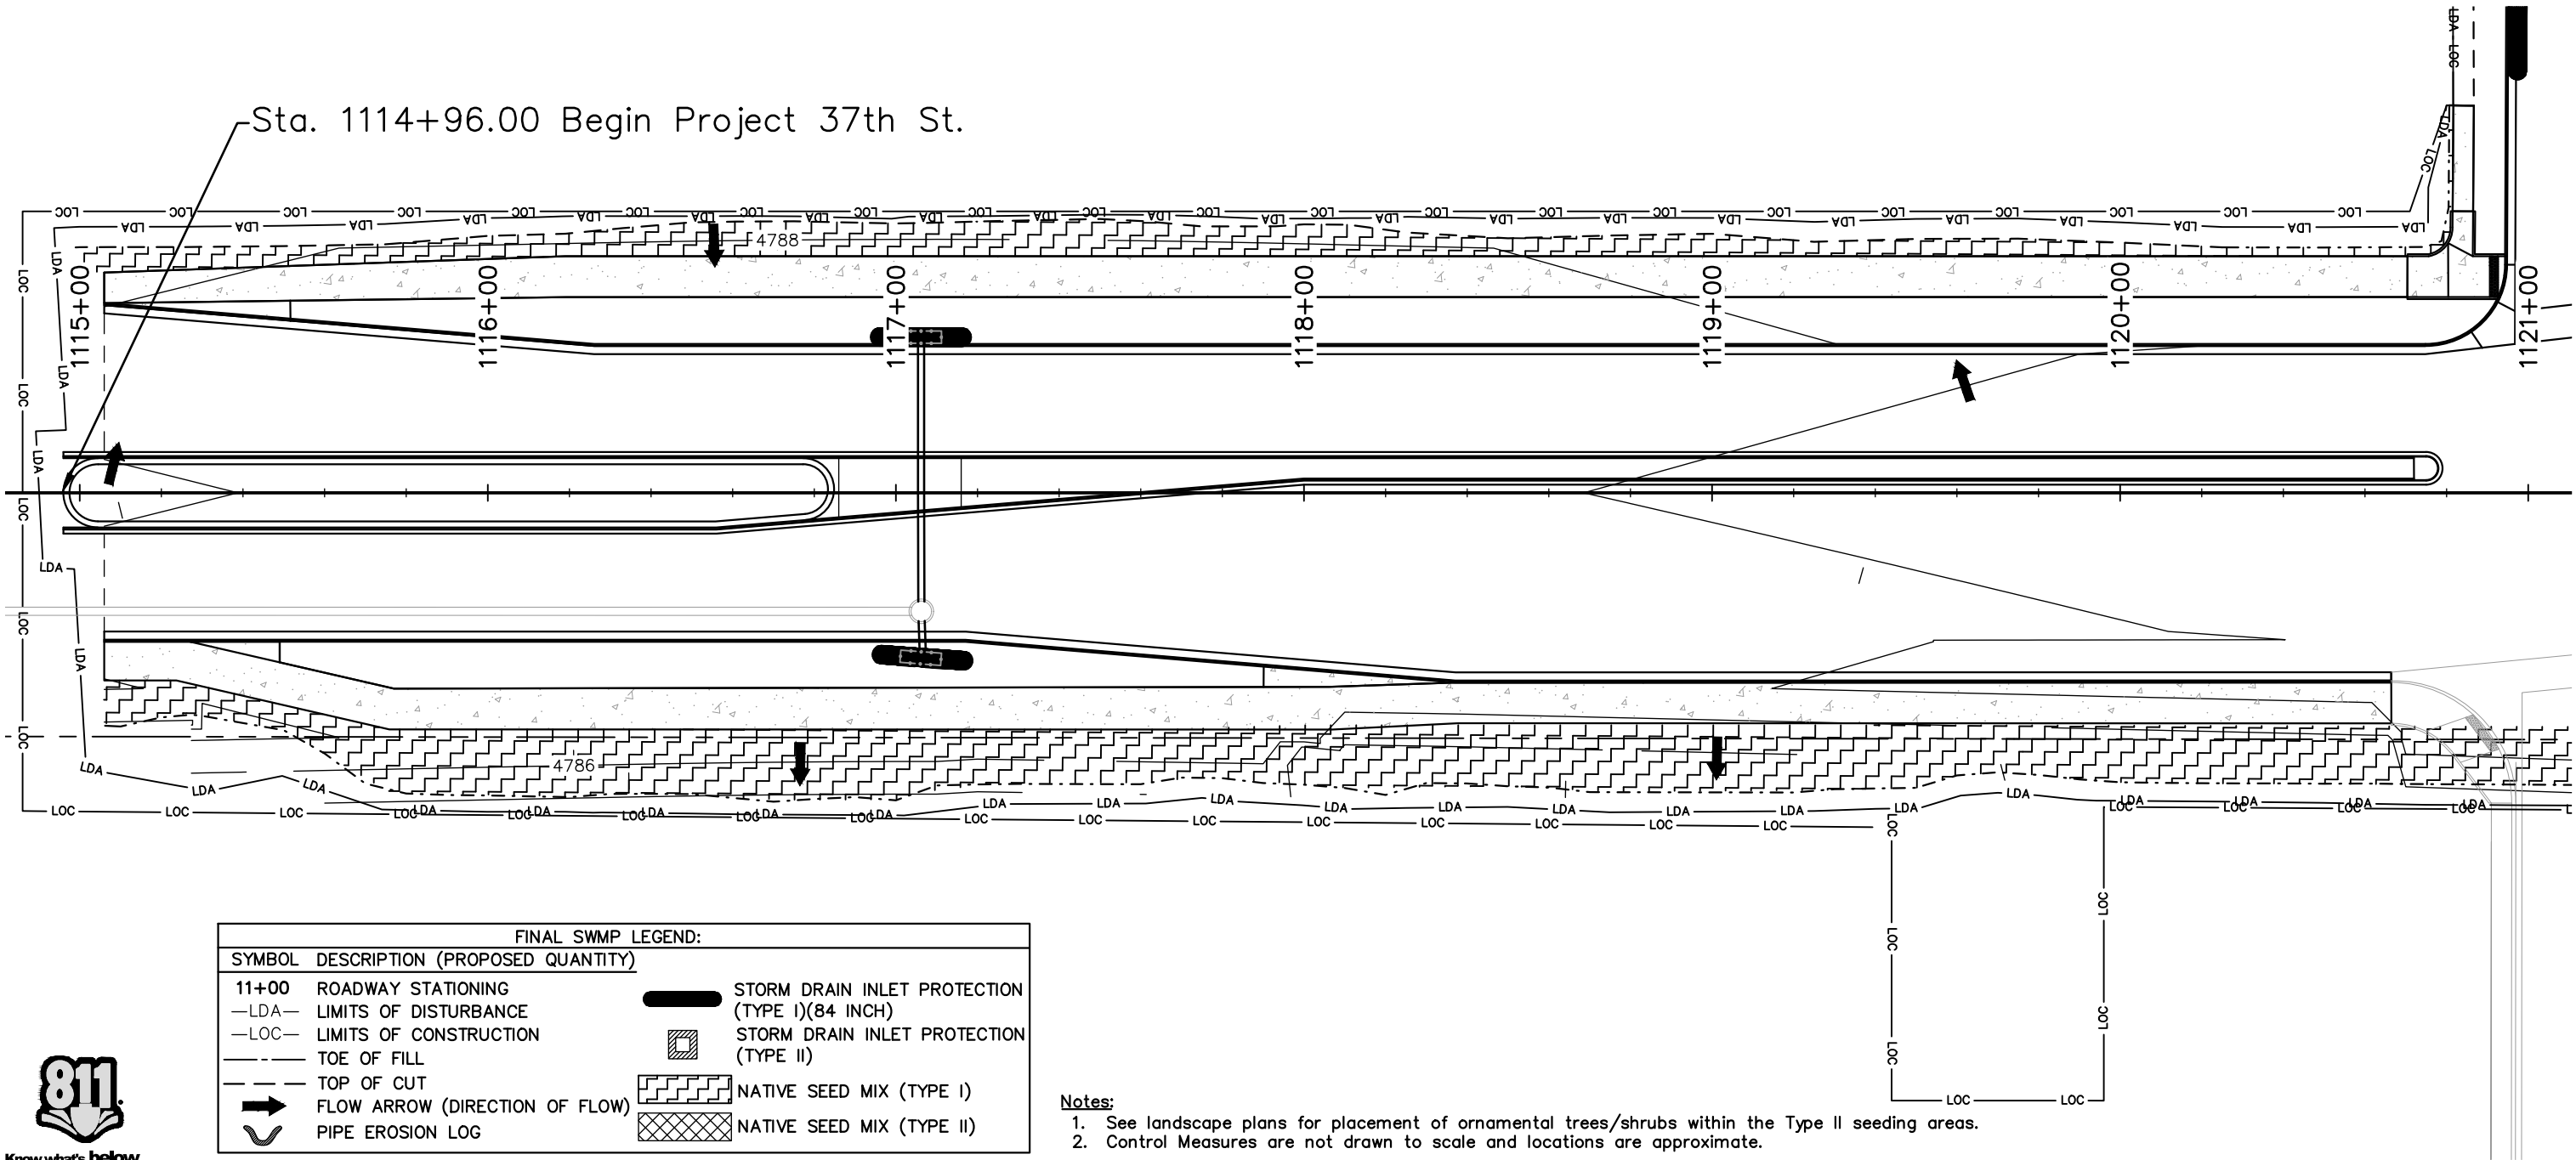

FINAL SWMP LEGEND:		
SYMBOL	DESCRIPTION (PROPOSED QUANTITY)	
11+00	ROADWAY STATIONING	
—LDA—	LIMITS OF DISTURBANCE	
—LOC—	LIMITS OF CONSTRUCTION	
---	TOE OF FILL	
- - -	TOP OF CUT	
➔	FLOW ARROW (DIRECTION OF FLOW)	
⤵	PIPE EROSION LOG	
	STORM DRAIN INLET PROTECTION (TYPE I)(84 INCH)	
	STORM DRAIN INLET PROTECTION (TYPE II)	
	NATIVE SEED MIX (TYPE I)	
	NATIVE SEED MIX (TYPE II)	

- Notes:
1. See landscape plans for placement of ornamental trees/shrubs within the Type II seeding areas.
 2. Control Measures are not drawn to scale and locations are approximate.



Print Date: 5/2/2025


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Horiz. Scale: As Noted Vert. Scale: N/A





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Thornton, CO 80241
Ph: (303) 962-9300
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Sheet Revisions		
Date	Comments	Initials



As Constructed	37TH STREET WIDENING PHASE 2B STORMWATER MANAGEMENT PLAN FINAL SWMP SITE MAP		Project No.
	No Revisions:		37TH STREET 2B
Revised:	Designer: J. Kirkling	Structure Numbers	Drawing Number ENVI-017
Void:	Detailer: S. Hemler		
	Sheet Subset: SWMP	Subset Sheets: 15 of 18	Sheet Number 76

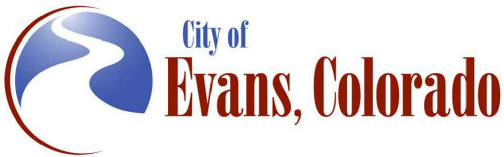38th Avenue

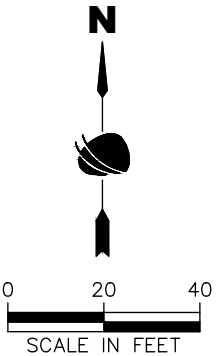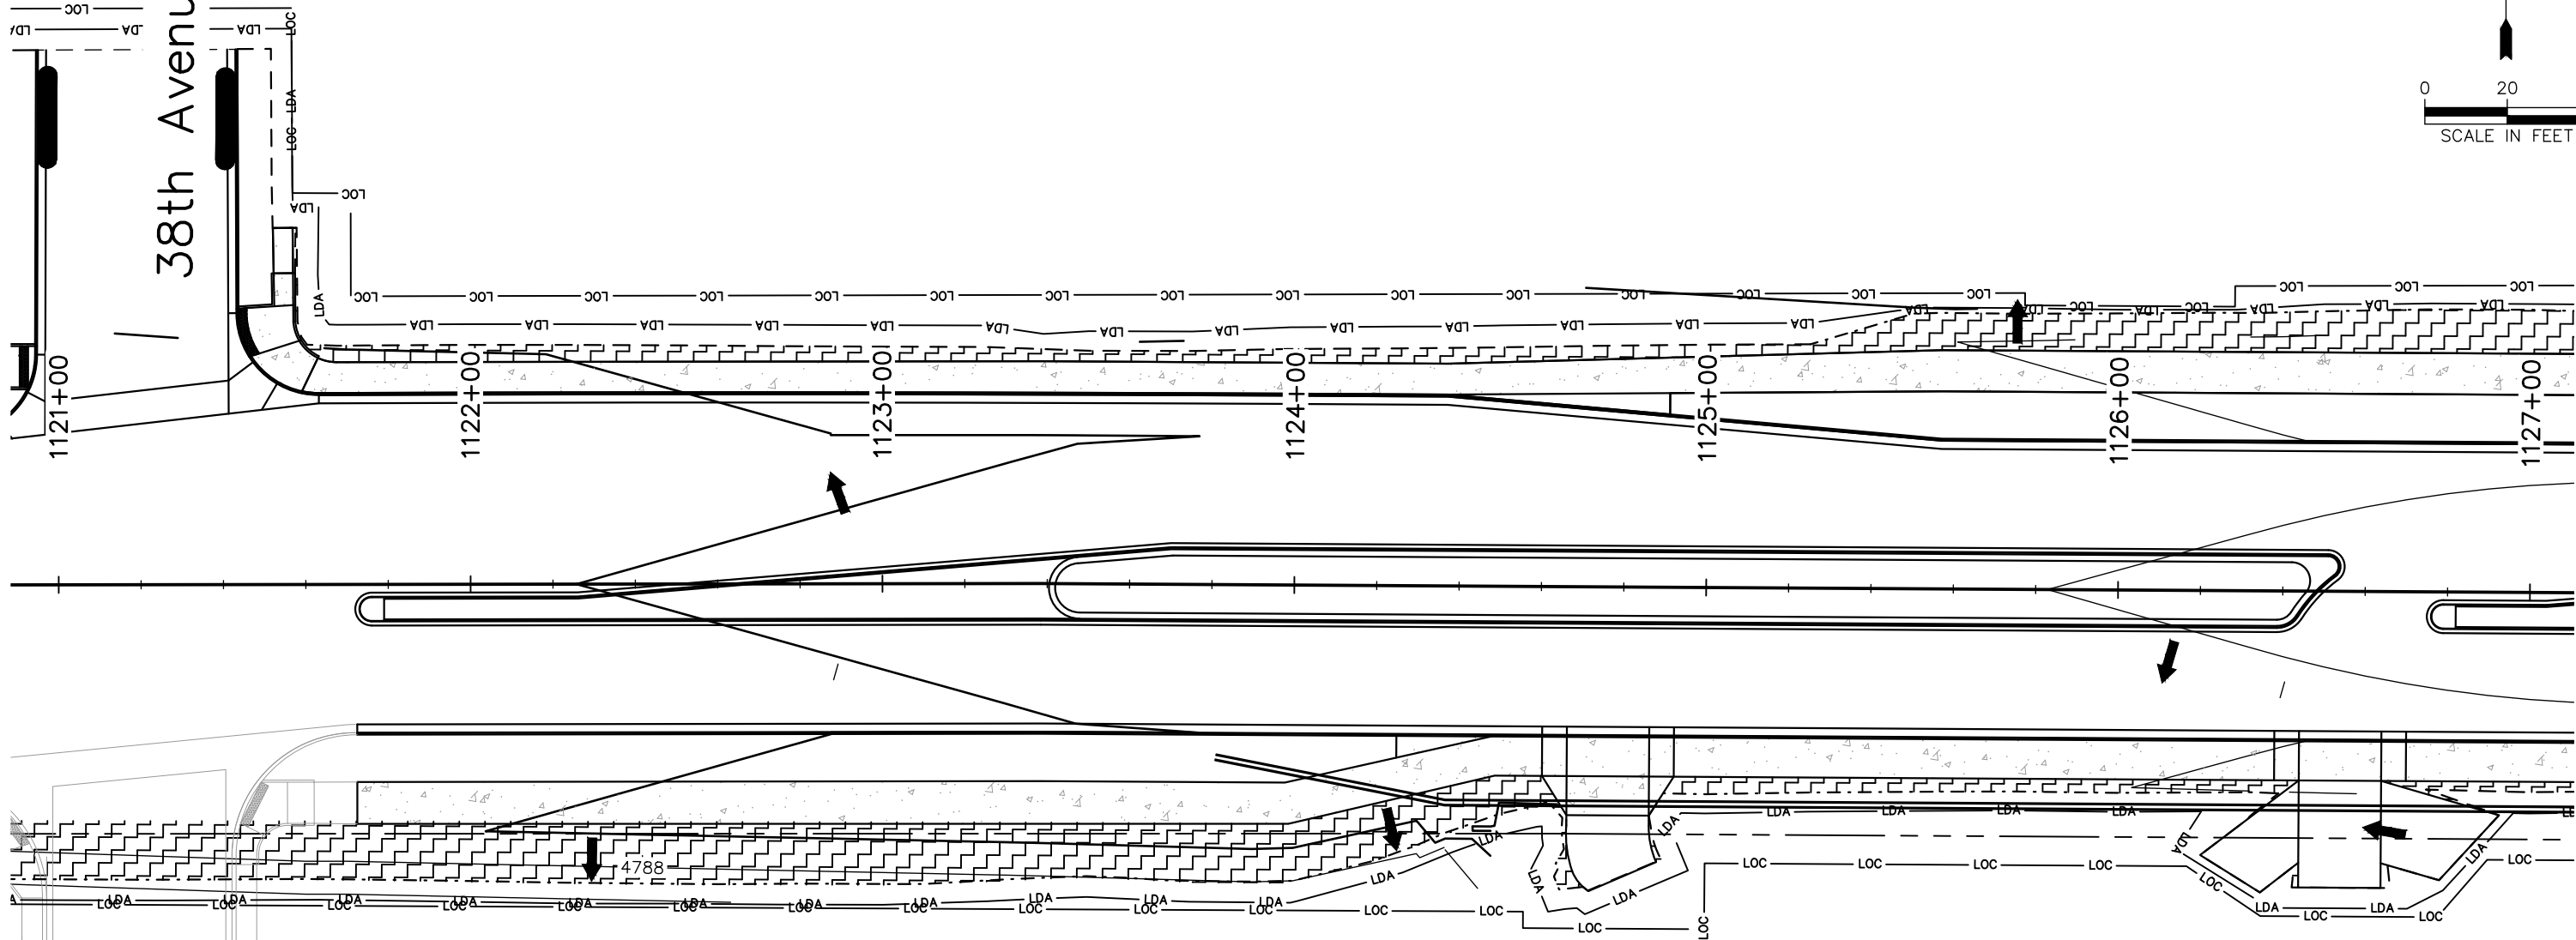


- Notes:
1. See landscape plans for placement of ornamental trees/shrubs within the Type II seeding areas.
 2. Control Measures are not drawn to scale and locations are approximate.

FINAL SWMP LEGEND:	
SYMBOL	DESCRIPTION (PROPOSED QUANTITY)
11+00	ROADWAY STATIONING
—LDA—	LIMITS OF DISTURBANCE
—LOC—	LIMITS OF CONSTRUCTION
---	TOE OF FILL
---	TOP OF CUT
➔	FLOW ARROW (DIRECTION OF FLOW)
⤿	PIPE EROSION LOG
	STORM DRAIN INLET PROTECTION (TYPE I)(84 INCH)
	STORM DRAIN INLET PROTECTION (TYPE II)
	NATIVE SEED MIX (TYPE I)
	NATIVE SEED MIX (TYPE II)





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	12076 Grant Street
	Thornton, CO 80241
	Ph: (303) 962-9300
	Fax: (303) 962-9350

	Sheet Revisions		
	Date	Comments	Initials

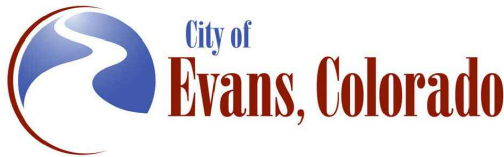

As Constructed	37TH STREET WIDENING PHASE 2B STORMWATER MANAGEMENT PLAN FINAL SWMP SITE MAP			Project No.
	No Revisions:			37TH STREET 2B
Revised:	Designer: J. Kirkling	Structure		Drawing Number ENVI-018
Void:	Detailer: S. Hemler	Numbers		Sheet Number 77
	Sheet Subset: SWMP	Subset Sheets: 16 of 18		

FOR CONSTRUCTION 5/1/2025

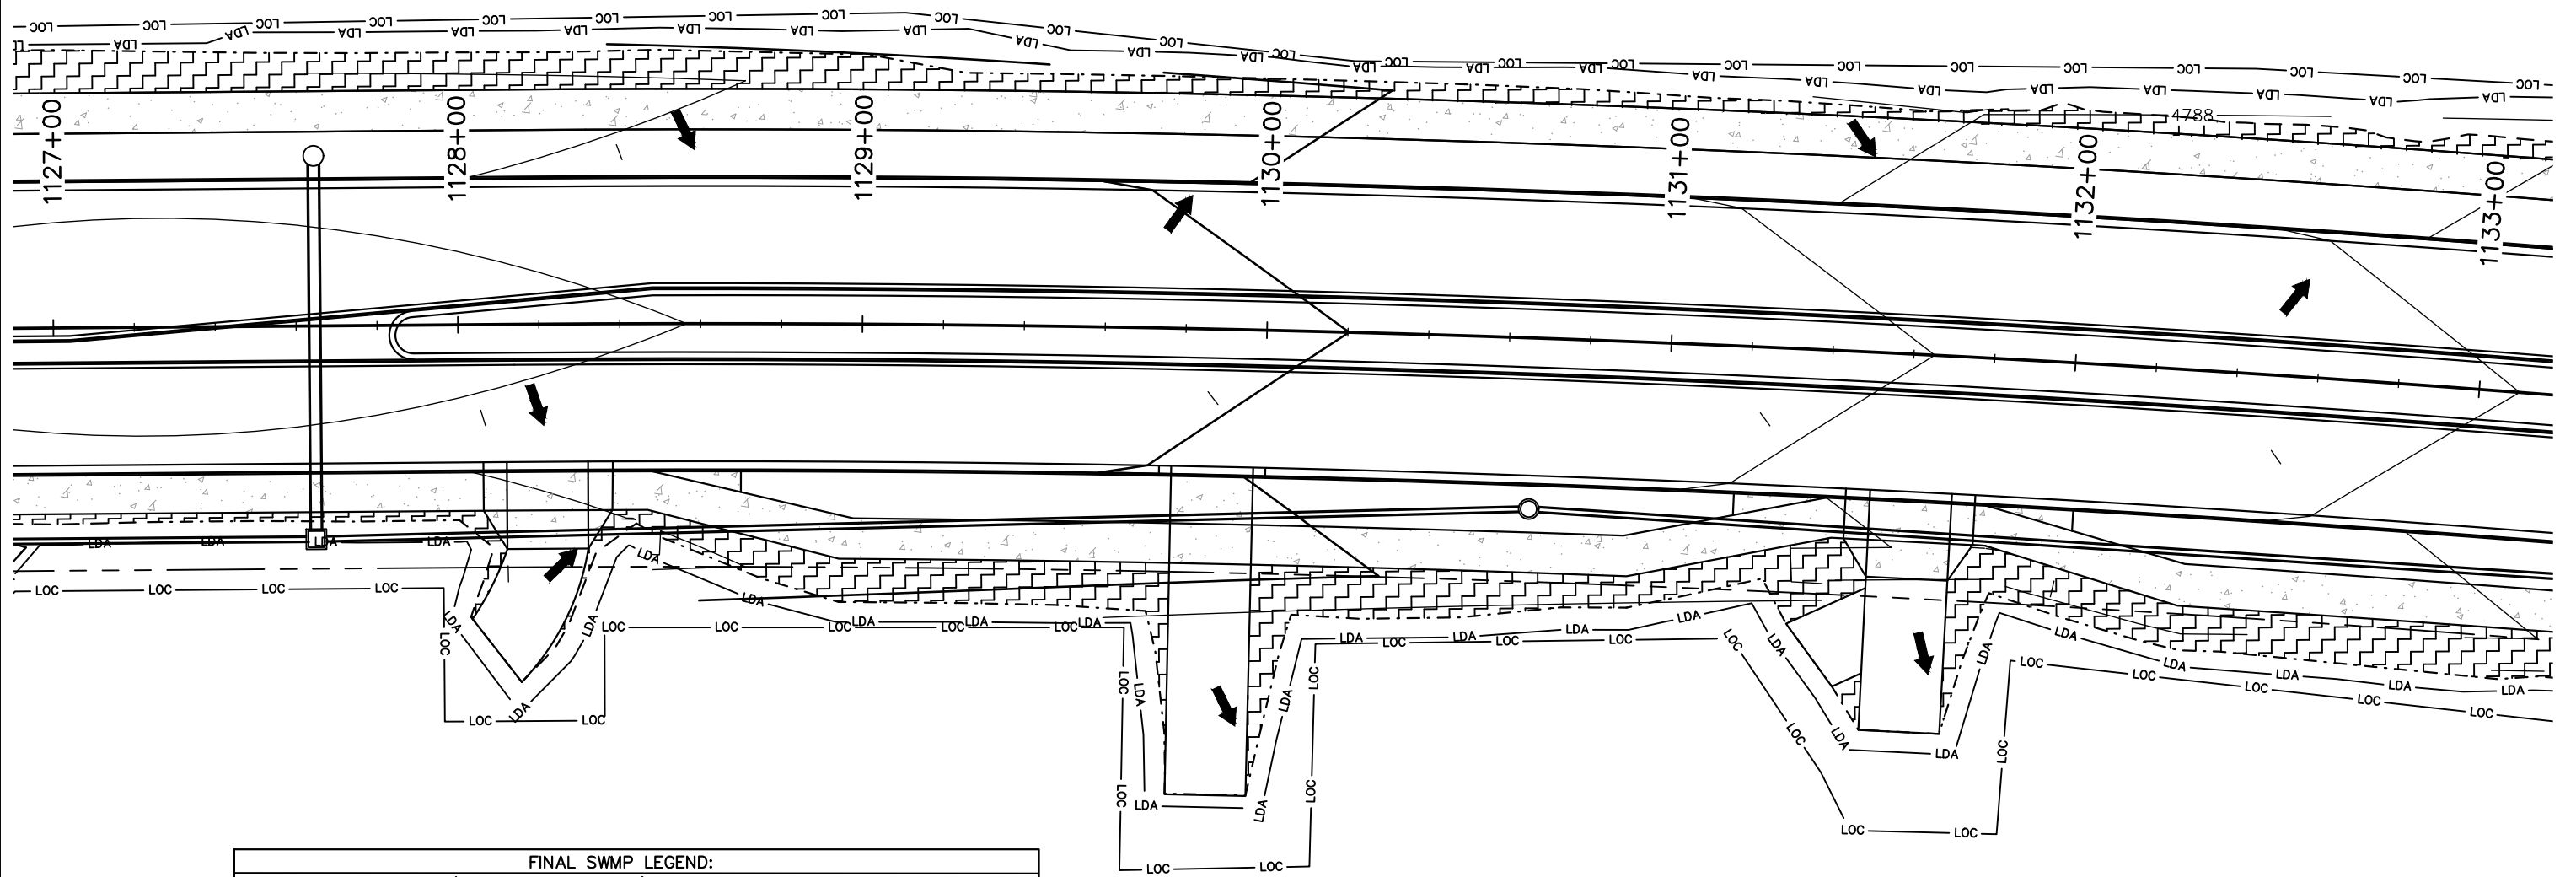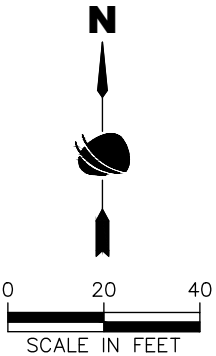

FINAL SWMP LEGEND:		
SYMBOL	DESCRIPTION (PROPOSED QUANTITY)	
11+00	ROADWAY STATIONING	
—LDA—	LIMITS OF DISTURBANCE	
—LOC—	LIMITS OF CONSTRUCTION	
---	TOE OF FILL	
---	TOP OF CUT	
➔	FLOW ARROW (DIRECTION OF FLOW)	
⤿	PIPE EROSION LOG	
	STORM DRAIN INLET PROTECTION (TYPE I)(84 INCH)	
	STORM DRAIN INLET PROTECTION (TYPE II)	
	NATIVE SEED MIX (TYPE I)	
	NATIVE SEED MIX (TYPE II)	

- Notes:
- See landscape plans for placement of ornamental trees/shrubs within the Type II seeding areas.
 - Control Measures are not drawn to scale and locations are approximate.




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Horiz. Scale: As Noted Vert. Scale: N/A


12076 Grant Street
Thornton, CO 80241
Ph: (303) 962-9300
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Sheet Revisions		
Date	Comments	Initials



As Constructed		37TH STREET WIDENING PHASE 2B STORMWATER MANAGEMENT PLAN FINAL SWMP SITE MAP		Project No.
No Revisions:		Designer: J. Kirkling		37TH STREET 2B
Revised:		Detailer: S. Hemler	Structure Numbers	Drawing Number ENVI-019
Void:		Sheet Subset: SWMP	Subset Sheets: 17 of 18	Sheet Number 78

FOR CONSTRUCTION 5/1/2025

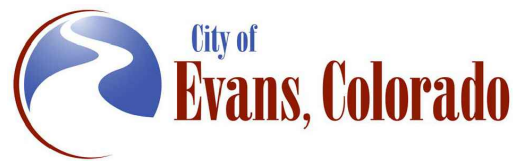

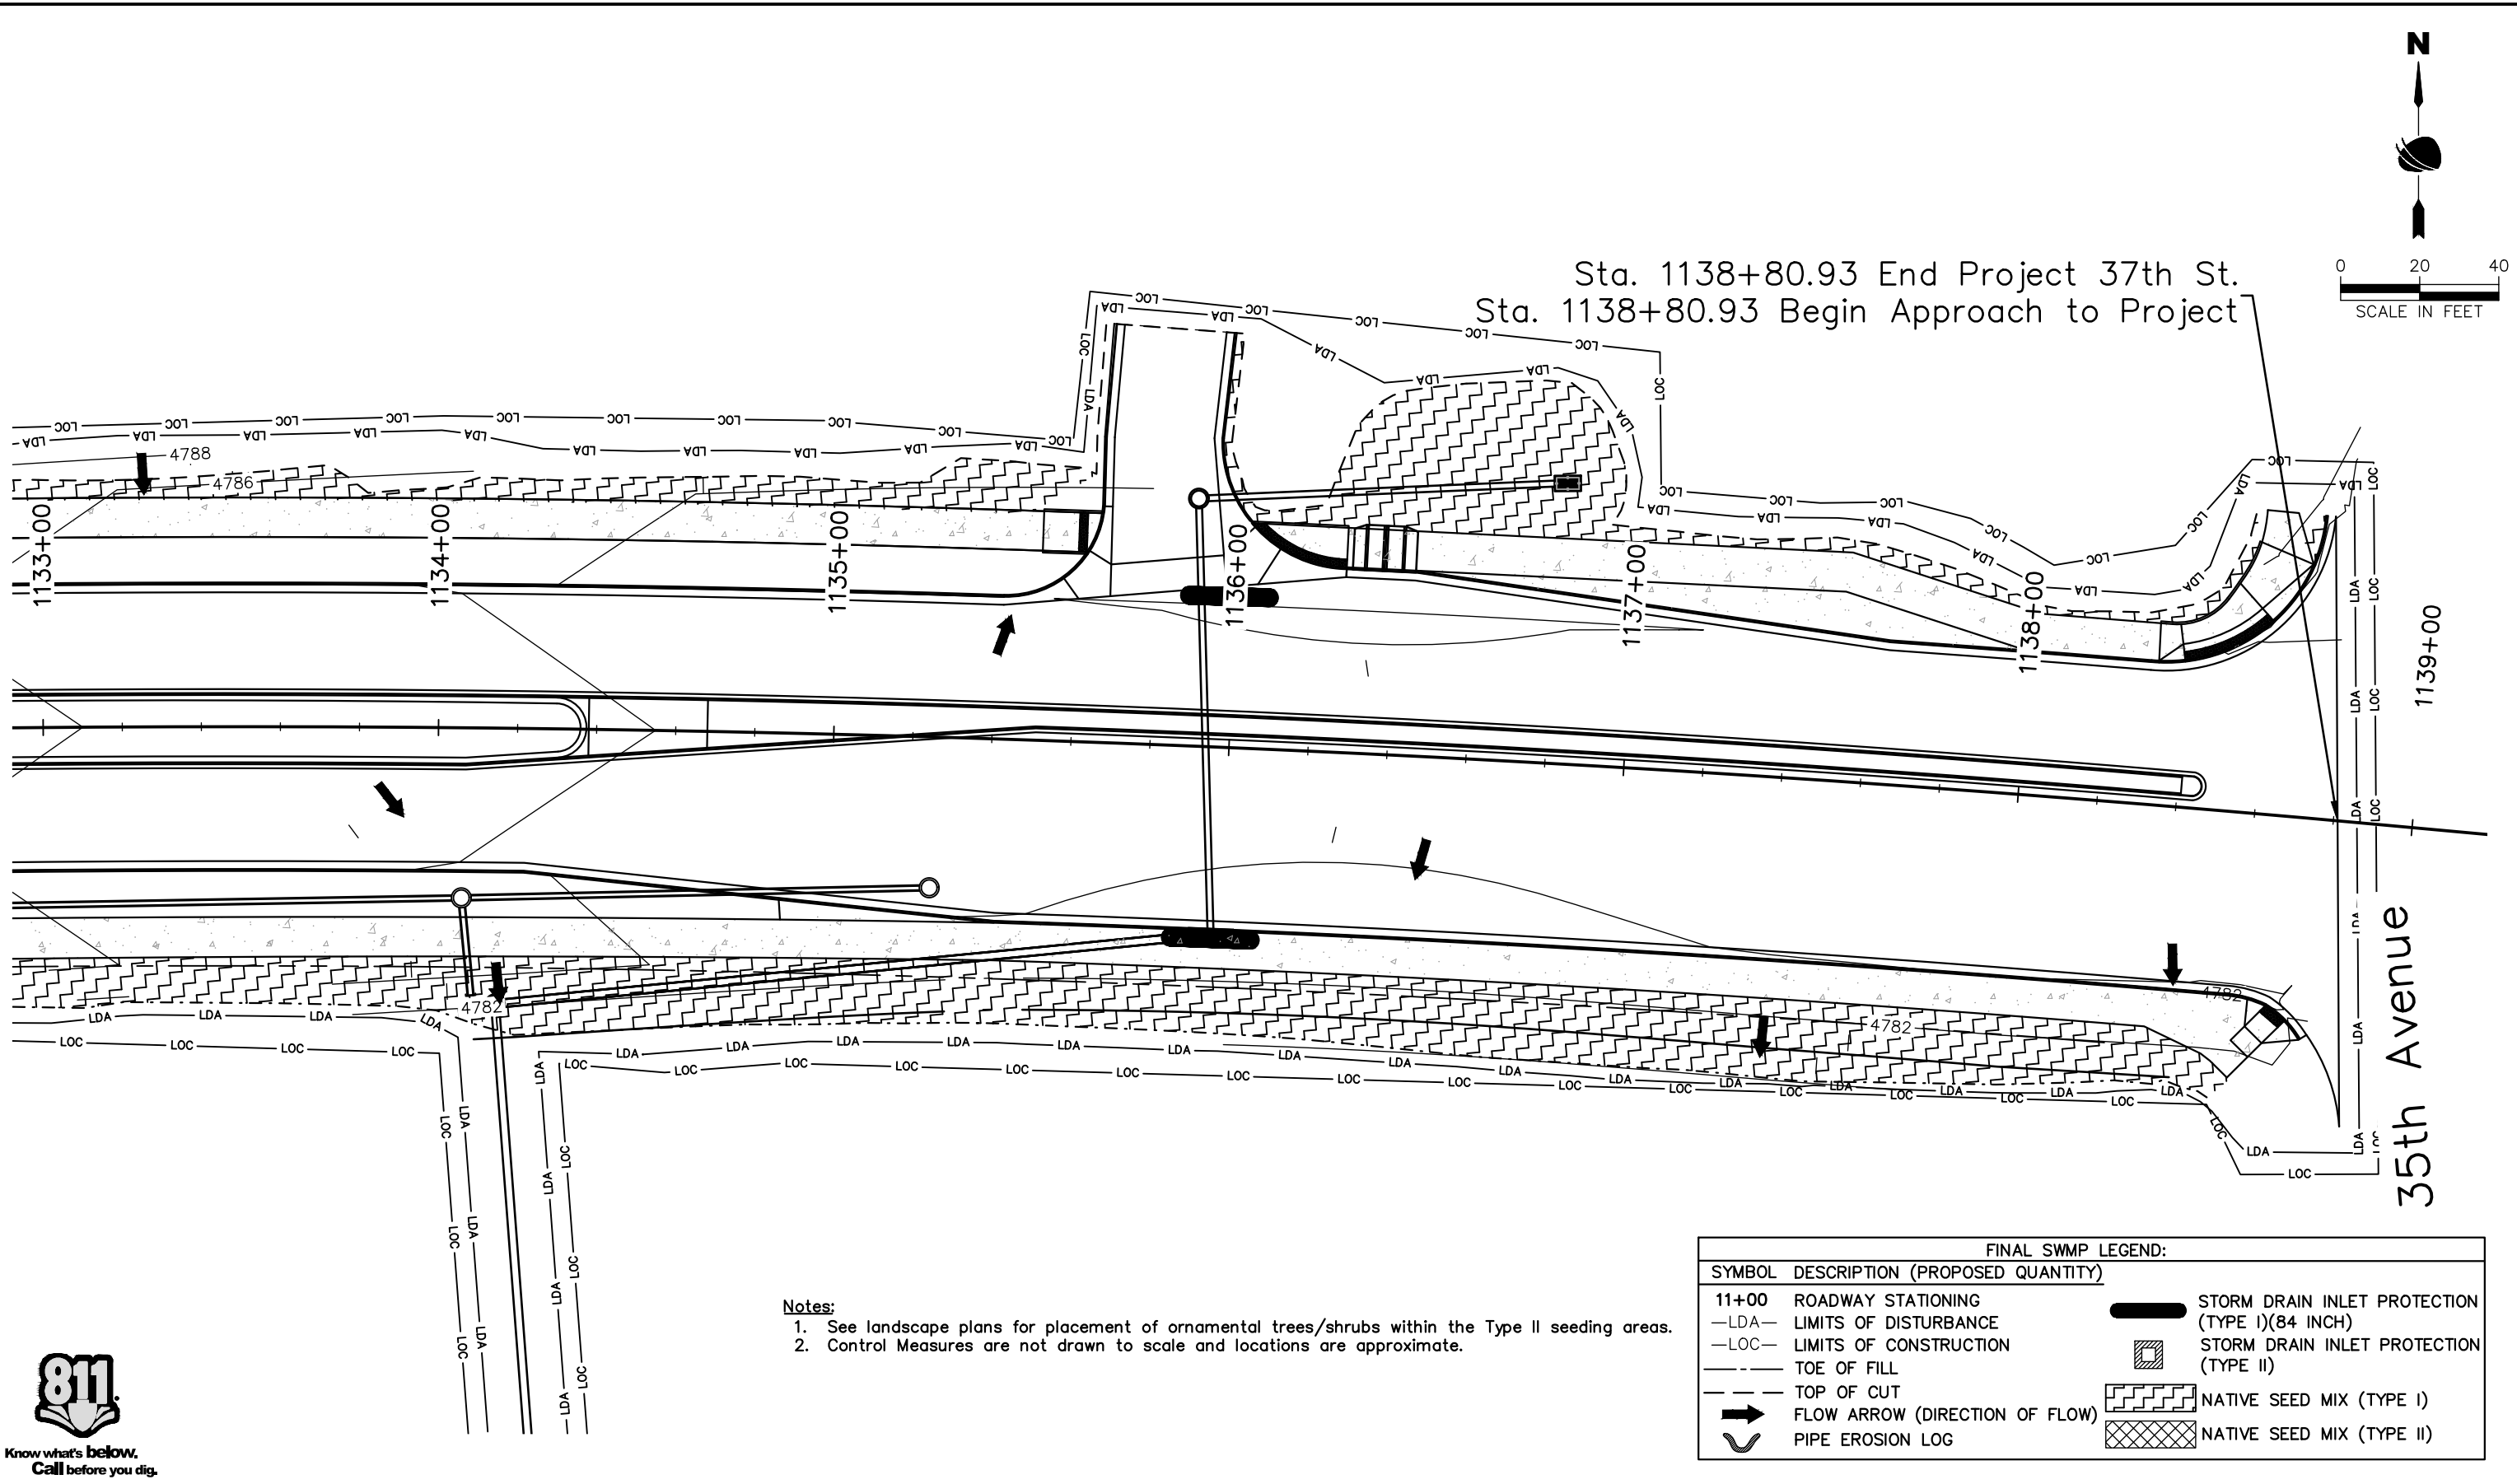- Notes:**
- 1. See landscape plans for placement of ornamental trees/shrubs within the Type II seeding areas.
 - 2. Control Measures are not drawn to scale and locations are approximate.

FINAL SWMP LEGEND:		
SYMBOL	DESCRIPTION (PROPOSED QUANTITY)	
11+00	ROADWAY STATIONING	
—LDA—	LIMITS OF DISTURBANCE	STORM DRAIN INLET PROTECTION (TYPE I)(84 INCH)
—LOC—	LIMITS OF CONSTRUCTION	STORM DRAIN INLET PROTECTION (TYPE II)
---	TOE OF FILL	NATIVE SEED MIX (TYPE I)
- - -	TOP OF CUT	NATIVE SEED MIX (TYPE II)
➔	FLOW ARROW (DIRECTION OF FLOW)	
U	PIPE EROSION LOG	



Print Date: 5/2/2025

File Name: ENVI P2B-027 FINAL SWMP PLAN.DWG

Horiz. Scale: As Noted

Vert. Scale: N/A

RockSol Consulting Group, Inc.

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Thornton, CO 80241
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Sheet Revisions		
Date	Comments	Initials

City of Evans, Colorado

FREEDOM Parkway

As Constructed

No Revisions:

Revised:

Void:

37TH STREET WIDENING PHASE 2B
STORMWATER MANAGEMENT PLAN
FINAL SWMP SITE MAP

Designer: J. Kirkling

Detailer: S. Hemler

Sheet Subset: SWMP

Structure Numbers

Subset Sheets: 18 of 18

Project No.

37TH STREET 2B

Drawing Number ENVI-020

Sheet Number 79

Plot Date: 5/2/2025 6:51 AM Plotted By: Sarah Hemler
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FOR CONSTRUCTION 5/1/2025

Plot Date: 5/2/2025 6:51 AM Plotted By: Sarah Hemler
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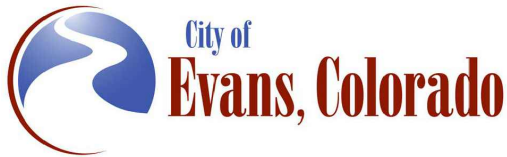


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	Ph: (303) 962-9300
	Fax: (303) 962-9350

Sheet Revisions

Date	Comments	Initials



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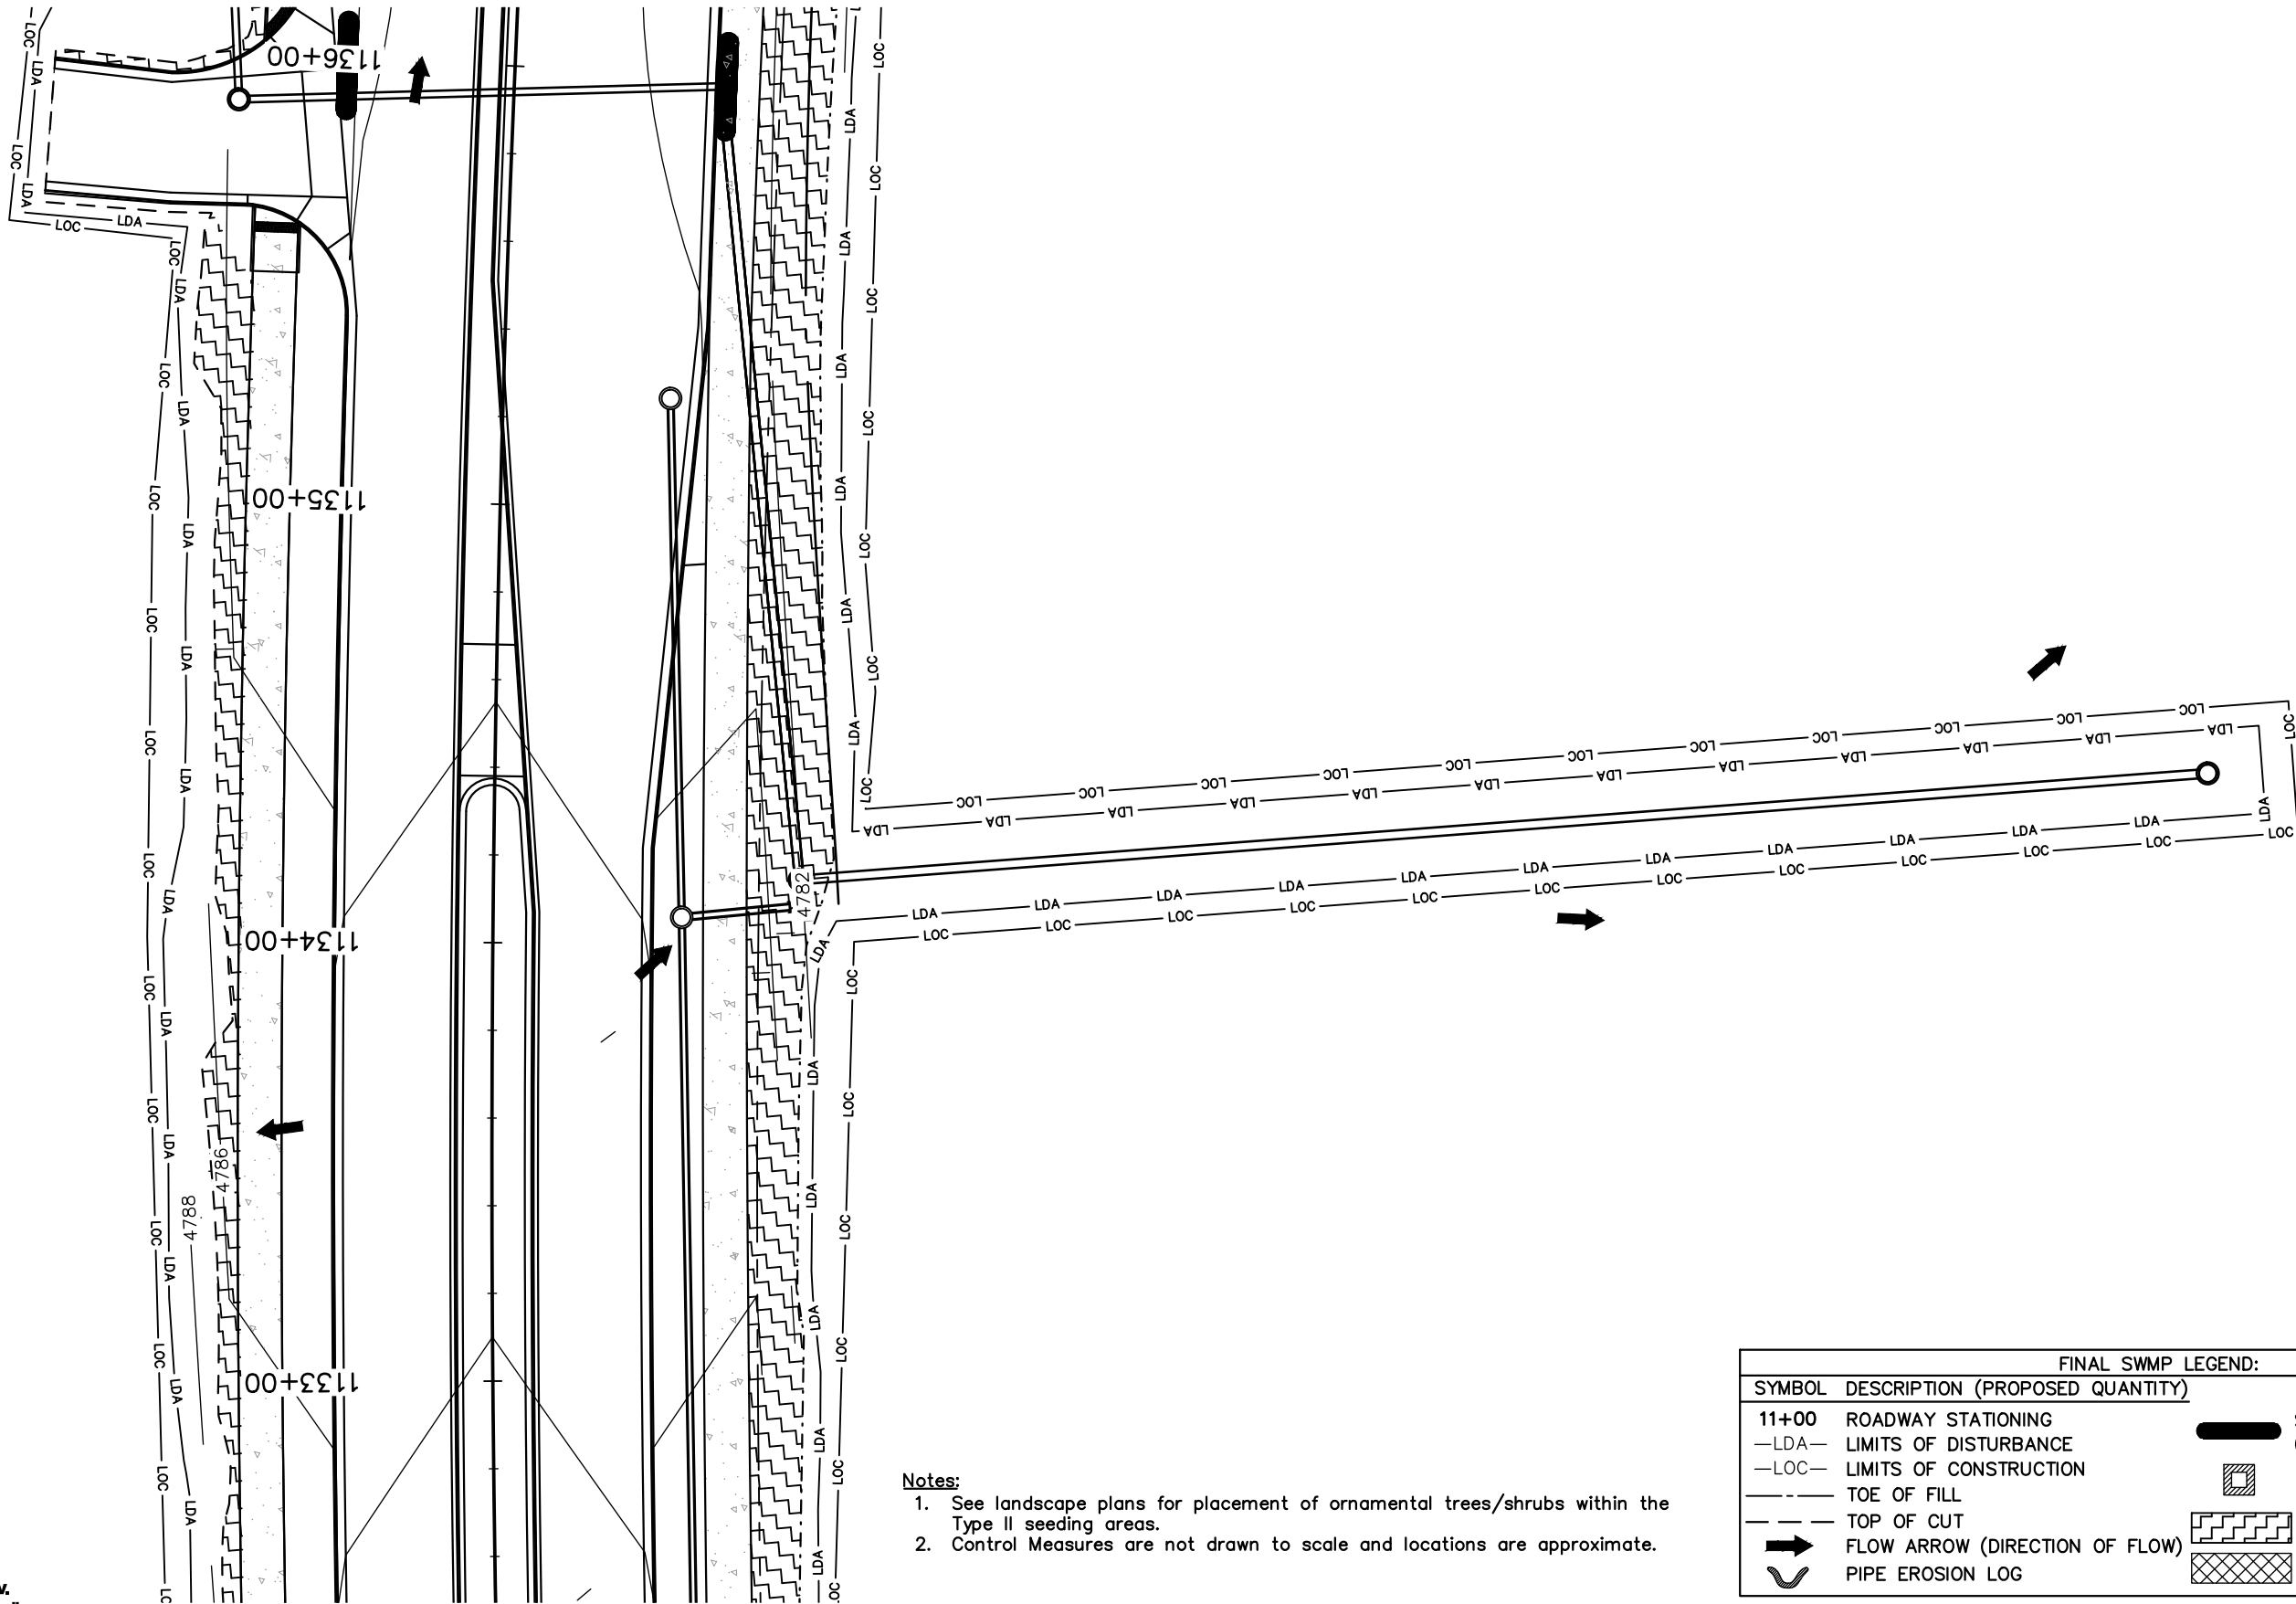
No Revisions:
Revised:
Void:

37TH STREET WIDENING PHASE 2B STORMWATER MANAGEMENT PLAN FINAL SWMP SITE MAP

Designer:	J. Kirkling	Structure	
Detailer:	S. Hemler	Numbers	
Sheet Subset:	SWMP	Subset Sheets:	18 of 18

Project No.


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Drawing Number ENVI-021
Sheet Number 80



Notes:

- See landscape plans for placement of ornamental trees/shrubs within the Type II seeding areas.
- Control Measures are not drawn to scale and locations are approximate.

FINAL SWMP LEGEND:	
SYMBOL	DESCRIPTION (PROPOSED QUANTITY)
11+00	ROADWAY STATIONING
—LDA—	LIMITS OF DISTURBANCE
—LOC—	LIMITS OF CONSTRUCTION
---	TOE OF FILL
---	TOP OF CUT
➔	FLOW ARROW (DIRECTION OF FLOW)
⤿	PIPE EROSION LOG
	STORM DRAIN INLET PROTECTION (TYPE I)(84 INCH)
	STORM DRAIN INLET PROTECTION (TYPE II)
	NATIVE SEED MIX (TYPE I)
	NATIVE SEED MIX (TYPE II)

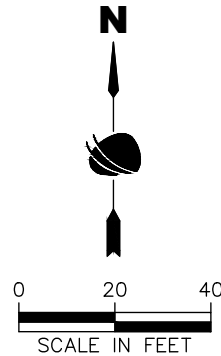

FOR CONSTRUCTION 5/1/2025

Plot Date: 6/11/2024 1:20 PM, Plotted By: David Eiger, C:\Users\DOUGLAS\OneDrive - BRIDGESON PROJECTS\1914_37TH STREET WIDENING PHASE 2B\DWG\1914_37TH LANDSCAPE PLANP2B.DWG

LANDSCAPE SHEET INDEX


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LS-2	LANDSCAPE PLAN
LS-3	LANDSCAPE PLAN
LS-4	LANDSCAPE PLAN
LS-5	LANDSCAPE PLAN
LS-6	LANDSCAPE PLAN
LS-7	MULCH & BOULDER PLAN
LS-8	MULCH & BOULDER PLAN
LS-9	MULCH & BOULDER PLAN
LS-10	MULCH & BOULDER PLAN
LS-11	MULCH & BOULDER PLAN
LS-12	PLANT LIST
LS-13	LANDSCAPE NOTES
LS-14	LANDSCAPE DETAILS
LS-15	LANDSCAPE DETAILS
LS-16	LANDSCAPE DETAILS
LS-17	LANDSCAPE DETAILS

SUMMARY OF QUANTITIES

ITEM #	ITEM DESC.	UNIT	QTY
207-00405	Topsoil (Special) - 4" at Sod and 6" Beds outside of Median, 18" In Median	CY	1317
213-00005	Wood (Organic) Mulch (Brown Western Cedar)(4" Depth)	CY	228
213-00067	Inorganic Mulch (1.5" to 3" Tan River Rock)(3" Depth)(Special)	SF	5324
213-00440	Metal Landscape Border (1/8" x 4")	LF	1054
213-00318	18 Inch Root Barrier	LF	1280
213-00705	Landscape Boulder A (Siloam)(4'l. x 2'w. x 2'h.)(Special)	EACH	44
213-00705	Landscape Boulder B (Siloam) (3'l. x 2'w. x 2'h.)(Special)	EACH	39
213-00705	Landscape Boulder C (Siloam) (2'l. x 2'w. x 2'h.)(Special)	EACH	54
214-00220	Deciduous Tree (2" Cal.)	EACH	35
214-00230	Deciduous Ornamental Tree (1.5" Cal.)	EACH	18
214-00350	Deciduous Shrub (5 Gal.)	EACH	118
214-00650	Evergreen Shrub (5 Gal.)	EACH	27
214-00908	Ornamental Grasses and Perennials (1 Gal.)	EACH	209
623-09900	Irrigation System	LS	1




SHEET KEY MAP

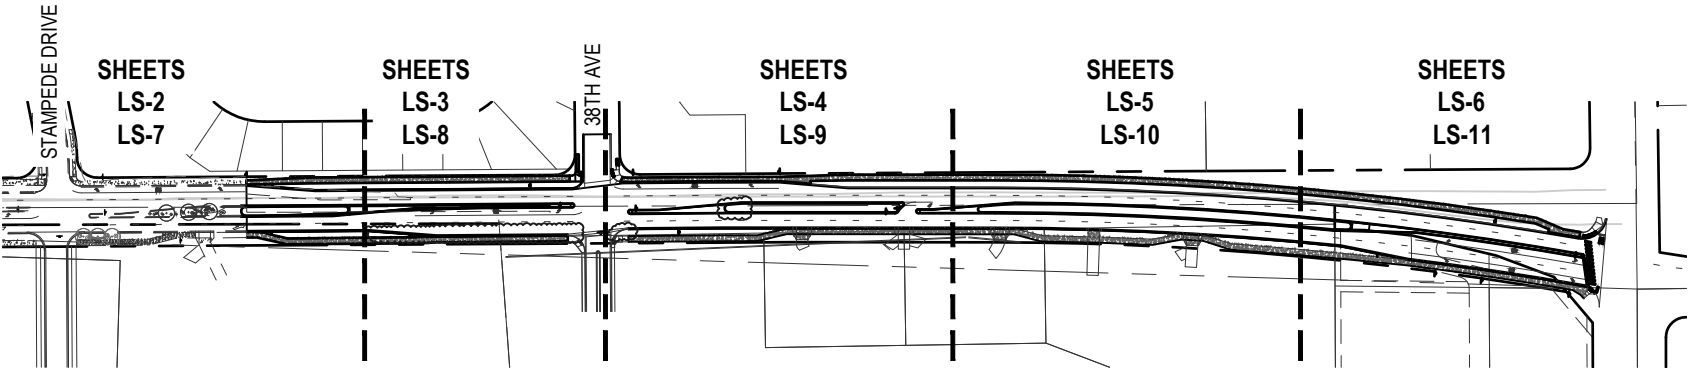

Print Date: 12/4/2024	
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Horiz. Scale: As Noted	Vert. Scale: As Noted
PRIME CONSULTANT:	SUB CONSULTANT:
 RockSol Consulting Group, Inc.	 bha



Sheet Revisions		
Date:	Comments	Init.

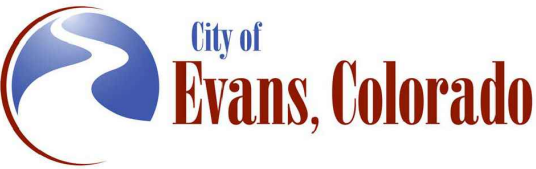

As Constructed	37TH STREET WIDENING PHASE 2B LANDSCAPE PLAN			Project No.
No Revisions:				AQC M415-021
Revised:	Designer: DE	Structure		Drawing Number LS-1
Void:	Detailer: DE	Numbers		Sheet Number 81
	Sheet Subset: LANDSCAPE	Subset Sheets:1	of 17	

LEGEND

DECIDUOUS SHADE TREE

ORNAMENTAL TREE

DECIDUOUS SHRUB

EVERGREEN SHRUBS



ORNAMENTAL GRASS

PERENNIAL

SEED - TYPE 1, RE: SWMP

SEED - TYPE 2, RE: SWMP

NOTES:
CONTRACTOR RESPONSIBLE FOR
RESTORING AREAS AFFECTED BY
GRADING OR CONSTRUCTION BEYOND
THOSE AREAS INDICATED ON THIS PLAN

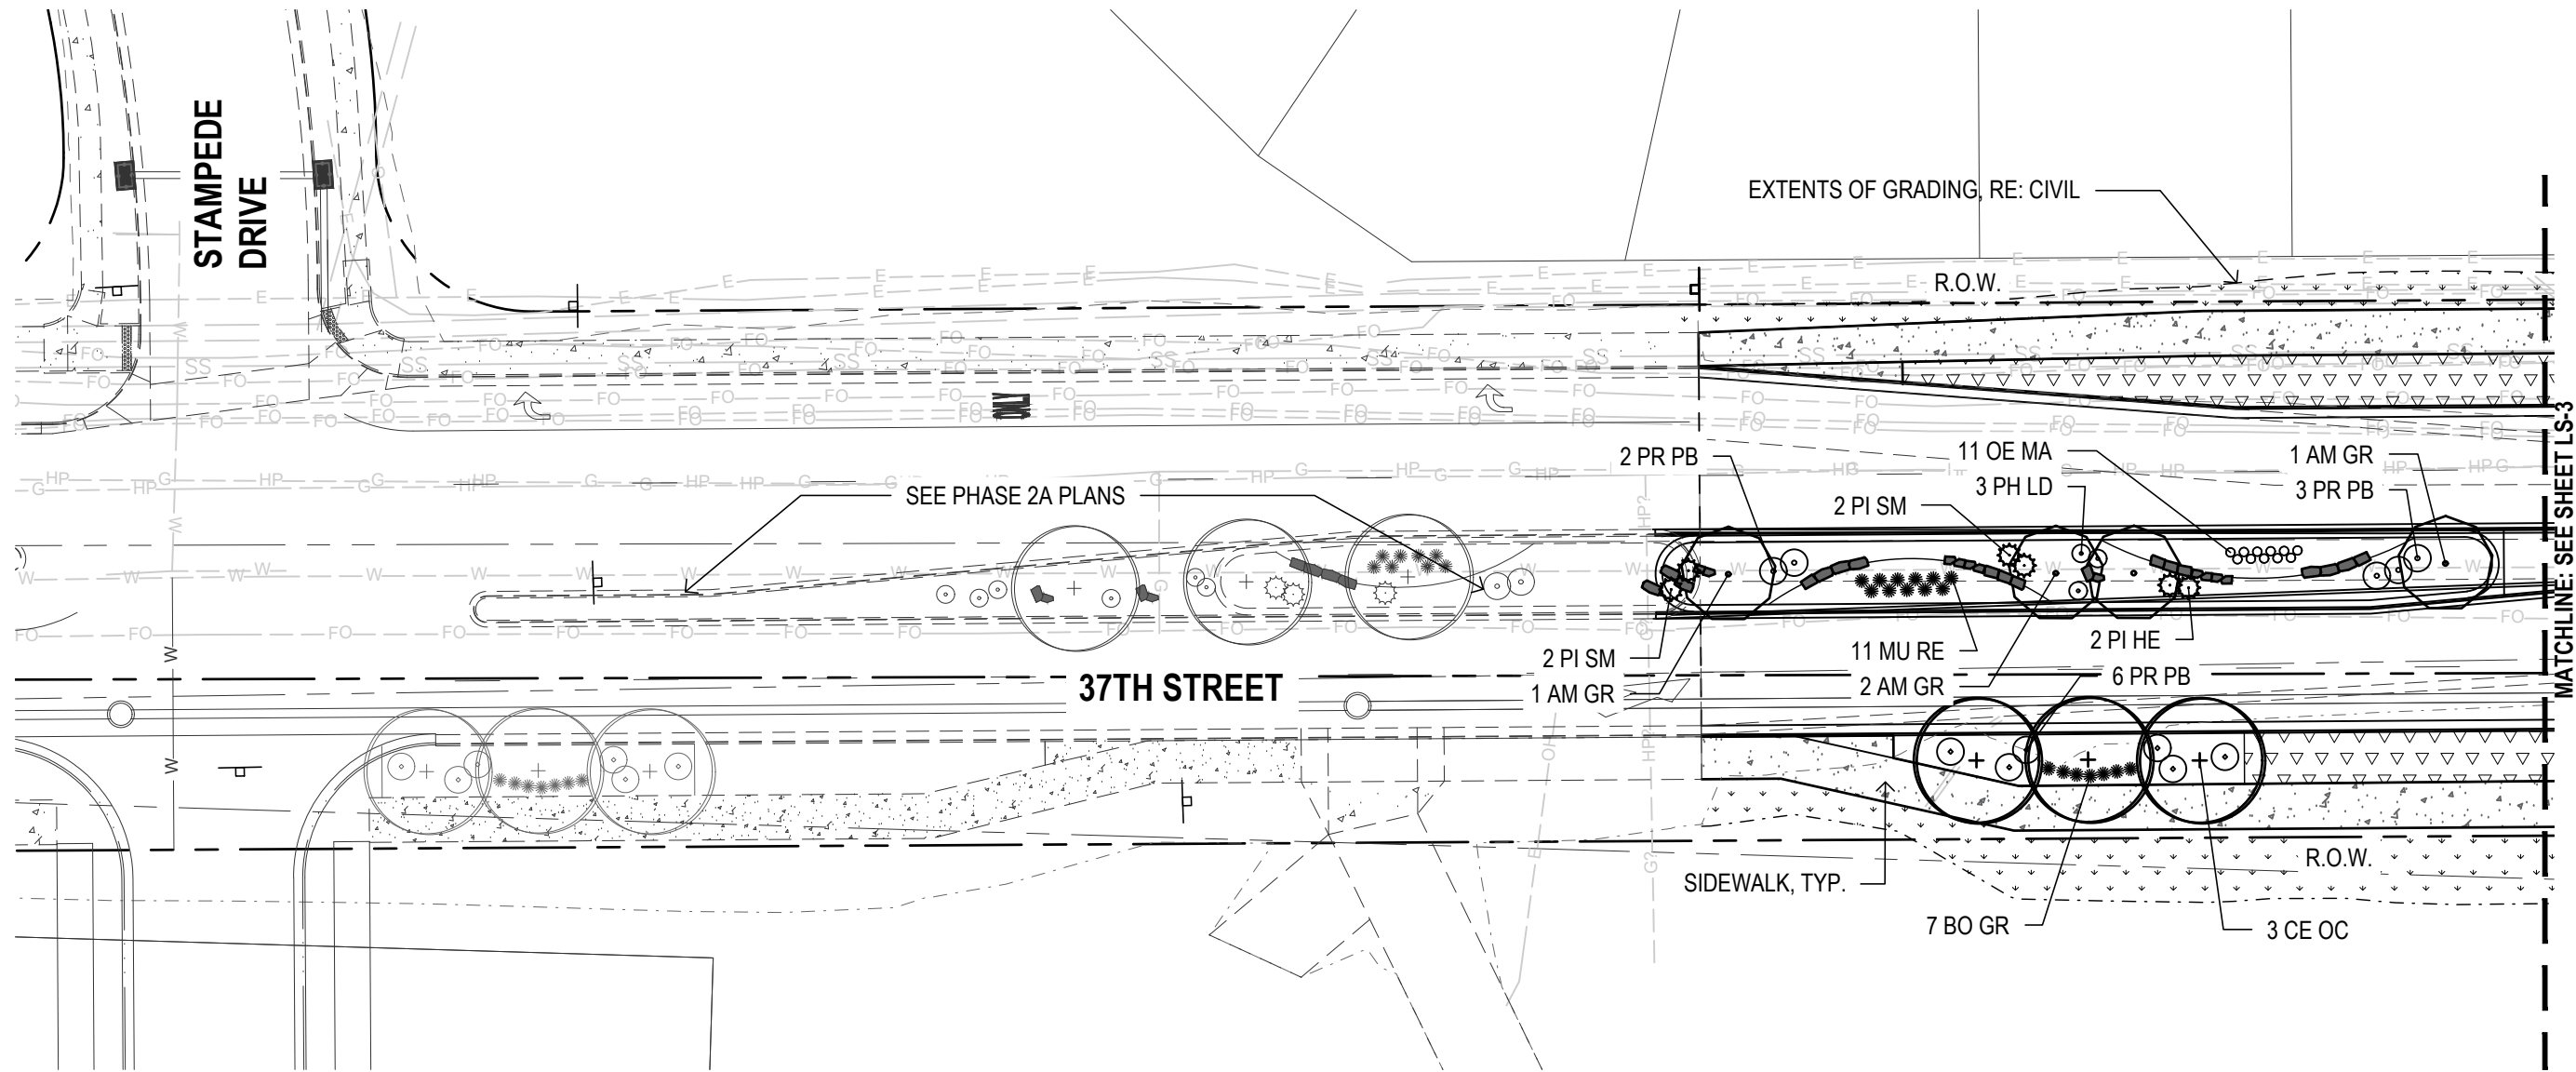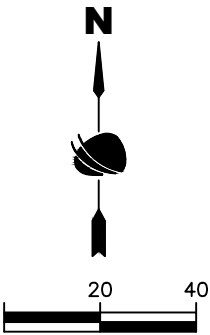


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PRIME CONSULTANT:	SUB CONSULTANT:
Consulting Group, Inc.	





Sheet Revisions		
Date:	Comments	Init.



As Constructed		37TH STREET WIDENING PHASE 2B LANDSCAPE PLAN		Project No.
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Revised:	Designer: DE	Structure		Drawing Number LS-2
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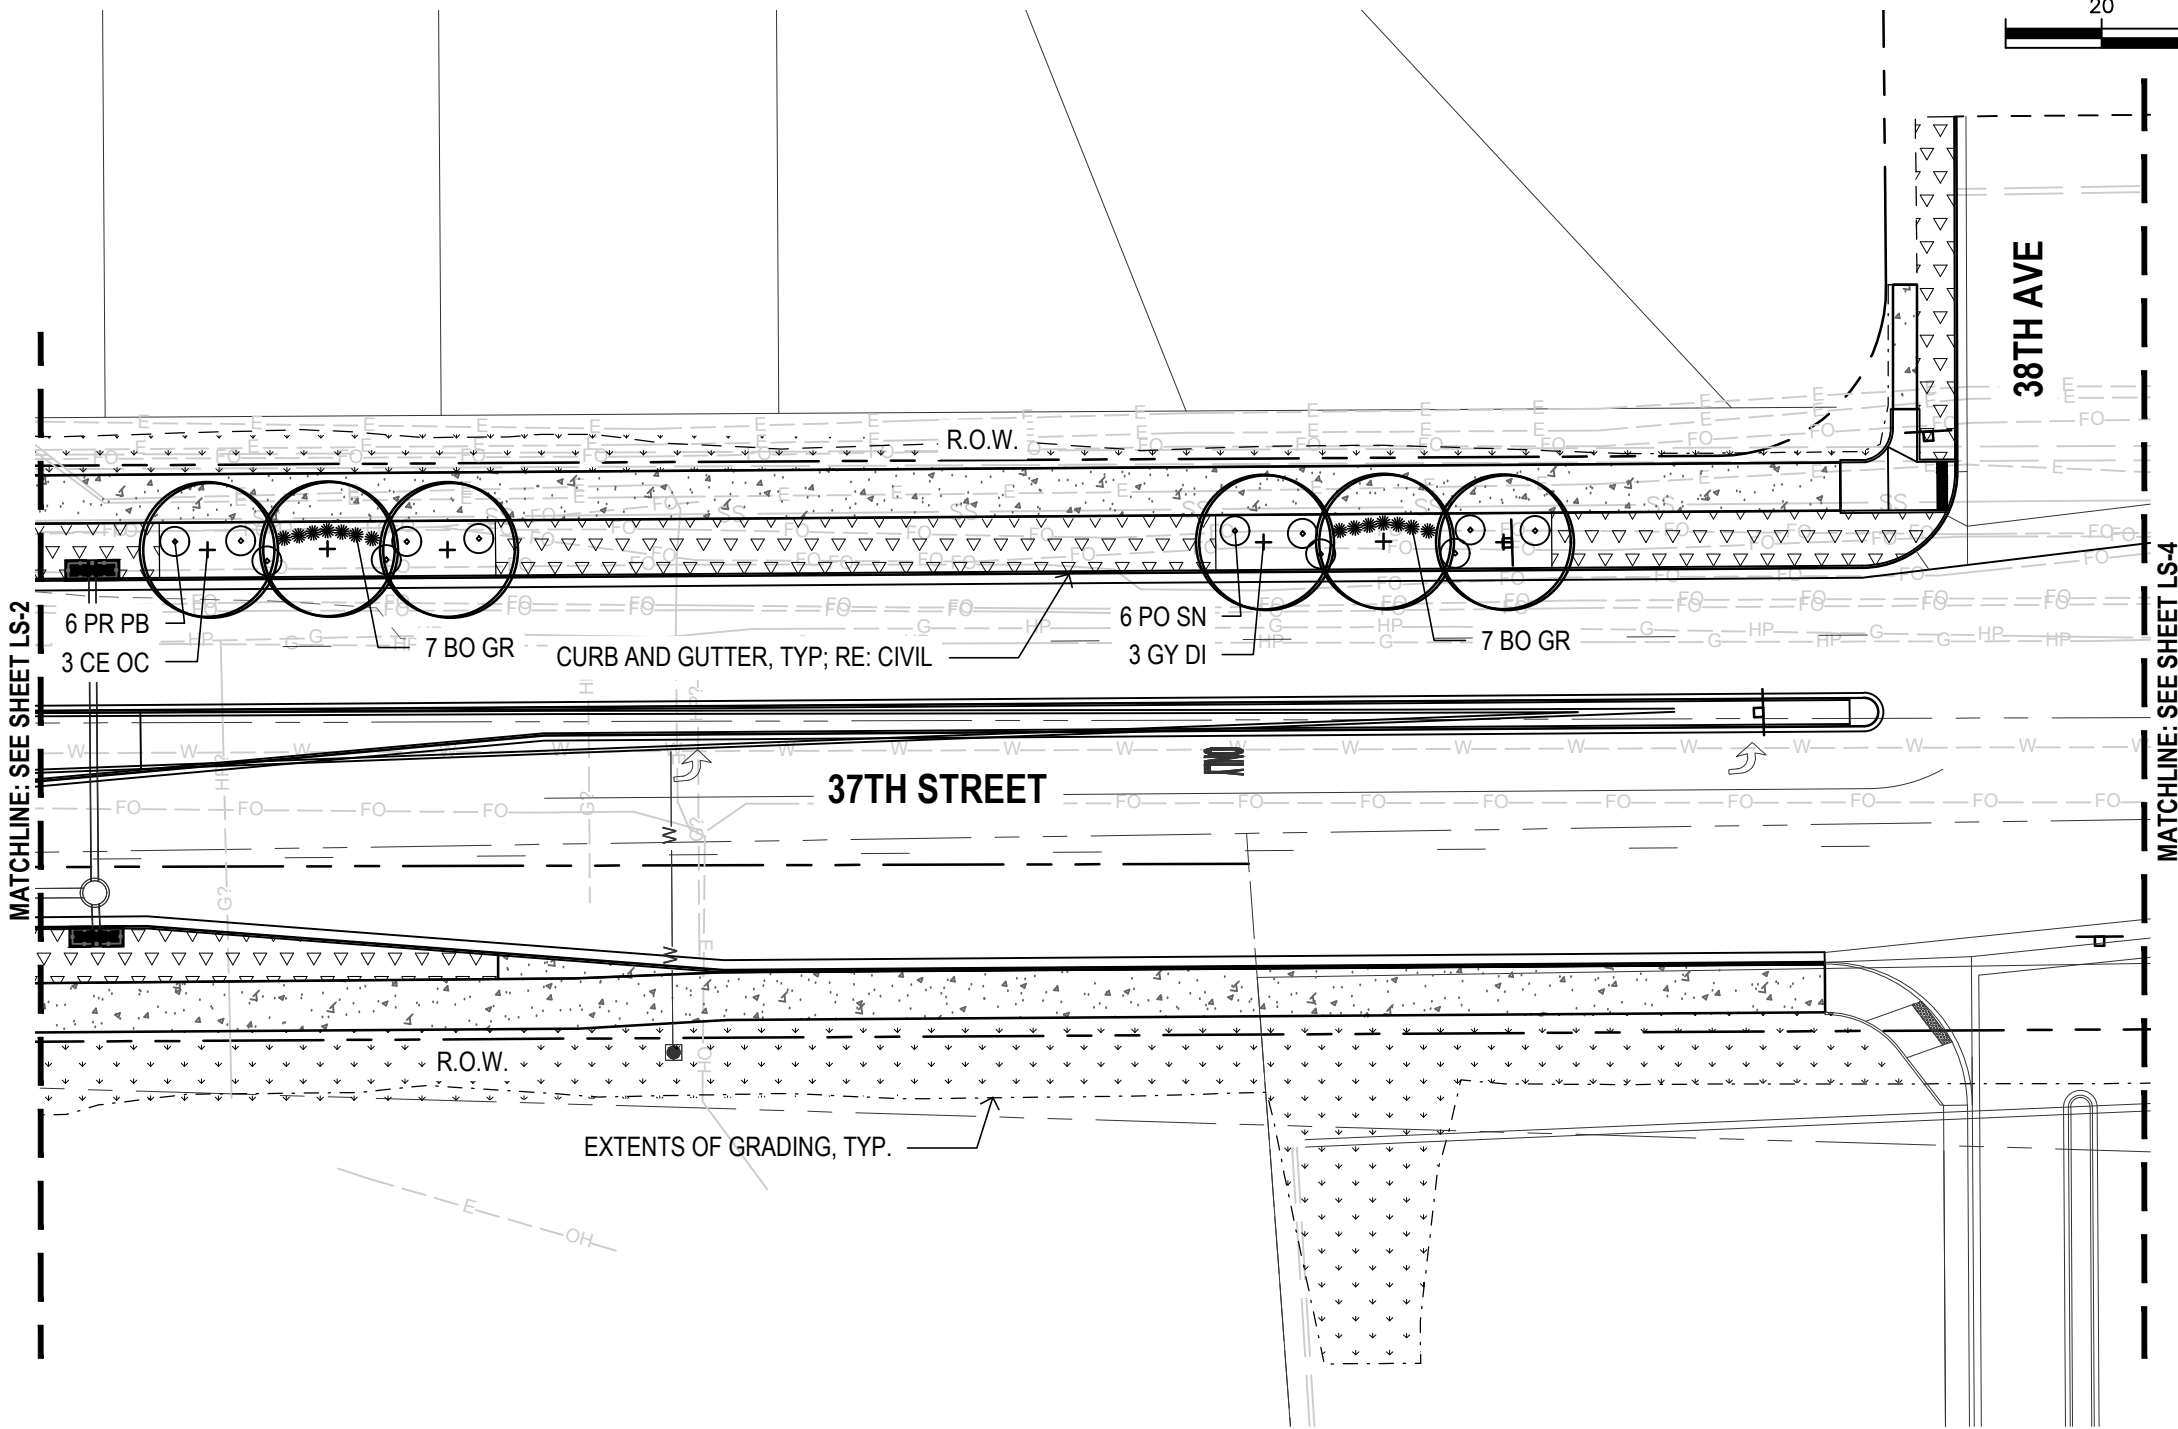
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LEGEND

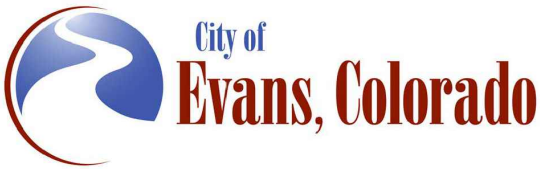


SEED - TYPE 1, RE: SWMP
SEED - TYPE 2, RE: SWMP

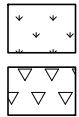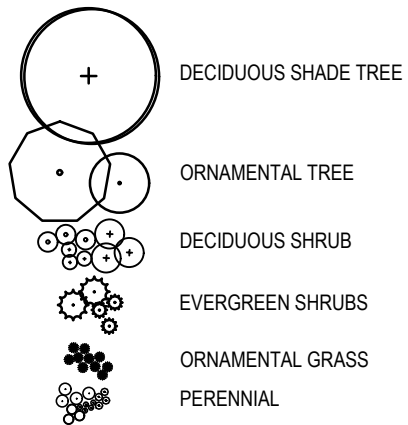NOTES:
CONTRACTOR RESPONSIBLE FOR
RESTORING AREAS AFFECTED BY
GRADING OR CONSTRUCTION BEYOND
THOSE AREAS INDICATED ON THIS PLAN




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Horiz. Scale: As Noted Vert. Scale: As Noted
PRIME CONSULTANT: SUB CONSULTANT:

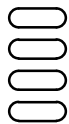

Sheet Revisions

Date:	Comments	Init.

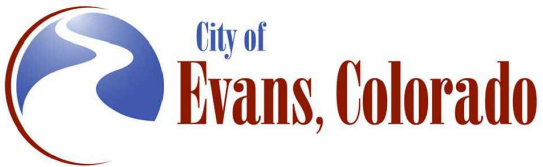

As Constructed

No Revisions:

Revised:

Void:

37TH STREET WIDENING PHASE 2B
LANDSCAPE PLAN

Designer: DE
Detailer: DE
Sheet Subset: LANDSCAPE

Structure
Numbers

Subset Sheets: 3 of 17

Project No.


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Drawing Number LS-3


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LEGEND





DECIDUOUS SHADE TREE
ORNAMENTAL TREE
DECIDUOUS SHRUB
EVERGREEN SHRUBS
ORNAMENTAL GRASS
PERENNIAL

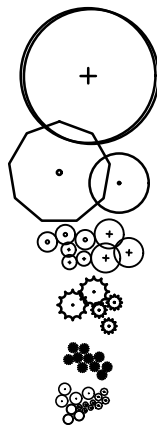

SEED - TYPE 1, RE: SWMP
SEED - TYPE 2, RE: SWMP

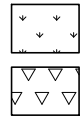NOTES:
CONTRACTOR RESPONSIBLE FOR
RESTORING AREAS AFFECTED BY
GRADING OR CONSTRUCTION BEYOND
THOSE AREAS INDICATED ON THIS PLAN

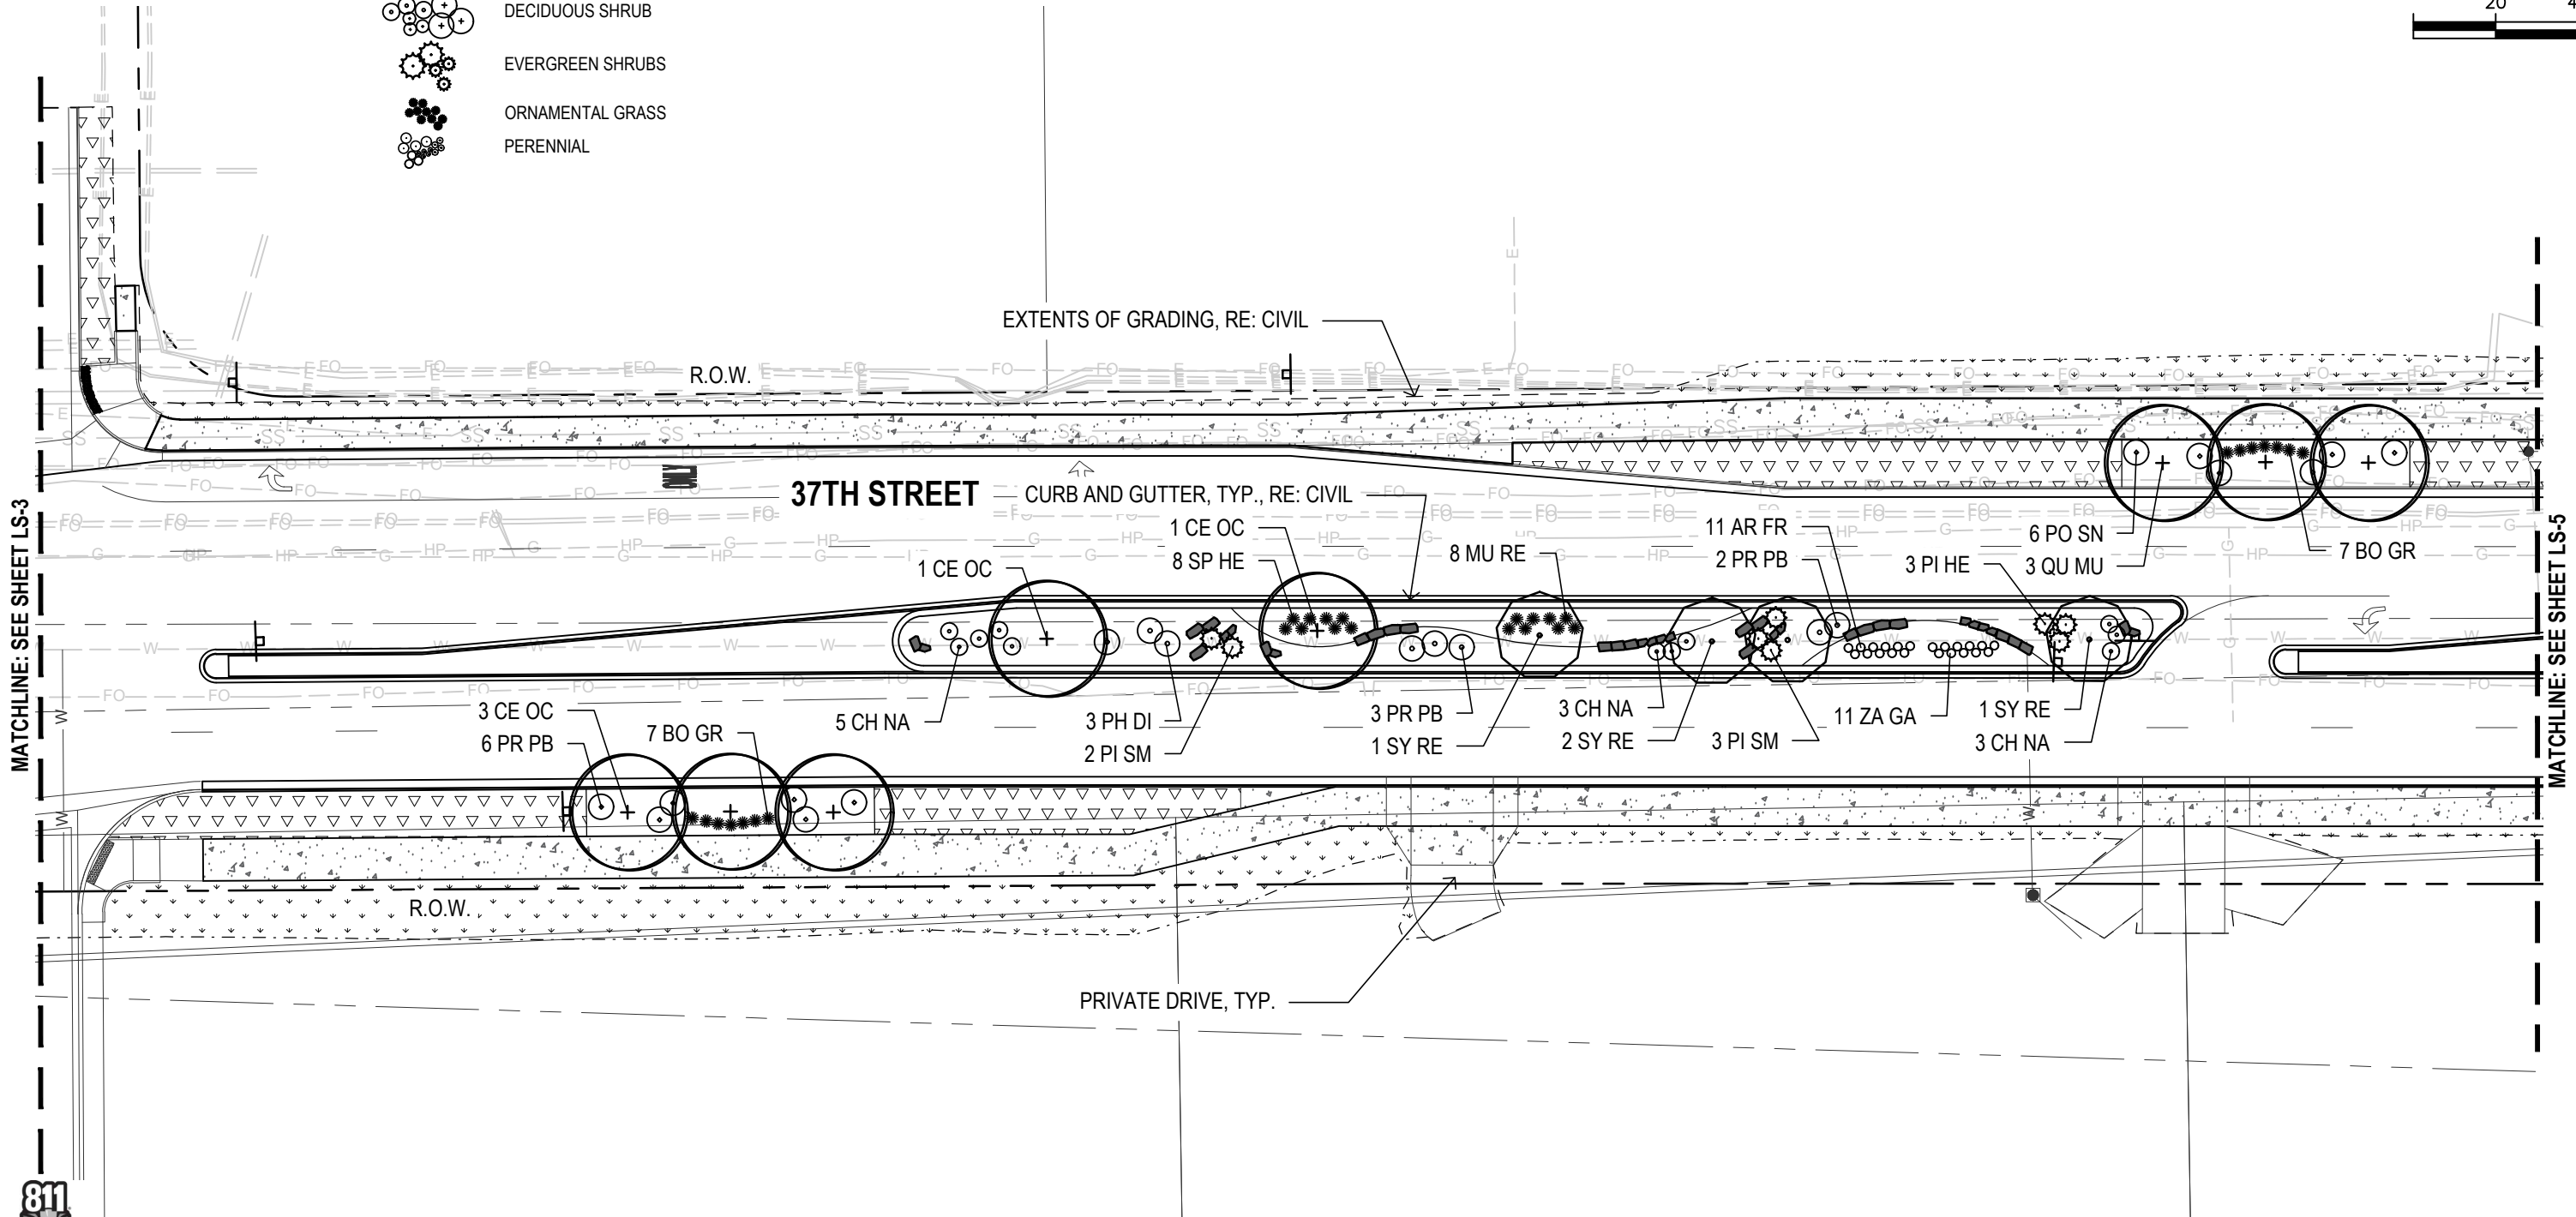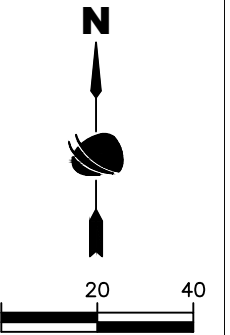


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
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Date:	Comments	Init.	





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
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
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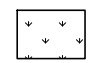
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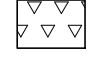
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DECIDUOUS SHRUB
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EVERGREEN SHRUBS
- 



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PERENNIAL
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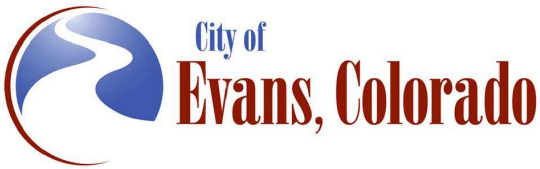
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NOTES:
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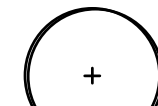
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

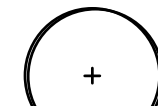

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
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
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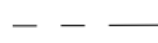
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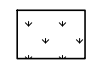
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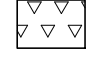
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DECIDUOUS SHRUB
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EVERGREEN SHRUBS
- 



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PERENNIAL
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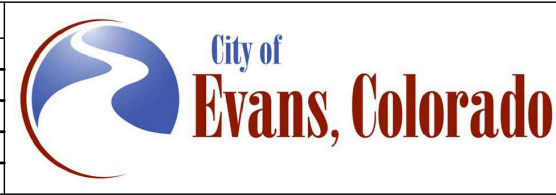
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THOSE AREAS INDICATED ON THIS PLAN

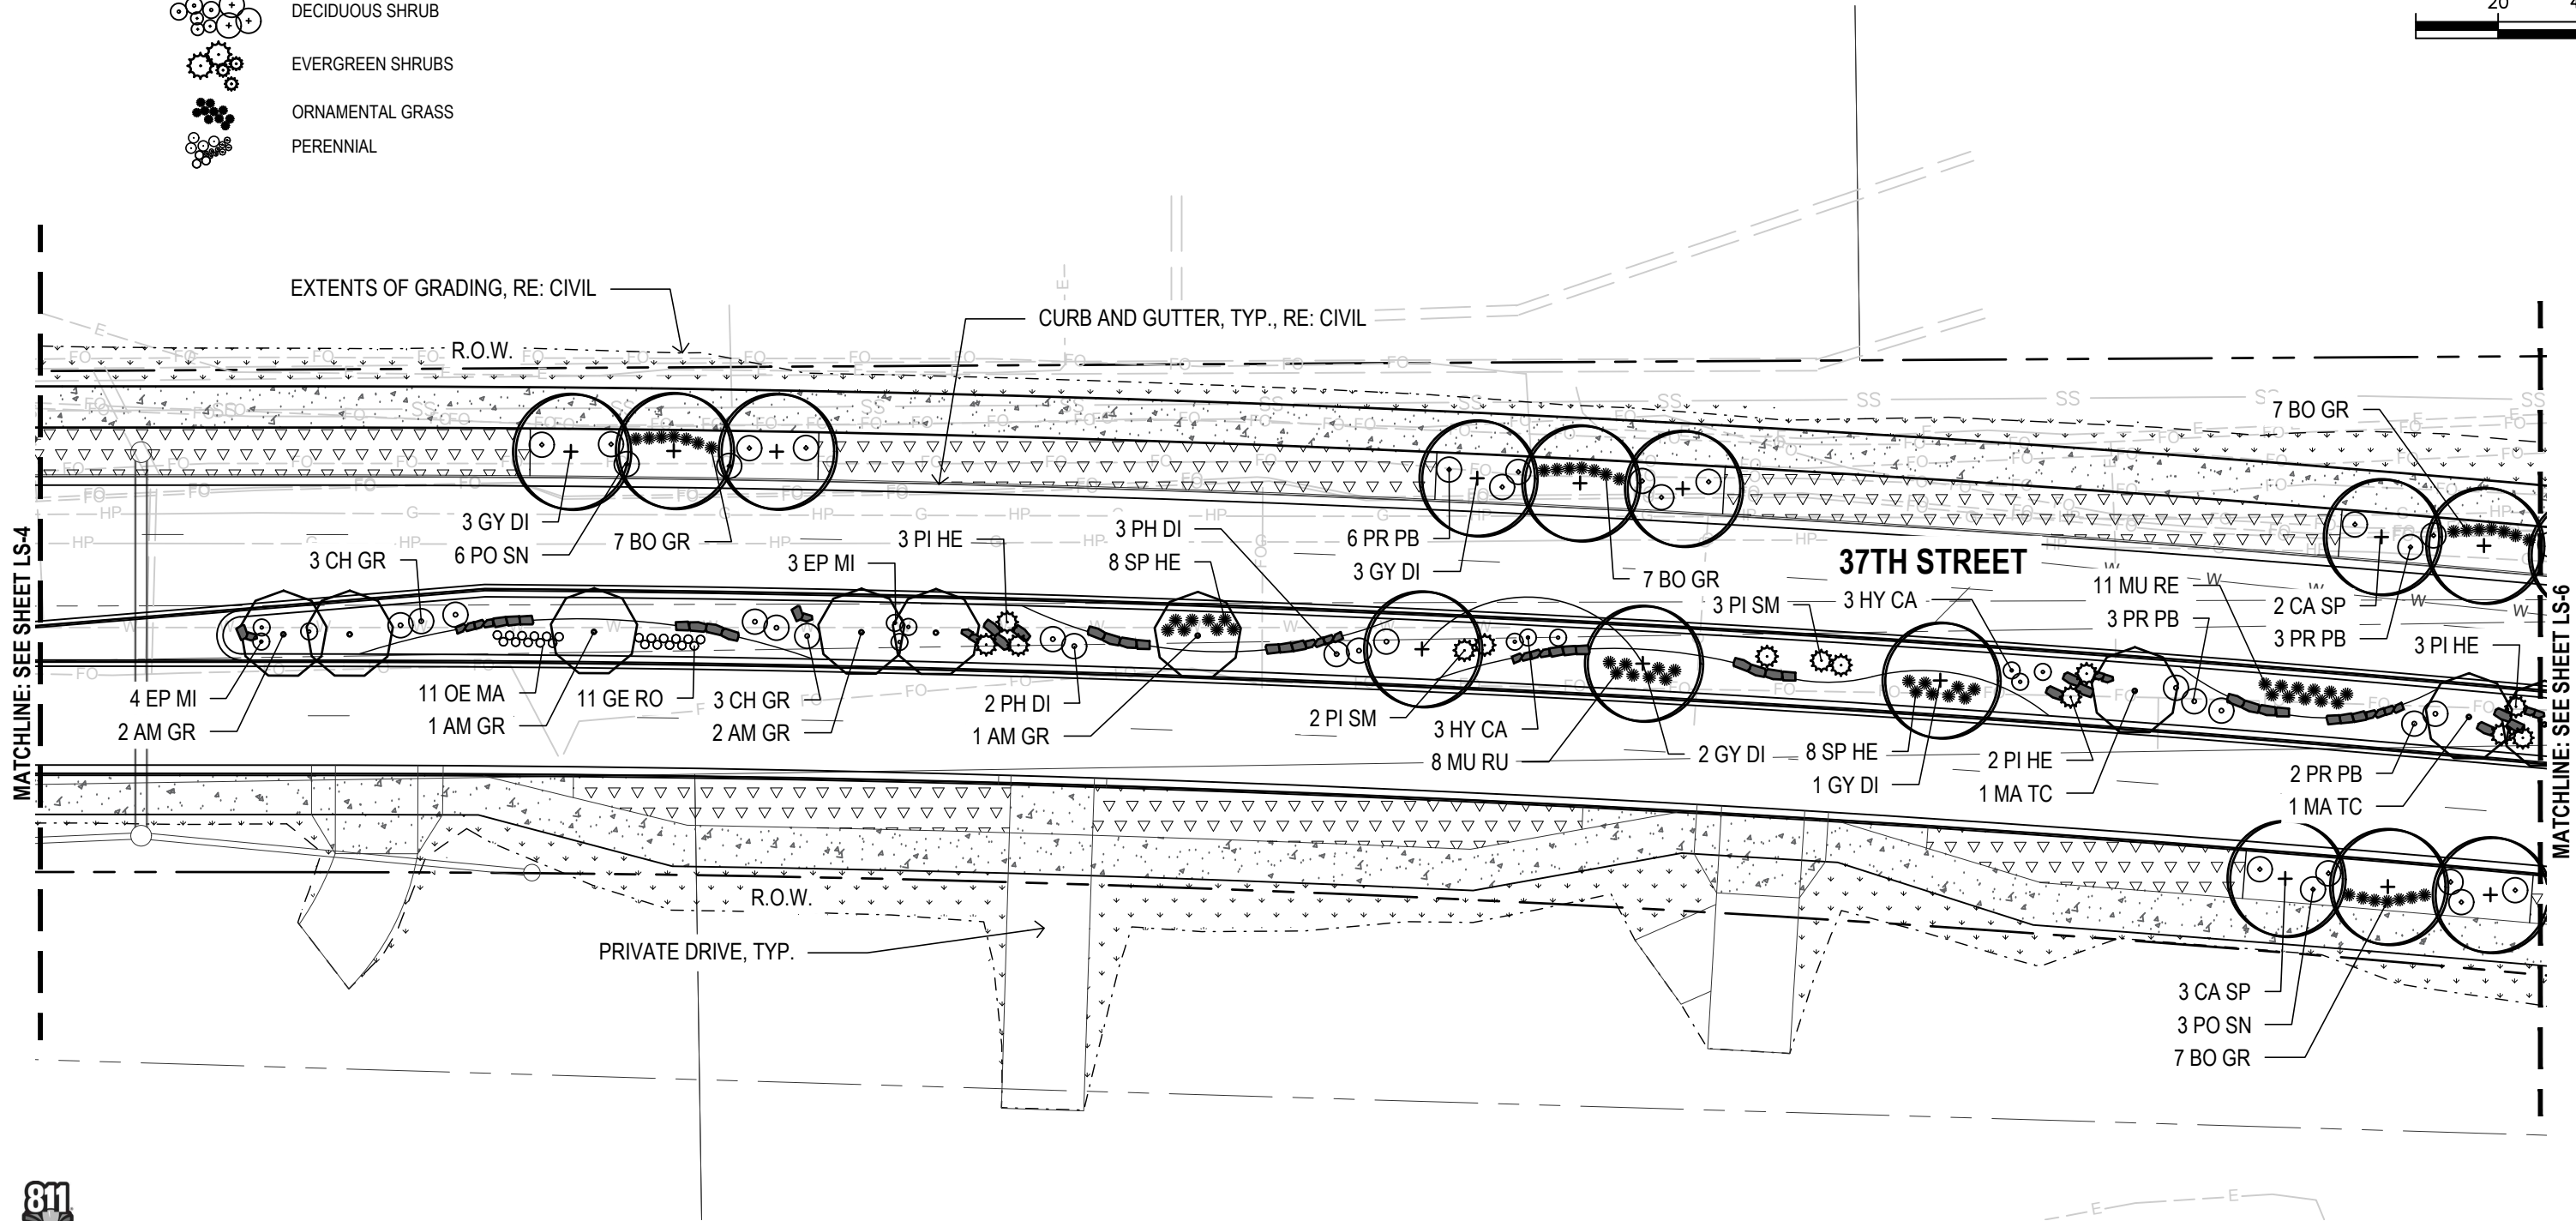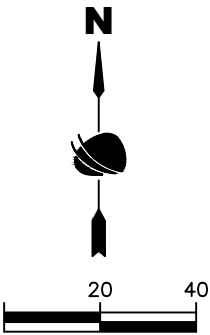

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




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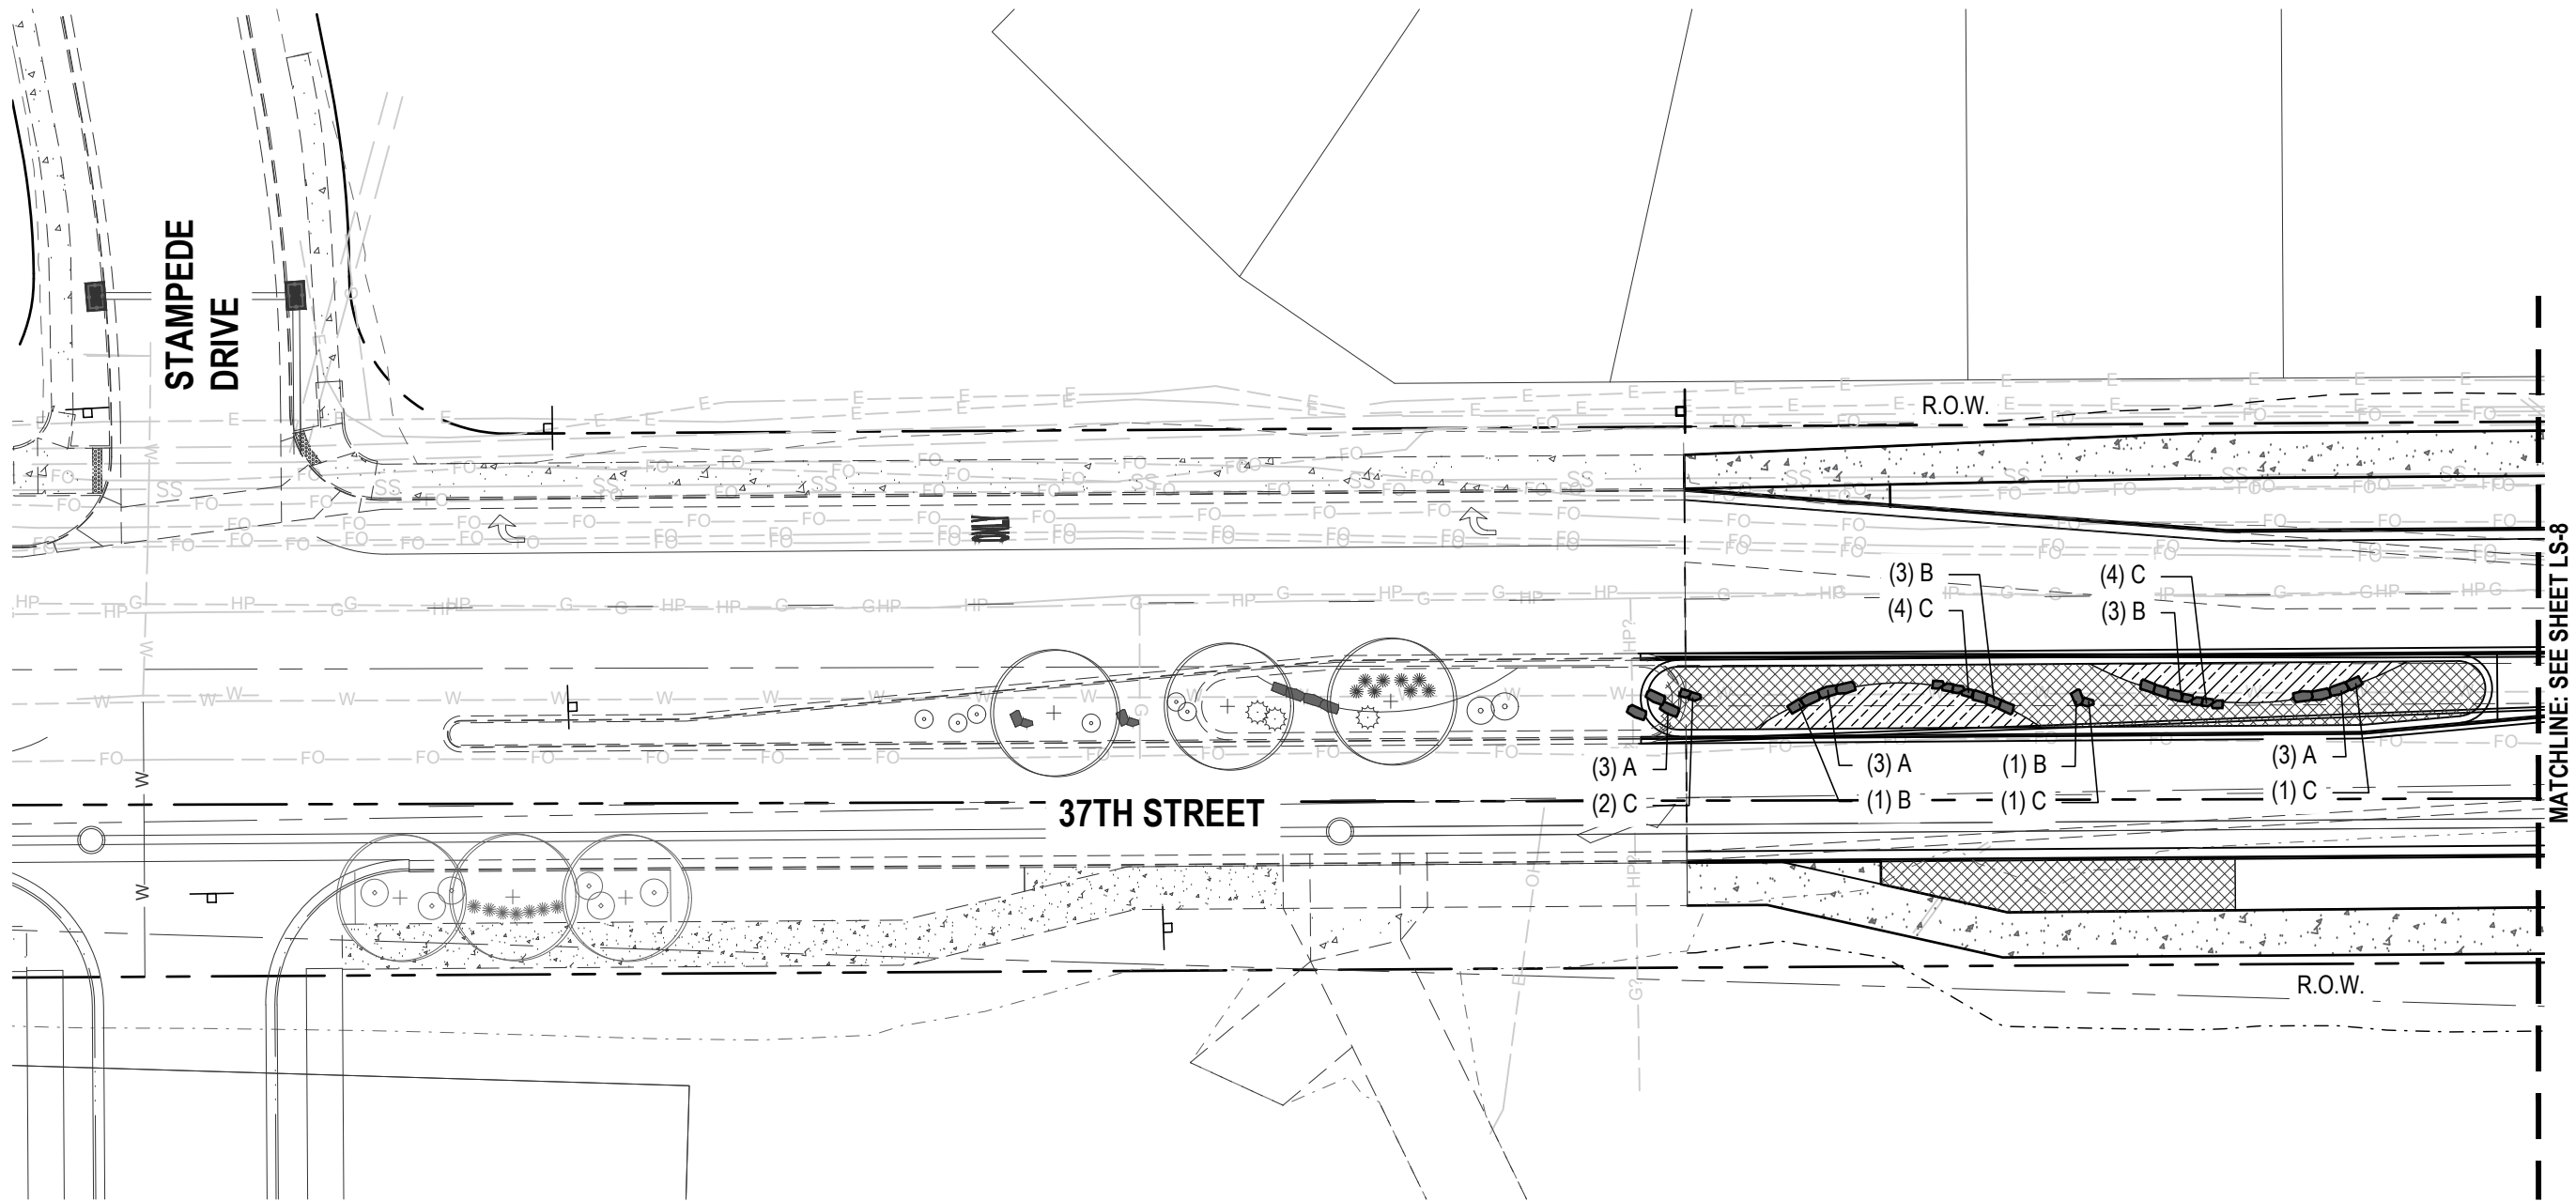
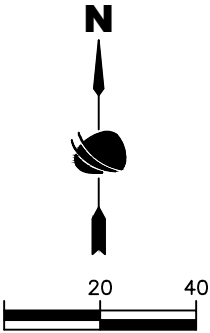
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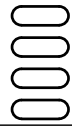
LEGEND

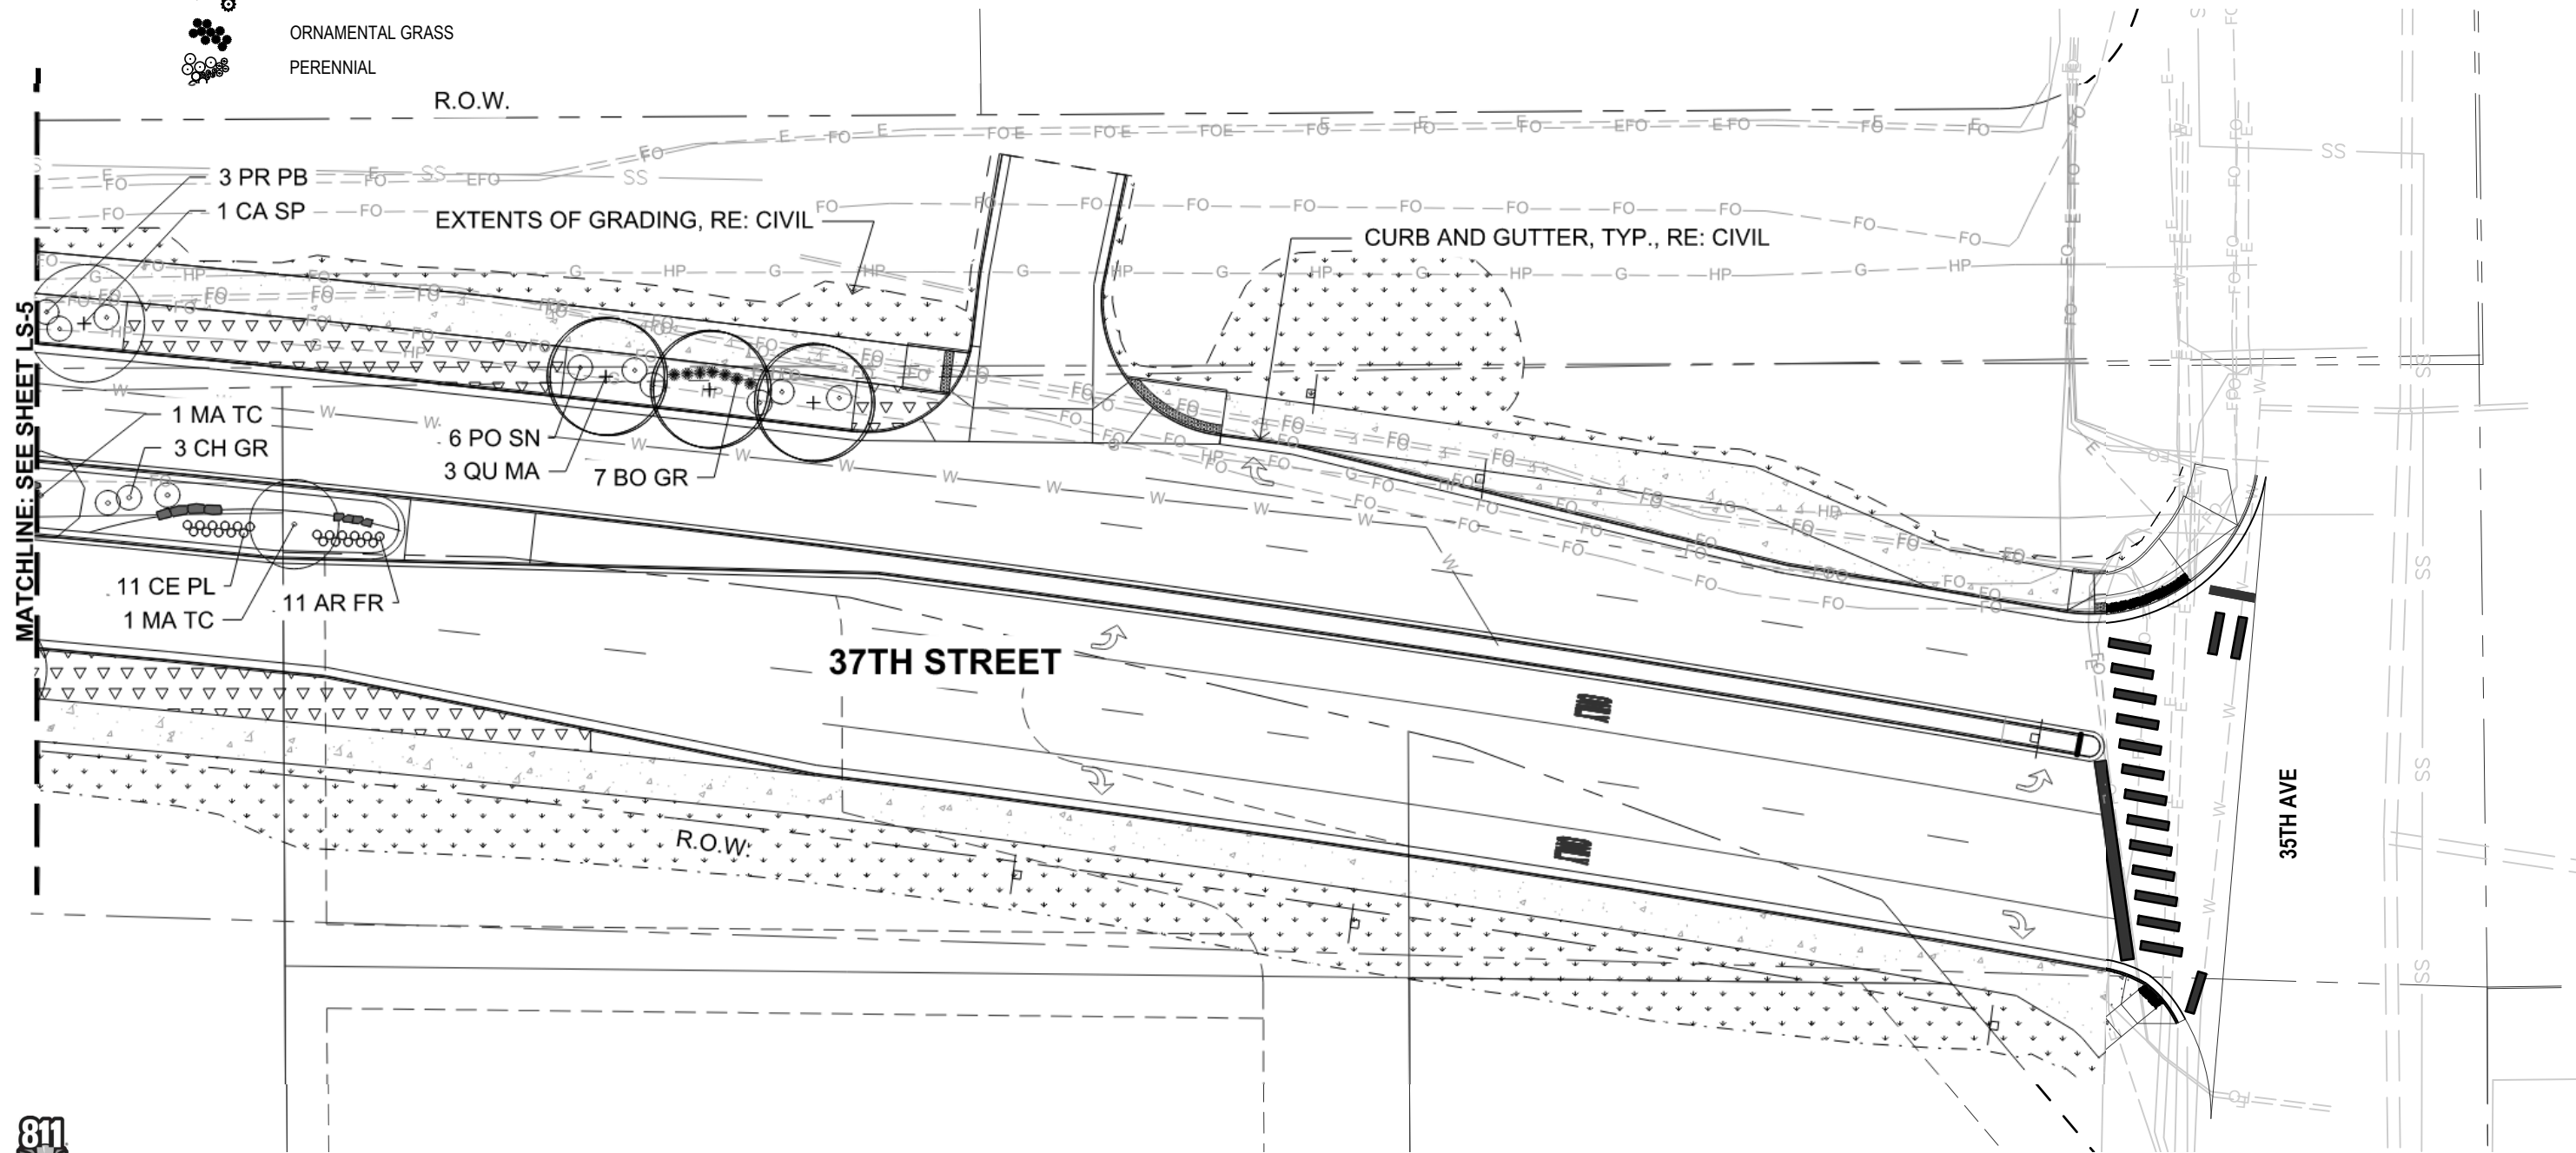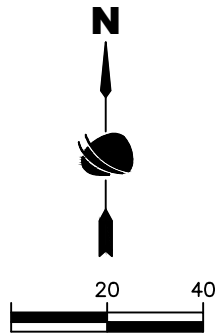-  ORGANIC MULCH
-  INORGANIC MULCH
-  A LANDSCAPE BOULDER A
-  B LANDSCAPE BOULDER B
-  C LANDSCAPE BOULDER C


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GRADING OR CONSTRUCTION BEYOND
THOSE AREAS INDICATED ON THIS PLAN



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File Name: 1914_37TH LANDSCAPE PLANP2B.DWG	
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PRIME CONSULTANT:	SUB CONSULTANT:
 Consulting Group, Inc.	





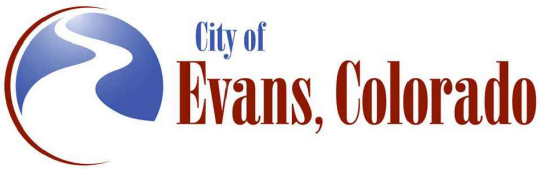


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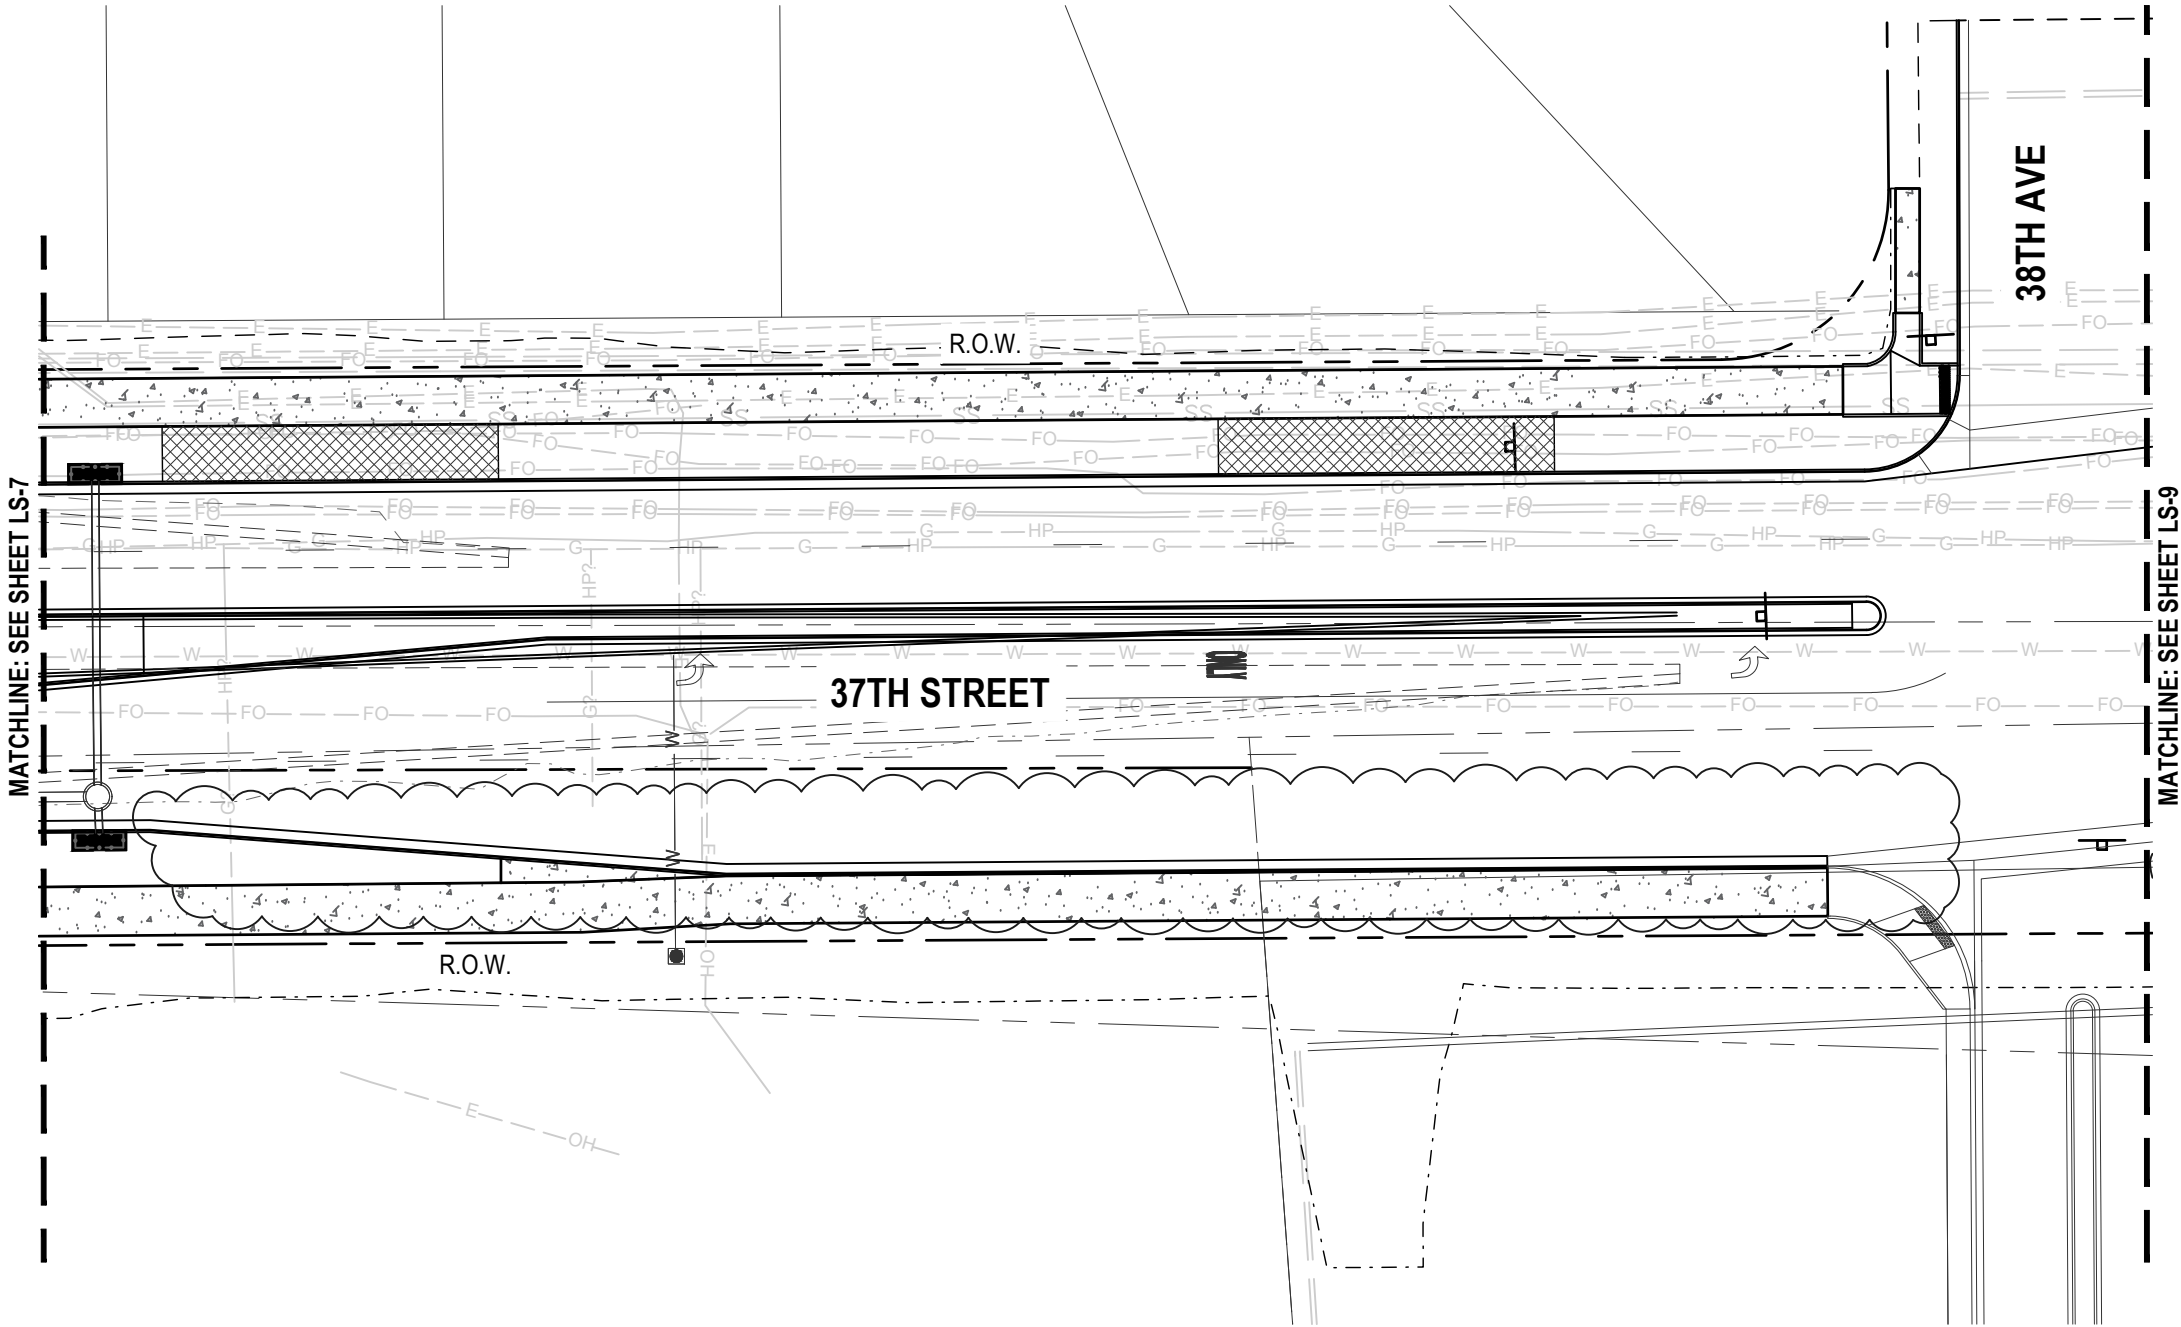
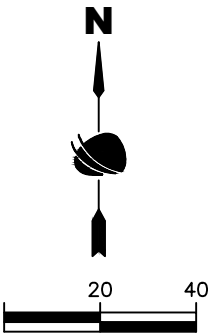
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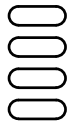
LEGEND

-  ORGANIC MULCH
-  INORGANIC MULCH
-  A LANDSCAPE BOULDER A
-  B LANDSCAPE BOULDER B
-  C LANDSCAPE BOULDER C


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THOSE AREAS INDICATED ON THIS PLAN



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Revised:	Designer:	DE	Structure		Drawing Number LS-8
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LEGEND

ORGANIC MULCH



INORGANIC MULCH

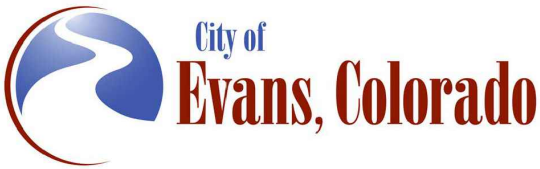A LANDSCAPE BOULDER A

B LANDSCAPE BOULDER B

C LANDSCAPE BOULDER C

NOTES:
CONTRACTOR RESPONSIBLE FOR
RESTORING AREAS AFFECTED BY
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THOSE AREAS INDICATED ON THIS PLAN

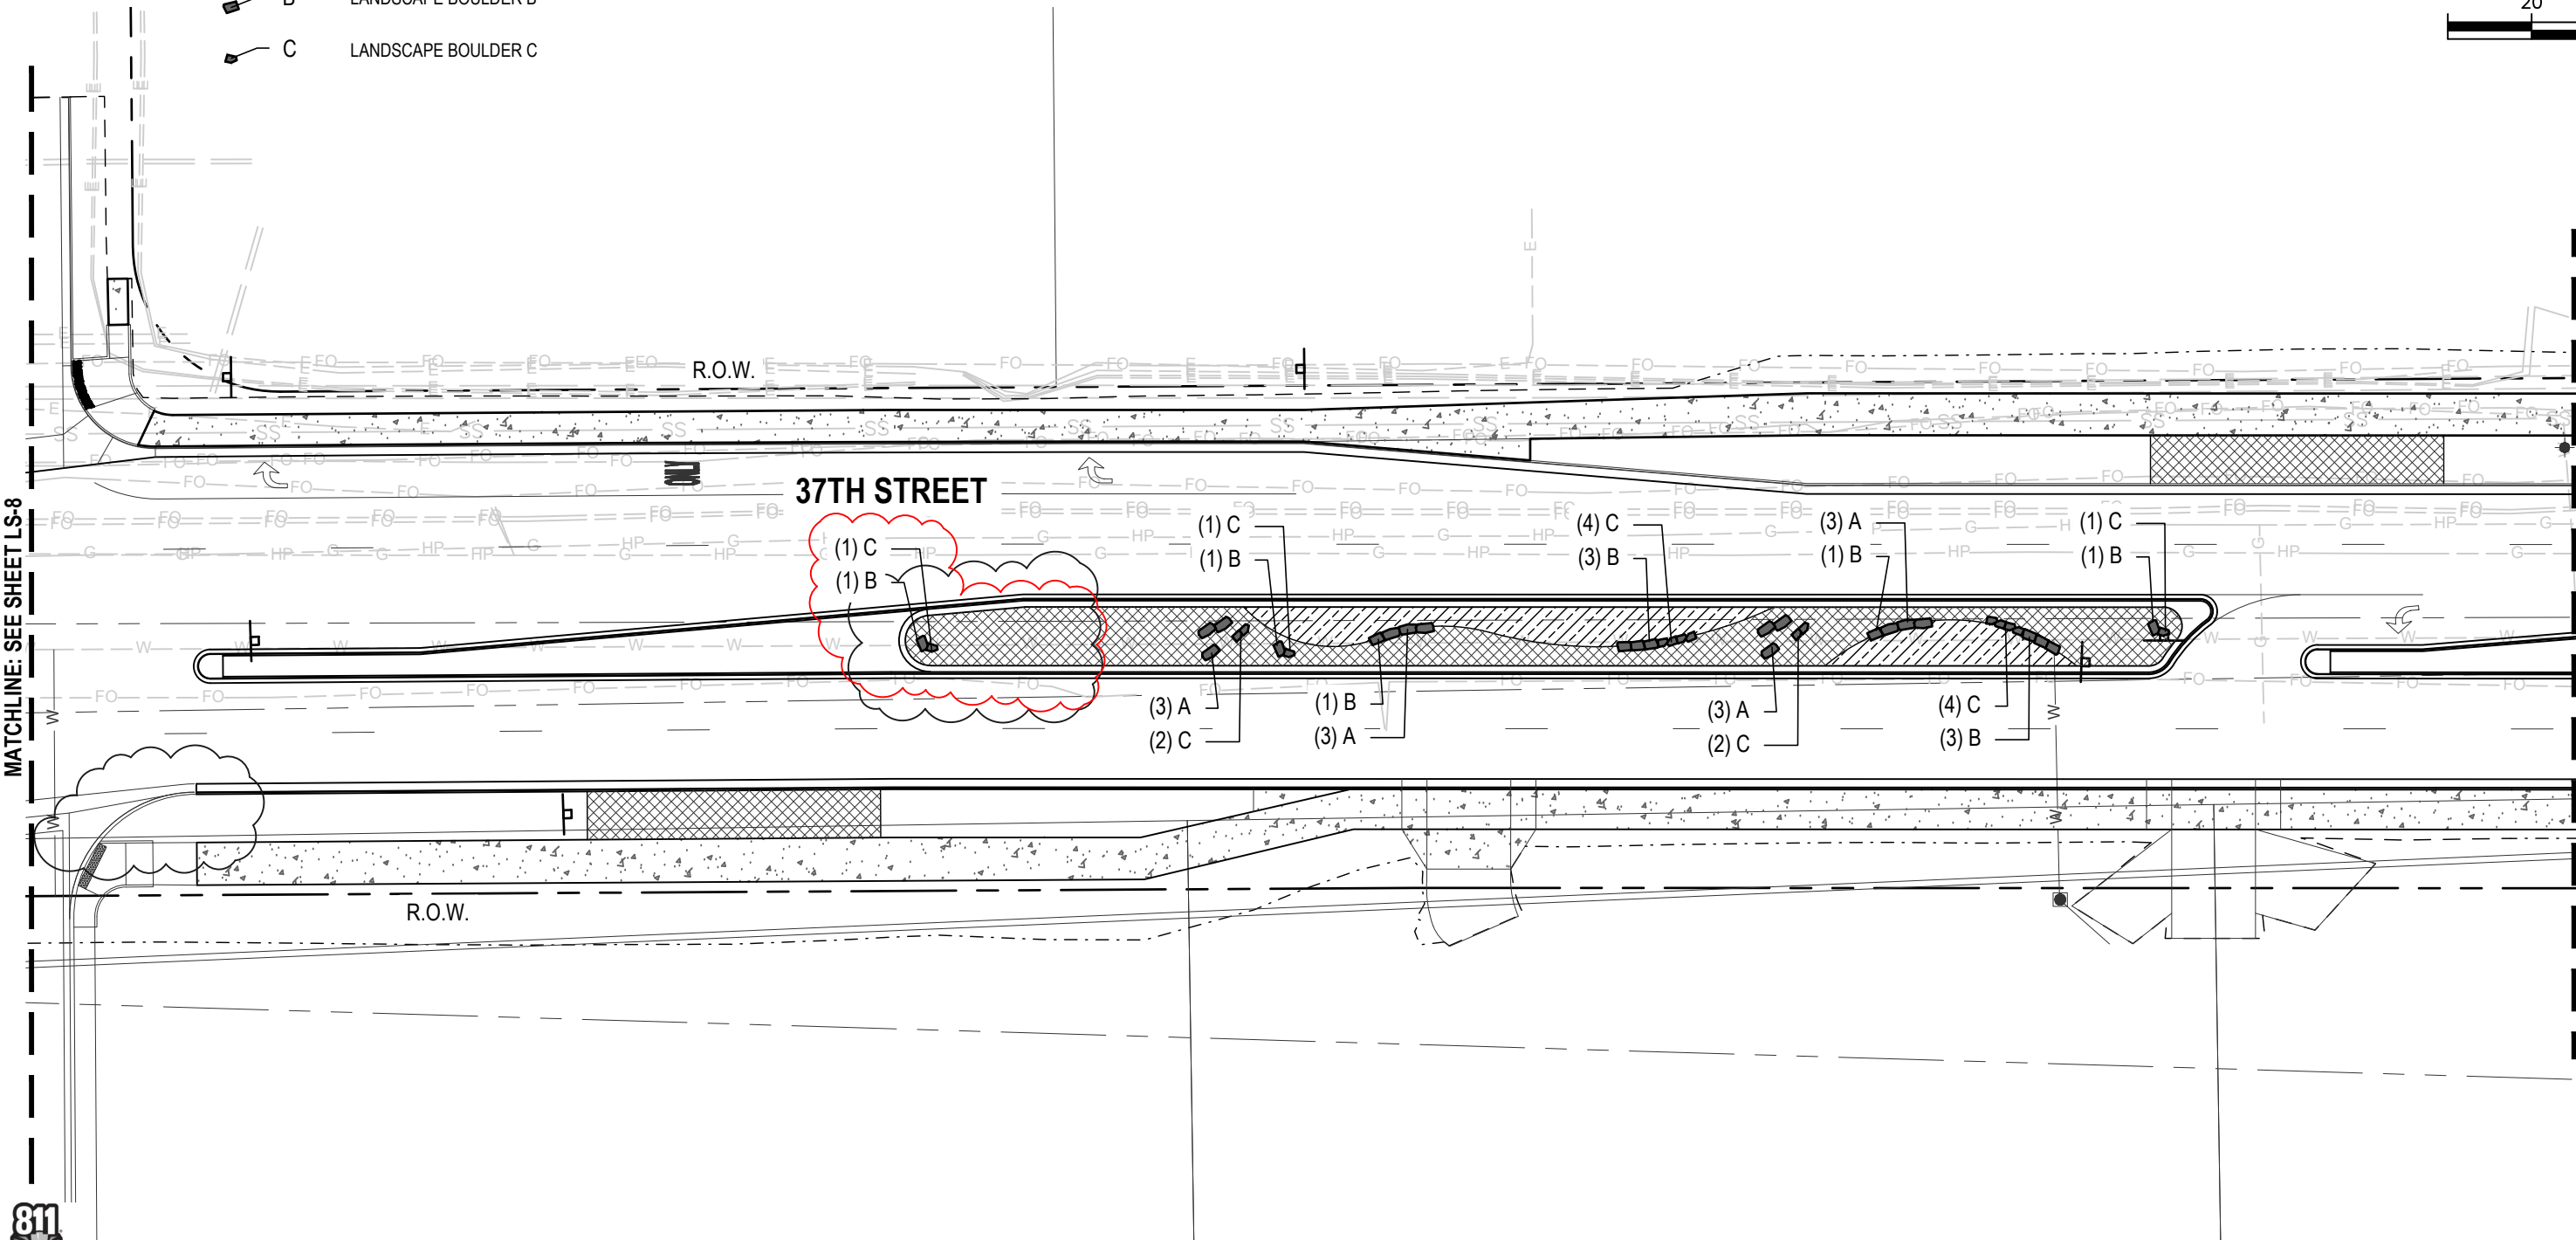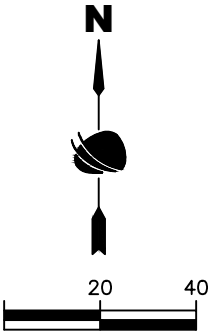

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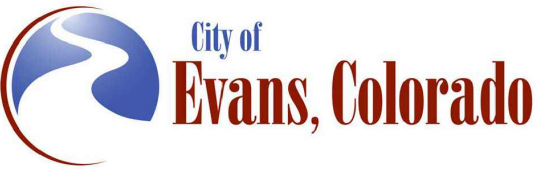
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SUB CONSULTANT:






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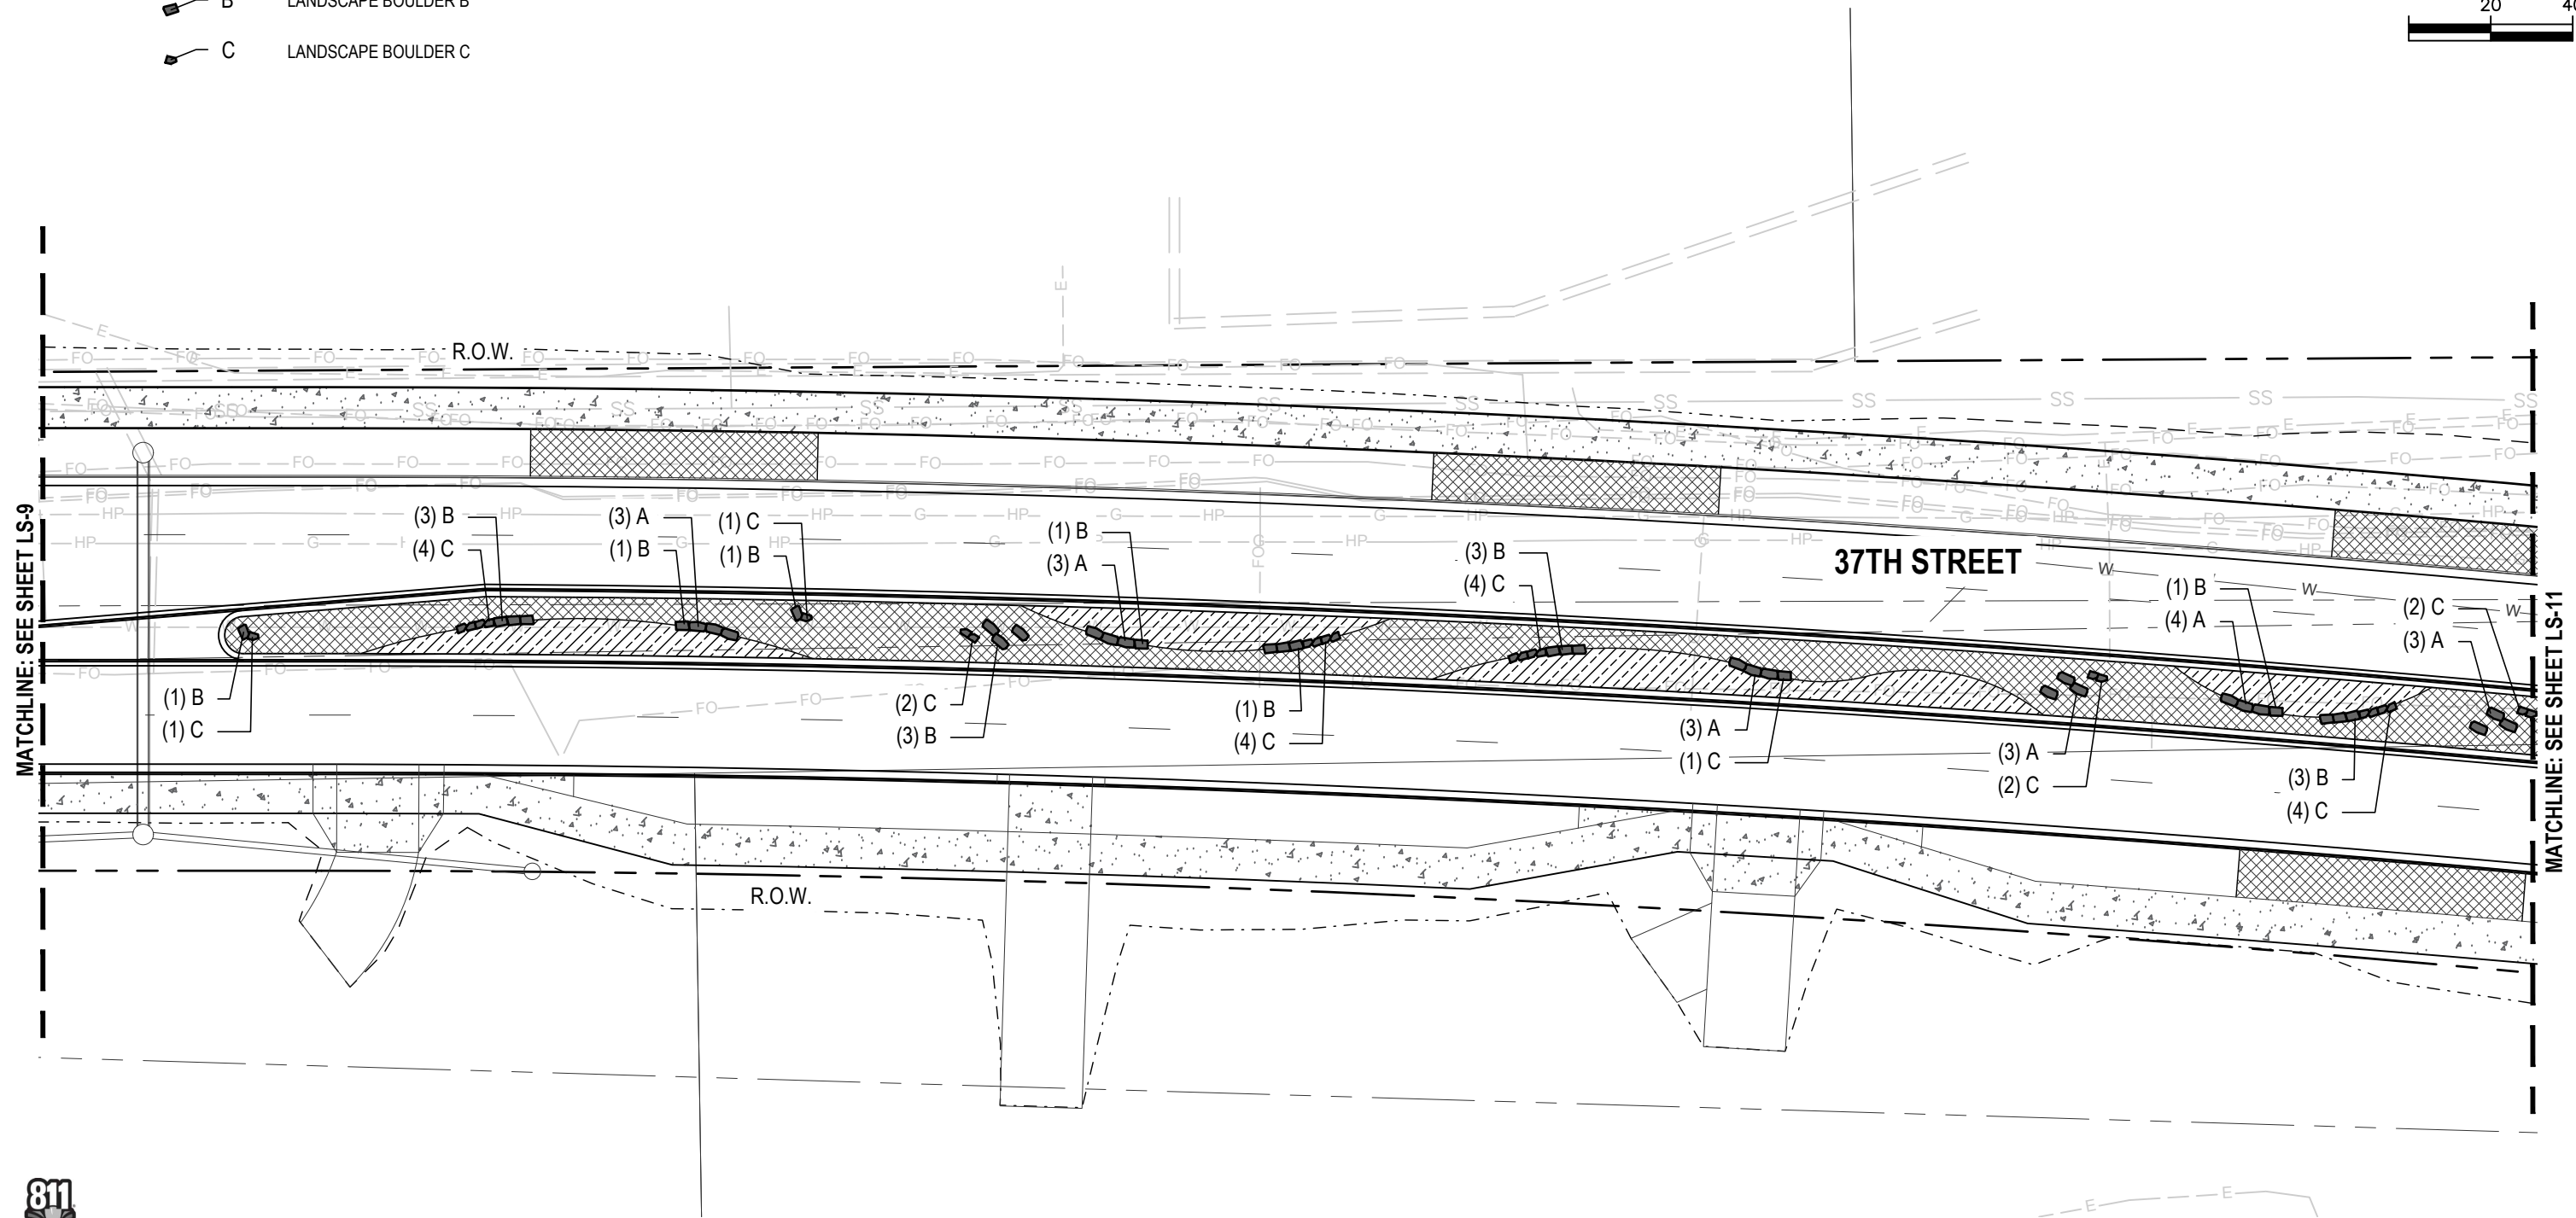
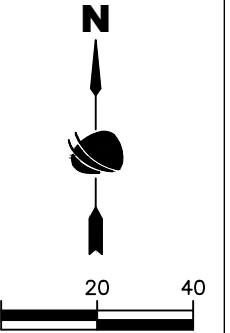


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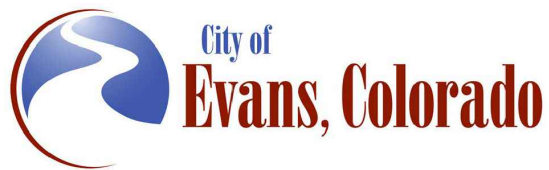
-  ORGANIC MULCH
-  INORGANIC MULCH
-  A LANDSCAPE BOULDER A
-  B LANDSCAPE BOULDER B
-  C LANDSCAPE BOULDER C

NOTES:
CONTRACTOR RESPONSIBLE FOR
RESTORING AREAS AFFECTED BY
GRADING OR CONSTRUCTION BEYOND
THOSE AREAS INDICATED ON THIS PLAN



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Date:	Comments	Init.

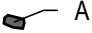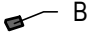



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LEGEND

- ORGANIC MULCH
- INORGANIC MULCH
- A LANDSCAPE BOULDER A
- B LANDSCAPE BOULDER B
- C LANDSCAPE BOULDER C

NOTES:
CONTRACTOR RESPONSIBLE FOR
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MATCHLINE: SEE SHEET LS-10

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Print Date: 12/4/2024

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Horiz. Scale: As Noted Vert. Scale: As Noted

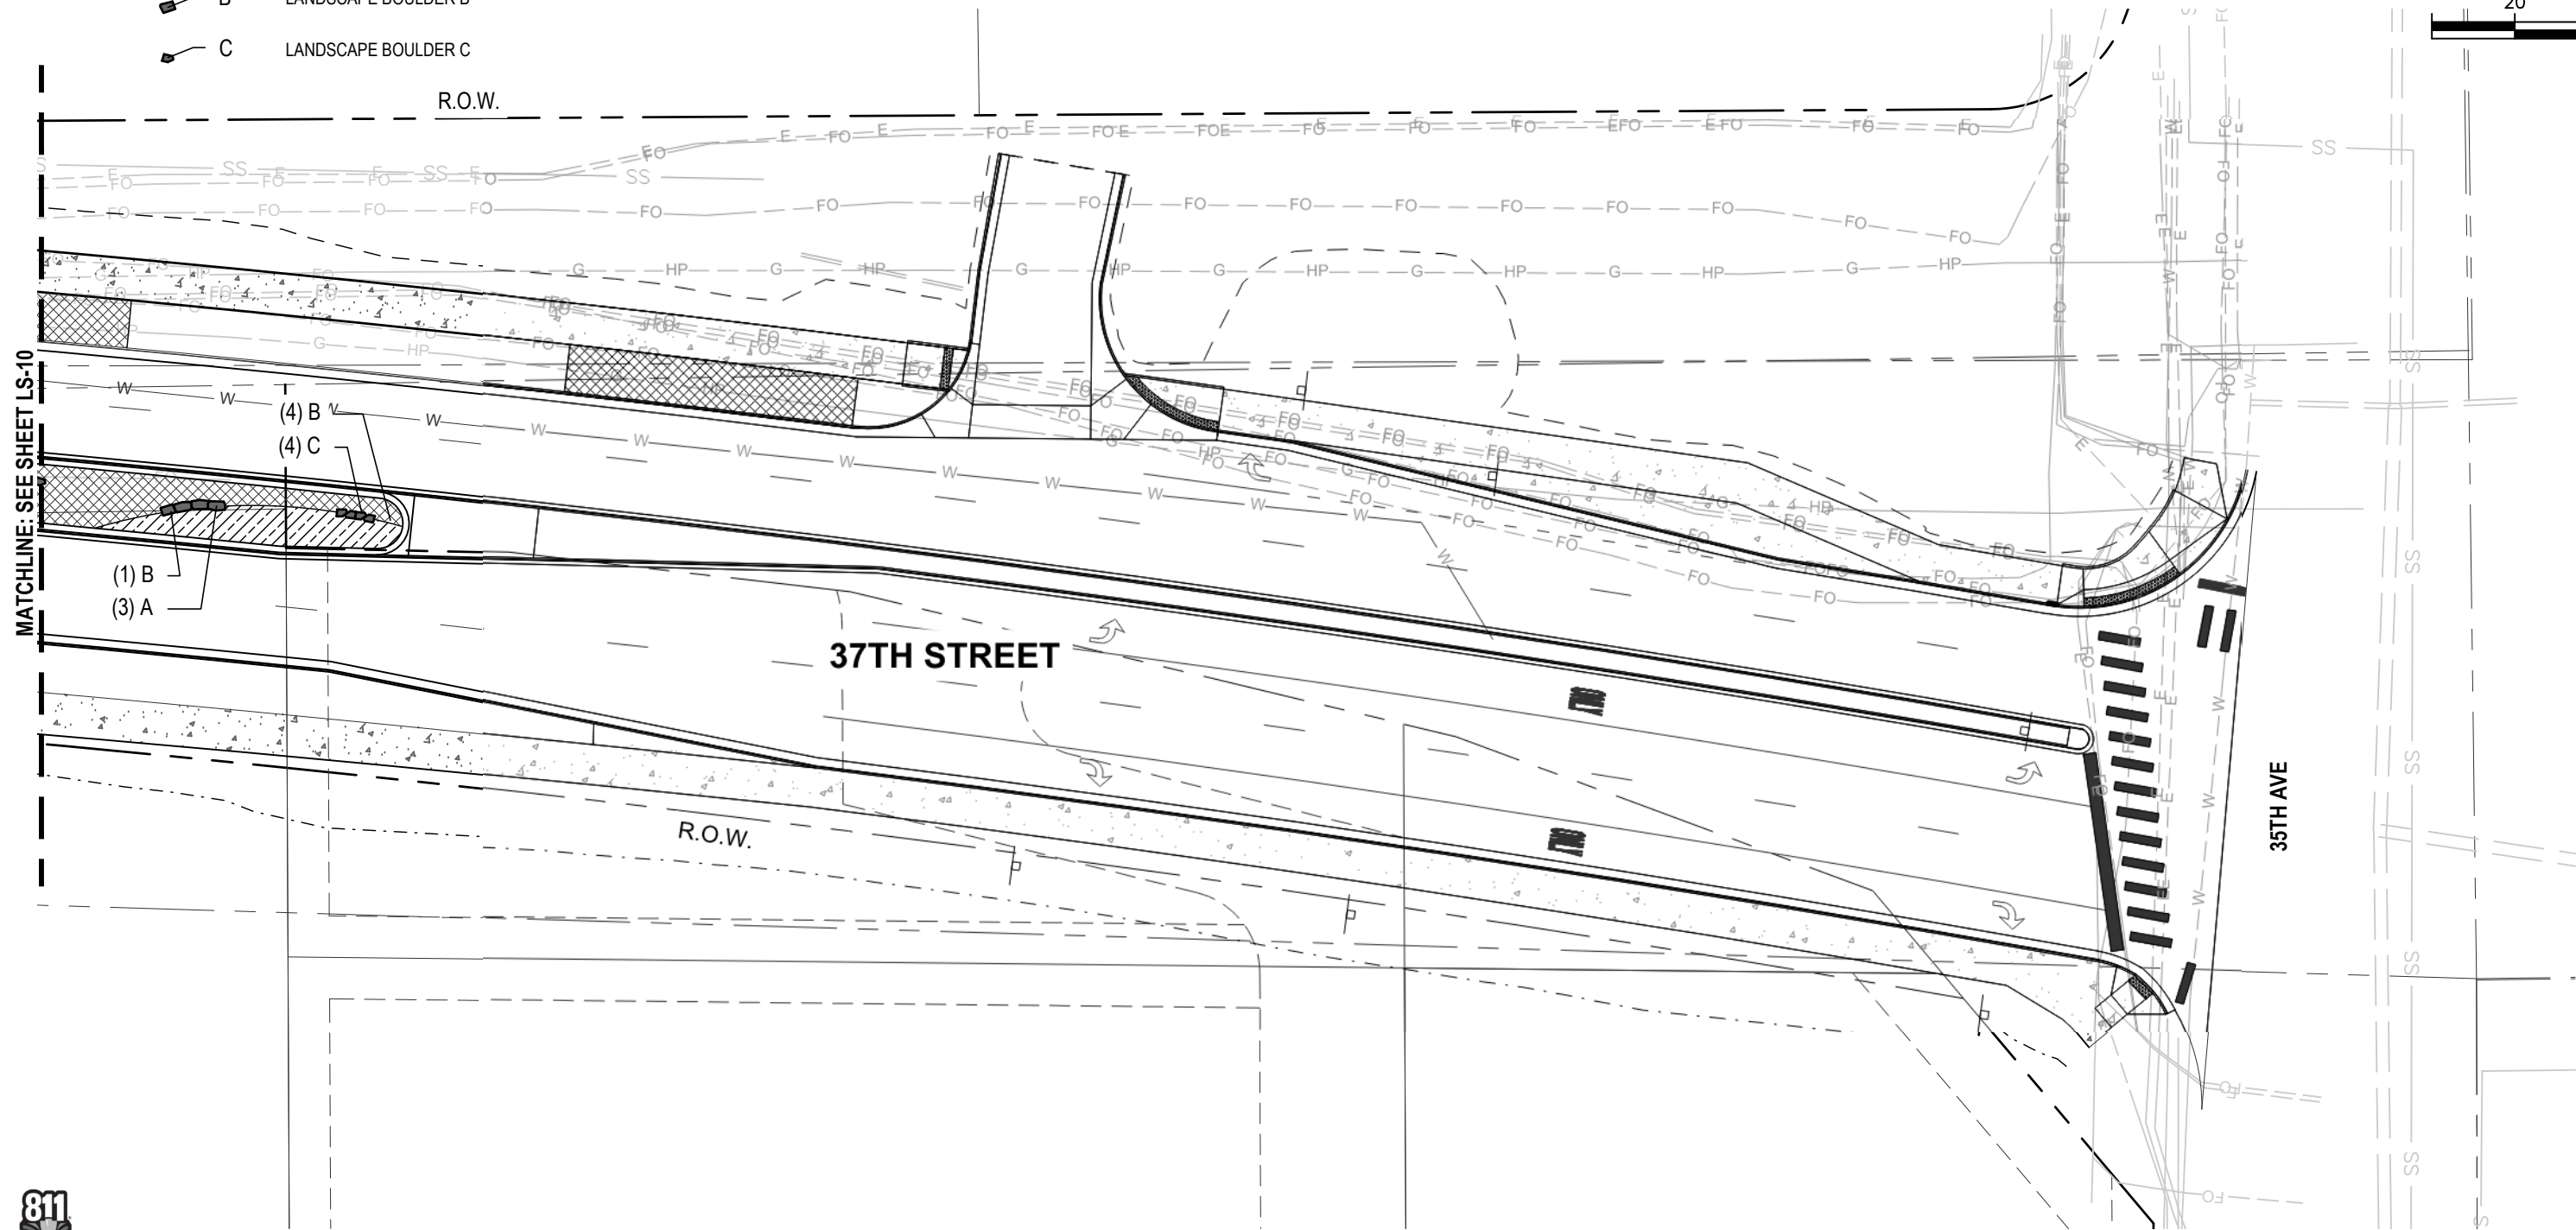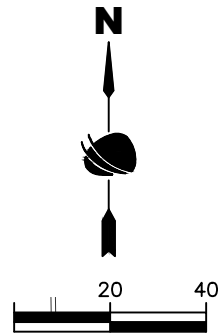PRIME CONSULTANT: Consulting Group, Inc.

SUB CONSULTANT:

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Sheet Revisions		
Date:	Comments	Init.

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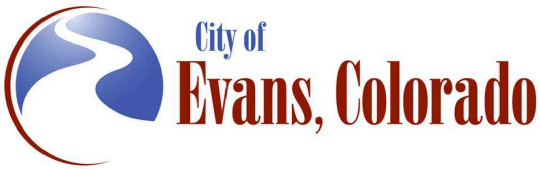
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Sheet Revisions		
Date:	Comments	Init.



As Constructed	37TH STREET WIDENING PHASE 2B PLANT LIST			Project No.
No Revisions:				AQC M415-021
Revised:	Designer: DE	Structure		Drawing Number LS-12
Void:	Detailer: DE	Numbers		Sheet Number 92
	Sheet Subset: LANDSCAPE	Subset Sheets:12	of 17	

PLANT LIST

KEY	BOTANICAL NAME	COMMON NAME	SIZE AT PLANTING	ROOT	QTY	FLOWER COLOR	FLOWER SEASON	SIZE AT MATURITY
SHADE TREES								
CA SP	Catalpa speciosa	Western Catalpa	2" Cal.	B&B	6	White	Summer	50-60't., 30-40' w.
CE OC	Celtis Occidentalis	Hackberry	2" Cal.	B&B	11	N/A	N/A	50-60't., 30-40' w
GY DI	Gymnocladus dioicus 'Espresso'	Espresso Kentucky Coffeetree	2" Cal.	B&B	12	N/A	N/A	50-60't., 35-45' w
QU MU	Quercus muehlenbergia	Chinkapin Oak	2" Cal.	B&B	3	NA	NA	50-60't., 35-45' w.
QU MA	Quercus macrocarpa	Bur Oak	2" Cal.	B&B	3	NA	NA	50-60't., 35-45' w.
ORNAMENTAL TREES								
AM GR	Amelanchier x grandiflora 'Autumn Brilliance'	Autumn Brilliance Serviceberry	1.5" Cal.	B&B	10	White	Spring	15-20't., 15-20' w.
MA TC	Malus 'Thunderchild'	Thunderchild Crabapple	1.5" Cal.	B&B	4	Pink	Spring	15-20't., 15-20' w.
SY RE	Syringa reticulata 'Ivory Silk'	Ivory Silk Japanese Tree Lilac	1.5" Cal.	B&B	4	White	Spring	15-20't., 15-20' w.
DECIDUOUS SHRUBS								
CH NA	Chrysothamnus nauseosus nauseosus	Dwarf Baby Blue Rabbitbrush	5 Gal.	Cont.	11	Yellow	Late Summer	1-2' t., 2-4' w.
CH GR	Chrysothamnus nauseosus graveolens	Tall Green Rabbitbrush	5 Gal.	Cont.	9	Yellow	Late Summer	4-6' t., 4-6' w.
EP MI	Ephedra minima	Dwarf Joint Fir	5 Gal.	Cont.	7	Red Berries	Summer	2-4" t., 2-3' w.
HY CA	Hypericum calycinum	Creeping St. John's Wort	5 Gal.	Cont.	6	Yellow	Spring/Simmer	1-2' t., 2-4' w.
PH DI	Physocarpus opulifolius Diabolo	Diabolo Ninebark	5 Gal.	Cont.	8	White	Summer	8' t., 8' w.
PH LD	Physocarpus opulifolius Little Devil	Little Devil Ninebark	5 Gal.	Cont.	3	White/pink	Summer	4' t., 4' w.
PO SN	Potentilla frutiucosa 'Davurica'	Prairie Snow Potentilla	5 Gal.	Cont.	27	White	Summer	1-2' t., 3-6' w.
PR PB	Prunus besseyi 'Pawnee Buttes'	Creeping Western Sandcherry	5 Gal.	Cont.	46	White	Spring	1-2' t., 6' w.
EVERGREEN SHRUBS								
PI SM	Picea pungens 'St. Mary's Broom'	St. Mary's Blue Spruce	5 Gal.	Cont.	14	-	-	18-24" t., 3-4' w.
PI HE	Pinus nigra 'Helga'	Dwarf Austrian Pine	5 Gal.	Cont.	13	-	-	4-6' t., 4-6' w.
ORNAMENTAL GRASSES								
BO GR	Bouteloua gracilis 'Blonde Ambition'	Blonde Ambition Grama Grass	1 Gal.	Cont.	70	Blonde	Summer-Fall	3' t., 2' w.
MU RE	Muhlenbergia reverchonii 'Ruby Muhly'	Undaunted Ruby Muhly Grass	1 Gal.	Cont.	30	Ruby	Late Summer	15-30" t., 18-24" w.
SP HE	Sporobolis heterolepis	Prairie Dropseed	1 Gal.	Cont.	24	Golden Orange Fall		18-24" t. 15-20" w.
PERENNIALS, GROUNDCOVERS								
AR FR	Artemisia frigida	Fringed Sage	1 Gal.	Cont.	22	Yellow	Late Summer	12" t., 24" w.
CE PL	Ceratostigma plumbaginoides	Plumbago	4" Pot	Cont.	11	Blue	Mid-Late Summer	12" t., 24" w.
GE RO	Geranium 'Gerwat' rozanne	Blue Cranesbill	1 Gal.	Cont.	11	Blue/Purple	Spring-Fall	18-20" t., 36" w.
OE MA	Oenothera macrocarpa	Missouri Evening Primrose	1 Gal.	Cont.	22	Lemon Yellow	Mid-Summer	12" t., 24" w.
ZA GA	Zauschneria garrettii 'PWWG01S'	Org. Carpet Hummingbird Mint	1 Gal.	Cont.	11	Orange	Summer-Fall	8" t., 18" w.

LANDSCAPE NOTES

1. REFERENCE THE SWMP DRAWINGS FOR ADDITIONAL INFORMATION ON SOIL PREPARATION, FERTILIZER, COMPOST, SEEDING, AND MULCHING, AS WELL AS CITY OF EVAN'S STANDARDS.
2. AREAS DISTURBED BY CONSTRUCTION OUTSIDE LIMIT OF WORK LINE SHALL BE REGRADED AND SEEDED WITH TYPE 2 SEED. AREAS CALLED OUT AS TYPE 2 SEED SHALL BE SEEDED WITH TYPE 2 SEED (BELOW).

TYPE 2 SEED SHORT GRASS MIX: (SEED MUST BE APPLIED WITH DRILL SEEDER @ RATE OF 11+ LBS. PLS, PER ACRE. IF BROADCAST, APPROVED BY THE CITY OF EVANS ONLY, APPLY @ A RATE OF 22+ LBS. PLS, PER ACRE.)

(10%) SAND DROPSEED

(27%) BLUE GRAMMA

(26%) LITTLE BLUESTEM

(27%) SIDEOATS GRAMA

(10%) SAND LOVEGRASS

3. DECIDUOUS TREES SHALL BE SINGLE-STEM TREES WITH STRAIGHT TRUNK, WELL BALANCED CROWN, AND INTACT LEADER, OF HEIGHT AND CALIPER INDICATED IN PLANT LIST, COMPLYING WITH ANSI Z60.1 FOR TYPE OF TREES REQUIRED. TREES SHALL BE BALLED AND BURLAPPED WITH BRANCHING HEIGHT ONE-THIRD TO ONE-HALF OF TREE HEIGHT.
4. ORNAMENTAL DECIDUOUS TREES SHALL BE BRANCHED OR PRUNED NATURALLY ACCORDING TO SPECIES AND TYPE, OF CALIPER AND HEIGHT INDICATED IN PLANT LIST, AND BRANCHING ACCORDING TO ANSI Z60.1. STEM FORM SHALL BE SINGLE TRUNK AND ALL TREES SHALL BE BALLED AND BURLAPPED.
5. GRADE PLANTING BEDS TO A SMOOTH, UNIFORM SURFACE PLANE WITH LOOSE, UNIFORMLY FINE TEXTURE. ROLL AND RAKE, REMOVE RIDGES, AND FILL DEPRESSIONS TO MEET FINISHED GRADES.
6. **MEDIAN AREAS**
- 6.1. PLANTING AREAS (SHRUBS, PERENNIALS, ORNAMENTAL GRASSES) SHALL BE AMENDED WITH CITY OF EVANS APPROVED COMPOST AT A RATE OF 4 CUBIC YARDS PER 1,000 S.F. SOIL AMENDMENT SHALL BE INCORPORATED EVENLY INTO THE TOP 6 INCHES OF SOIL.
- 6.2. MEDIAN AREAS SHALL BE MULCHED WITH 4 INCH DEEP SHREDDED CEDAR MULCH AND ROCK MULCH REFERENCE MULCH AND BOULDER PLANS FOR LOCATIONS.

7. **INSPECTIONS**

- 7.A. SITE INSPECTION
- 7.A.1. CONTRACTOR WILL INSPECT EXISTING SITE CONDITIONS AND NOTE IRREGULARITIES AFFECTING THE WORK OF THIS SECTION. VERIFY THAT GRADING OPERATIONS HAVE BEEN SATISFACTORILY COMPLETED AND THAT TOPSOIL OF ADEQUATE QUANTITY AND QUALITY HAS BEEN PLACED IN AREAS AS SPECIFIED. VERIFY THAT THE AREAS TO BE REVEGETATED ARE PROTECTED FROM CONCENTRATED RUNOFF AND SEDIMENT FROM ADJACENT AREAS. NOTE PREVIOUS TREATMENTS TO THE AREAS SUCH AS TEMPORARY TYPE 2 SEED OR MULCHING AND DISCUSS WITH THE CITY OF EVANS OR ENGINEER HOW THESE TREATMENTS WILL AFFECT PERMANENT REVEGETATION. REPORT IRREGULARITIES AFFECTING WORK OF THIS SECTION TO THE CITY OF EVANS OR ENGINEER BEFORE INITIATING WORK. WHEN THE CONTRACTOR BEGINS WORK UNDER THIS SECTION, IT IMPLIES ACCEPTANCE OF EXISTING CONDITIONS.
- 7.A.2. CONTRACTOR SHALL NOTIFY THE CITY OF EVANS OR ENGINEER PRIOR TO START OF WORK. THE CITY OF EVANS OR ENGINEER WILL BE RESPONSIBLE TO MONITOR THE WORK.
- 7.B. PRE-PLANTING INSPECTIONS:
- 7.B.1. PLANT MATERIAL SHALL BE INSPECTED BY THE CITY OF EVANS OR ENGINEER, BEFORE PLANTING. INSPECTION OF MATERIALS MAY BE SEQUENCED BY MAJOR PLANTING AREAS TO ACCOMMODATE EFFICIENT PLANTING OPERATIONS. PLANTS FOR INSPECTION MUST BE IN A SINGLE LOCATION PREFERABLY ON THE PROJECT SITE. REJECTED MATERIALS MUST BE REMOVED FROM THE SITE, REPLACED AND REINSPECTED BEFORE PLANTING. IF THE SUPPLIER IS A LOCAL NURSERY, TAGGED PLANTS MAY BE INSPECTED AT THE NURSERY. PHOTOGRAPHS OF THE PLANT MATERIALS TO BE OBTAINED FROM NON-LOCAL SOURCES MAY BE SUBMITTED TO THE CITY OF EVANS OR ENGINEER FOR PRELIMINARY INSPECTION. THIS PRELIMINARY INSPECTION IS SUBJECT TO FINAL APPROVAL OF PLANTS AT THE JOB SITE. THE OWNER RESERVES THE RIGHT TO REJECT PLANT MATERIAL AT ANY STAGE OF CONSTRUCTION OR WARRANTY PERIOD.
- 7.C. TYPE 1 SEED SHALL CONSIST OF THE FOLLOWING:

- 60% BUFFALO GRASS
- 40% BLUE GRAMMA GRASS

8. SOIL AMENDMENTS, BACKFILL MIXES AND MULCHES WILL BE INSPECTED AT THE SITE BY THE THE CITY OF EVANS OR ENGINEER BEFORE THEY ARE USED IN PLANTING OPERATIONS.
9. OBTAIN THE CITY OF EVANS OR ENGINEER'S REVIEW OF STAKED LOCATIONS OF TREES BEFORE DIGGING FOR THOSE PLANTS OCCURS. OBTAIN THE CITY OF EVANS OR ENGINEER'S REVIEW OF THE LOCATION OF SHRUBS IN THEIR CONTAINERS AT THE PROPOSED LOCATIONS BEFORE DIGGING COMMENCES. CONTACT THE CITY OF EVANS OR ENGINEER AT LEAST TWO DAYS IN ADVANCE.
10. **SUBSTANTIAL COMPLETION INSPECTION:**
- 10.A. AS SOON AS PLANTING IS COMPLETED, A REVIEW AND PRELIMINARY INSPECTION TO DETERMINE THE CONDITION OF THE VEGETATION WILL BE HELD BY THE CITY OF EVANS OR ENGINEER UPON REQUEST BY THE CONTRACTOR.
- 10.B. THE INSPECTION WILL OCCUR ONLY AFTER THE FOLLOWING CONDITIONS HAVE BEEN MET:
- 10.B.1. LANDSCAPE AREAS WILL BE FREE OF WEEDS AND NEATLY CULTIVATED;
- 10.B.2. PLANT BASINS SHALL BE IN GOOD REPAIR;
- 10.B.3. IRRIGATION SYSTEMS SHALL BE FULLY OPERATIONAL WITH HEADS PROPERLY ADJUSTED;
- 10.B.4. DEBRIS AND LITTER SHALL BE CLEANED UP AND WALKWAYS AND CURBS SHALL BE CLEANED OF SOIL AND DEBRIS LEFT FROM PLANTING OPERATIONS.
11. IF, AFTER THE INSPECTION, THE CITY OF EVANS OR ENGINEER IS OF THE OPINION THAT THE WORK HAS BEEN PERFORMED AS PER THE CONTRACT DOCUMENTS, AND THAT THE VEGETATION IS IN SATISFACTORY GROWING CONDITION, HE WILL GIVE THE CONTRACTOR WRITTEN NOTICE OF ACCEPTANCE AND THE WARRANTY PERIOD SHALL BEGIN.
12. WORK REQUIRING CORRECTIVE ACTION IN THE JUDGMENT OF THE CITY OF EVANS OR ENGINEER SHALL BE PERFORMED WITHIN THE FIRST TEN (10) DAYS OF THE WARRANTY PERIOD. WORK NOT PERFORMED WITHIN THIS TIME WILL REQUIRE AN EQUIVALENT EXTENSION OF THE WARRANTY PERIOD. CORRECTIVE WORK AND MATERIALS REPLACEMENT SHALL BE IN ACCORDANCE WITH THE CONTRACT DOCUMENTS, AND SHALL BE MADE BY THE CONTRACTOR AT NO COST TO THE OWNER.
13. ON OCCASION COLD WEATHER MAY PRECLUDE THE OPPORTUNITY TO REPLACE DEAD PLANTS, OR THE CONTRACTOR MAY REQUEST REPLACEMENT TO BE DELAYED TO THE FOLLOWING SPRING. THE CITY OF EVANS OR ENGINEER MAY GRANT THIS EXTENSION. IN THE EVENT AN EXTENSION IS GRANTED, THE REPLACEMENT PLANTS SHALL BE INSTALLED NO LATER THAN MAY 15TH, AND THE WARRANTY SHALL BE EXTENDED TO NOVEMBER 15TH OF THE SAME YEAR (ONE GROWING SEASON).
14. FINAL APPROVAL AND SUBSTANTIAL COMPLETION NOTICE WILL BE GIVEN WHEN ALL DEFICIENCIES ARE CORRECTED.
15. **WARRANTY:**
- 15.A. SPECIAL WARRANTY: INSTALLER'S STANDARD FORM IN WHICH INSTALLER AGREES TO REPAIR OR REPLACE PLANTINGS AND ACCESSORIES THAT FAIL IN MATERIALS, WORKMANSHIP, OR GROWTH WITHIN SPECIFIED WARRANTY PERIOD.
- 15.A.1. FAILURES INCLUDE, BUT ARE NOT LIMITED TO, THE FOLLOWING:
- 15.A.1.a. DEATH AND UNSATISFACTORY GROWTH, EXCEPT FOR DEFECTS RESULTING FROM LACK OF ADEQUATE MAINTENANCE, NEGLIGENCE, ABUSE BY OWNER, OR INCIDENTS THAT ARE BEYOND CONTRACTOR'S CONTROL.
- 15.A.1.b. STRUCTURAL FAILURES INCLUDING PLANTINGS FALLING OR BLOWING OVER.
- 15.A.1.c. FAULTY OPERATION OF TREE STABILIZATION.
- 15.A.1.d. DETERIORATION OF METALS, METAL FINISHES, AND OTHER MATERIALS BEYOND NORMAL WEATHERING.
- 15.B. WARRANTY PERIODS FROM DATE OF SUBSTANTIAL COMPLETION:
- 15.B.1. TREES, SHRUBS, ORNAMENTAL GRASSES, AND PERENNIALS: ONE YEAR.
- 15.C. INCLUDE THE FOLLOWING REMEDIAL ACTIONS AS A MINIMUM:
- 15.C.1. REMOVE DEAD EXTERIOR PLANTS IMMEDIATELY. REPLACE IMMEDIATELY UNLESS REQUIRED TO PLANT IN THE SUCCEEDING PLANTING SEASON.
- 15.C.2. REPLACE EXTERIOR PLANTS THAT ARE MORE THAN 25 PERCENT DEAD OR IN AN UNHEALTHY CONDITION AT END OF WARRANTY PERIOD.
- 15.C.3. PROVIDE EXTENDED WARRANTY FOR REPLACED PLANT MATERIALS; WARRANTY PERIOD EQUAL TO ORIGINAL WARRANTY PERIOD.
16. **MAINTENANCE SERVICE**
- 16.A. INITIAL MAINTENANCE SERVICE FOR EXTERIOR PLANTS: PROVIDE FULL MAINTENANCE BY SKILLED EMPLOYEES OF LANDSCAPE INSTALLER. BEGIN MAINTENANCE IMMEDIATELY AFTER EACH AREA IS PLANTED AND CONTINUE UNTIL FINAL ACCEPTANCE BY OWNER.
17. **TREE AND SHRUB MAINTENANCE:**


- 17.A. MAINTAIN PLANTINGS BY PRUNING, CULTIVATING, WATERING, WEEDING, FERTILIZING, RESTORING PLANTING SAUCERS, ADJUSTING AND REPAIRING STAKES AND GUY SUPPORTS, AND RESETTING TO PROPER GRADES OR VERTICAL POSITION, AS REQUIRED TO ESTABLISH HEALTHY, VIABLE PLANTINGS. SPRAY OR TREAT AS REQUIRED TO KEEP TREES AND SHRUBS FREE OF INSECTS AND DISEASE. RESTORE OR REPLACE DAMAGED TREE WRAPPINGS.
18. **LAWN MAINTENANCE:**
- 18.A. MAINTAIN AND ESTABLISH LAWN BY WATERING, FERTILIZING, WEEDING, MOWING, TRIMMING, REPLANTING, AND OTHER OPERATIONS. ROLL, REGRADE, AND REPLANT BARE OR ERODED AREAS AND REMULCH TO PRODUCE A UNIFORMLY SMOOTH LAWN. PROVIDE MATERIALS AND INSTALLATION THE SAME AS THOSE USED IN THE ORIGINAL INSTALLATION. IN AREAS WHERE MULCH HAS BEEN DISTURBED BY WIND OR MAINTENANCE OPERATIONS, ADD NEW MULCH AND ANCHOR AS REQUIRED TO PREVENT DISPLACEMENT.
- 18.B. WATERING:
- 18.B.1. PROVIDE AND MAINTAIN TEMPORARY PIPING, HOSES, AND LAWN-WATERING EQUIPMENT TO CONVEY WATER FROM SOURCES AND TO KEEP LAWN UNIFORMLY MOIST TO A DEPTH OF 4 INCHES.
- 18.B.2. SCHEDULE WATERING TO PREVENT WILTING, PUDDLING, EROSION, AND DISPLACEMENT OF TYPE 1 SEED OR MULCH. LAY OUT TEMPORARY WATERING SYSTEM TO AVOID WALKING OVER MUDDY OR NEWLY PLANTED AREAS.
- 18.B.3. WATER LAWN WITH FINE SPRAY AT A MINIMUM RATE OF 1 INCH PER WEEK UNLESS RAINFALL PRECIPITATION IS ADEQUATE.
- 18.C. MOW LAWN AS SOON AS TOP GROWTH IS TALL ENOUGH TO CUT. REPEAT MOWING TO MAINTAIN SPECIFIED HEIGHT WITHOUT CUTTING MORE THAN 1/3 OF GRASS HEIGHT. REMOVE NO MORE THAN 1/3 OF GRASS-LEAF GROWTH IN INITIAL OR SUBSEQUENT MOWINGS. DO NOT DELAY MOWING UNTIL GRASS BLADES BEND OVER AND BECOME MATTED. DO NOT MOW WHEN GRASS IS WET. SCHEDULE INITIAL AND SUBSEQUENT MOWINGS TO MAINTAIN A 2-3 INCH GRASS HEIGHT.
- 18.D. LAWN POSTFERTILIZATION:
- 18.D.1. APPLY FERTILIZER AFTER INITIAL MOWING AND WHEN GRASS IS DRY.

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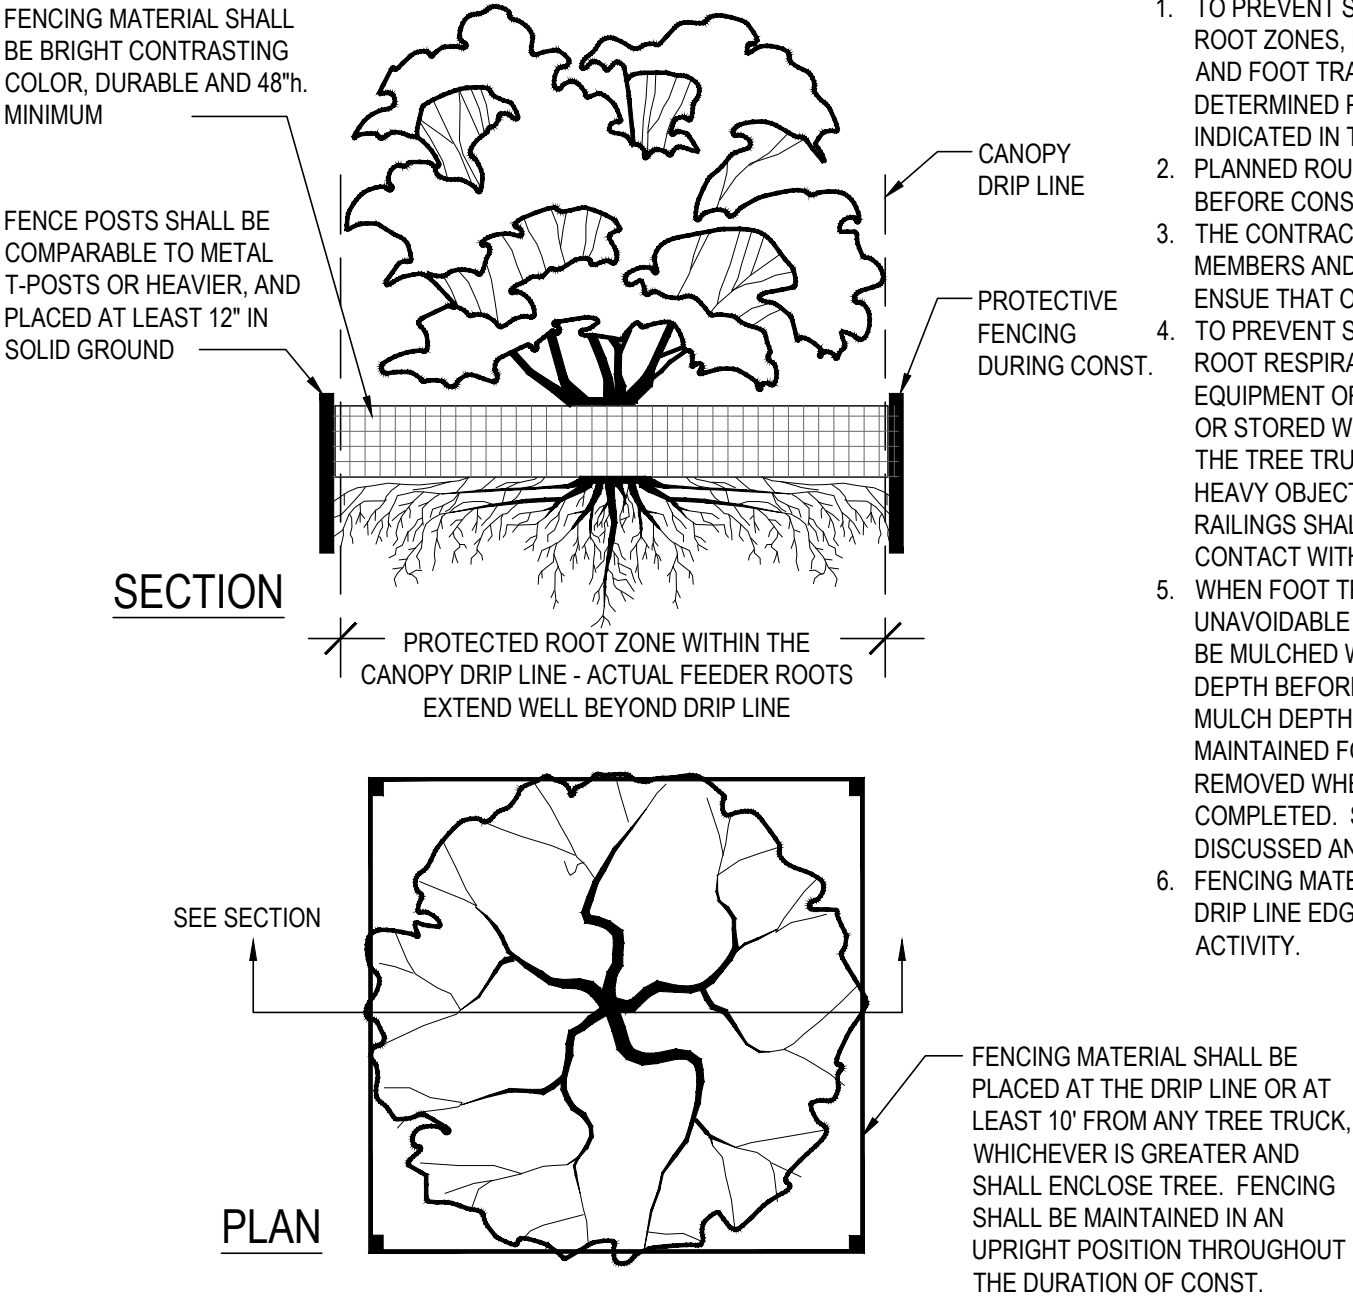


As Constructed		37TH STREET WIDENING PHASE 2B LANDSCAPE NOTES		Project No.	
No Revisions:				AQC M415-021	
Revised:	Designer:	DE	Structure	Drawing Number LS-13	
	Detailer:	DE	Numbers		
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TREE PROTECTION NOTES

- EXISTING TREES WITHIN THE LIMITS OF THE DEVELOPMENT SHALL REMAIN AND BE PROTECTED UNLESS NOTED ON THESE PLANS FOR REMOVAL.
- WITHIN THE DRIP LINE OF PROTECTED EXISTING TREE, THERE SHALL BE NO CUT OR FILL OVER A FOUR-INCH DEPTH UNLESS A QUALIFIED ARBORIST OR FORESTER HAS EVALUATED AND APPROVED THE DISTURBANCE.
- TREE PRUNING AND REMOVAL SHALL BE PERFORMED BY A CERTIFIED ARBORIST.
- PRIOR TO AND DURING CONSTRUCTION, BARRIERS SHALL BE ERECTED AROUND PROTECTED EXISTING TREES WITH SUCH BARRIERS TO BE OF ORANGE FENCING A MINIMUM OF FOUR (4) FEET IN HEIGHT, SECURED WITH METAL T-POSTS, NO CLOSER THAN SIX (6) FEET FROM THE TRUNK OR ONE-HALF (½) OF THE DRIP LINE, WHICHEVER IS GREATER. THERE SHALL BE NO STORAGE OR MOVEMENT OF EQUIPMENT, MATERIAL, DEBRIS OR FILL WITHIN THE FENCED TREE PROTECTION ZONE.
- DURING THE CONSTRUCTION STAGE OF DEVELOPMENT, THE APPLICANT SHALL PREVENT THE CLEANING OF EQUIPMENT OR MATERIAL OR THE STORAGE AND DISPOSAL OF WASTE MATERIAL SUCH AS PAINTS, OILS, SOLVENTS, ASPHALT, CONCRETE, MOTOR OIL OR ANY OTHER MATERIAL HARMFUL TO THE LIFE OF A TREE WITHIN THE DRIP LINE OF ANY PROTECTED TREE OR GROUP OF TREES.
- NO DAMAGING ATTACHMENT, WIRES, SIGNS OR PERMITS MAY BE FASTENED TO PROTECTED TREE.
- LARGE AREAS CONTAINING PROTECTED TREES AND SEPARATED FROM CONSTRUCTION OR LAND CLEARING AREAS, ROAD RIGHTS-OF-WAY AND UTILITY EASEMENTS MAY BE "RIBBONED OFF," RATHER THAN ERECTING PROTECTIVE FENCING AROUND EACH TREE AS REQUIRED ABOVE. THIS MAY BE ACCOMPLISHED BY PLACING METAL T-POST STAKES A MAXIMUM OF FIFTY (50) FEET APART AND TYING RIBBON OR ROPE FROM STAKE-TO-STAKE ALONG THE OUTSIDE PERIMETERS OF SUCH AREAS BEING CLEARED.
- THE INSTALLATION OF UTILITIES, IRRIGATION LINES OR UNDERGROUND FIXTURE REQUIRING EXCAVATION DEEPER THAN SIX (6) INCHES SHALL BE ACCOMPLISHED BY BORING UNDER THE ROOT SYSTEM OF PROTECTED EXISTING TREES AT A MINIMUM DEPTH OF TWENTY-FOUR (24) INCHES. THE AUGER DISTANCE IS ESTABLISHED FROM THE FACE OF THE TREE (OUTER BARK) AND IS SCALED FROM TREE DIAMETER AT BREAST HEIGHT AS DESCRIBED IN THE CHART BELOW:

TREE DIAMETER AT BREAST HEIGHT (INCHES)	AUGER DISTANCE FROM FACE OF TREE (FEET)
0-2	1
3-4	2
5-9	5
10-14	10
15-19	12
OVER 19	15
- TREE REMOVAL SHOWN SHALL BE COMPLETED OUTSIDE OF THE SONGBIRD NESTING SEASON (FEB 1 - JULY 31) OR CONDUCT A SURVEY OF TREES ENSURING NO ACTIVE NESTS IN THE AREA.

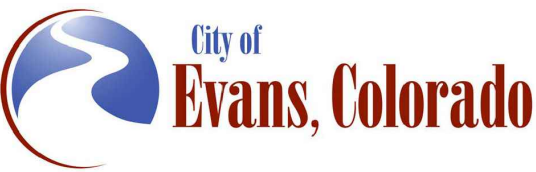


- TREE PROTECTION NOTES:**
- TO PREVENT SOIL COMPACTION WITH IN PROTECTED ROOT ZONES, DESIGNATED ROUTES FOR EQUIPMENT AND FOOT TRAFFIC BY WORK CREWS SHALL BE DETERMINED PRIOR TO COMMENCING ACTIVITIES AND INDICATED IN THESE CONST. DOCUMENTS.
 - PLANNED ROUTES SHALL BE MARKED AT THE SITE BEFORE CONST. COMMENCES.
 - THE CONTRACTOR SHALL INFORM CONSTRUCTION CREW MEMBERS AND SUBCONTRACTORS OF THE ROUTES AND ENSUE THAT ONLY THESE ROUTES ARE USED.
 - TO PREVENT SOIL COMPACTION AND REDUCE TREE ROOT RESPIRATION, NO SOIL STOCKPILES, SUPPLIES, EQUIPMENT OR ANY OTHER MATERIAL SHALL BE PLACED OR STORED WITHIN A TREE DRIP ZONE OR WITHIN 10' OF THE TREE TRUNK, WHICHEVER DISTANCE IS GREATER. HEAVY OBJECTS SUCH AS WOOD PALLETS OR METAL RAILINGS SHALL NOT LEAN AGAINST OR COME IN CONTACT WITH THE TREE.
 - WHEN FOOT TRAFFIC OR EQUIPMENT USE IS UNAVOIDABLE WITHIN THE DRIP LINE, THIS AREA SHALL BE MULCHED WITH WOOD CHIPS TO A PRE-DETERMINED DEPTH BEFORE CONSTRUCTION ACTIVITY BEGINS. MULCH DEPTH AND POSSIBLE PLANKING SHALL BE MAINTAINED FOR THE DURATION OF THE PROJECT AND REMOVED WHEN CONSTRUCTION ACTIVITIES ARE COMPLETED. SITUATIONS SUCH AS THIS NEED TO BE DISCUSSED AND APPROVED BY FORESTRY SERVICES.
 - FENCING MATERIAL SHALL ENCIRCLE ANY TREE WHOSE DRIP LINE EDGE IS WITHIN 20' OF ANY CONSTRUCTION ACTIVITY.

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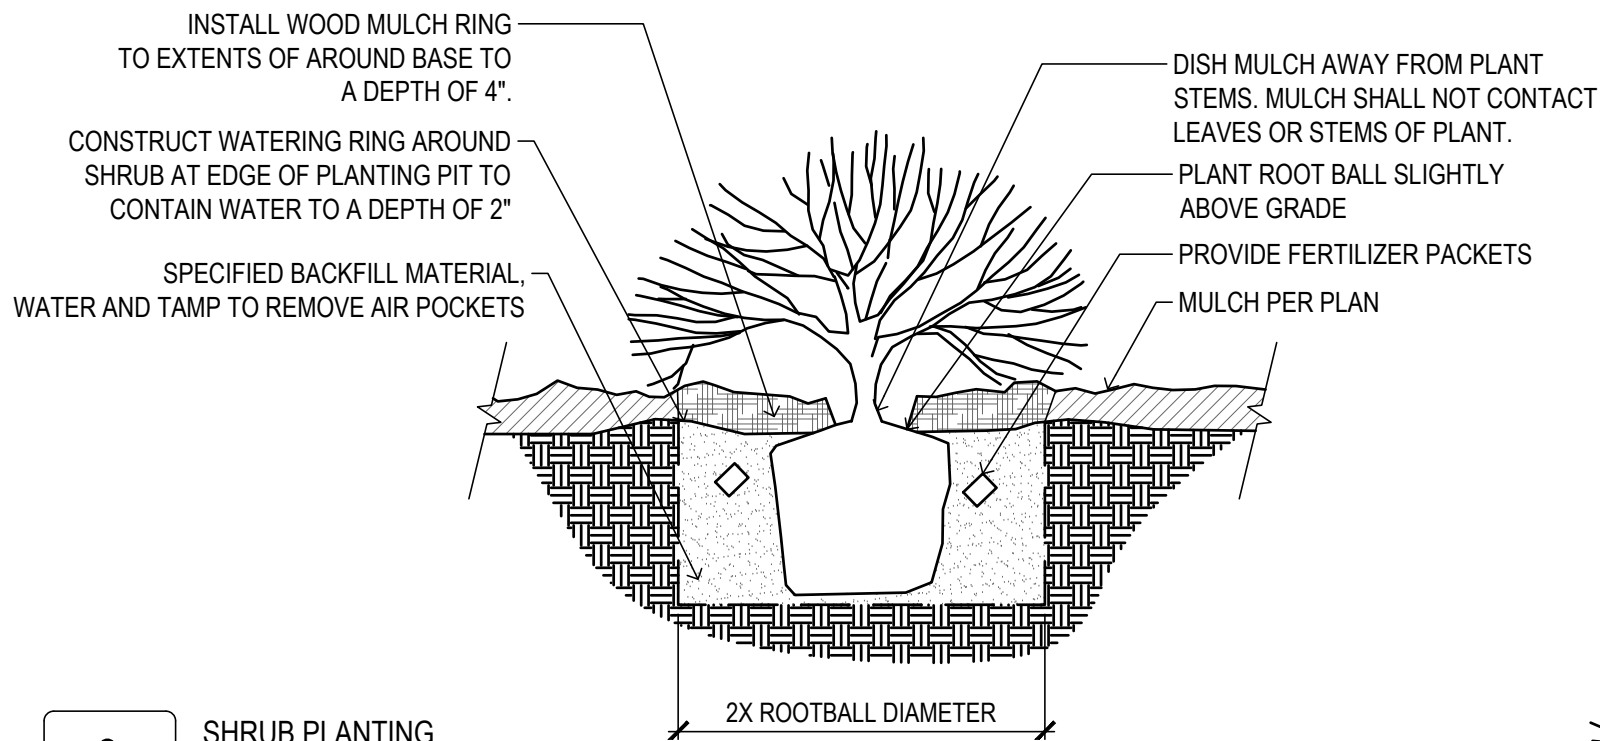
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PRIME CONSULTANT:	SUB CONSULTANT:
Consulting Group, Inc.	

Sheet Revisions			
Date:	Comments	Init.	



As Constructed	37TH STREET WIDENING PHASE 2B LANDSCAPE DETAILS			Project No.
No Revisions:				AQC M415-021
Revised:	Designer: DE	Structure Numbers		Drawing Number LS-14
Void:	Detailer: DE			
	Sheet Subset: LANDSCAPE	Subset Sheets: 14 of 17		Sheet Number 94

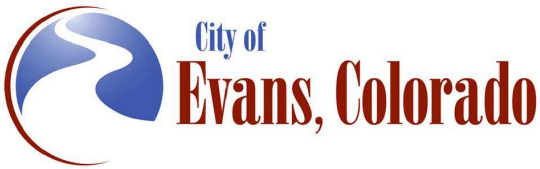
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3

SHRUB PLANTING


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2

PERENNIAL AND GRASSES PLANTING

SCALE: NTS

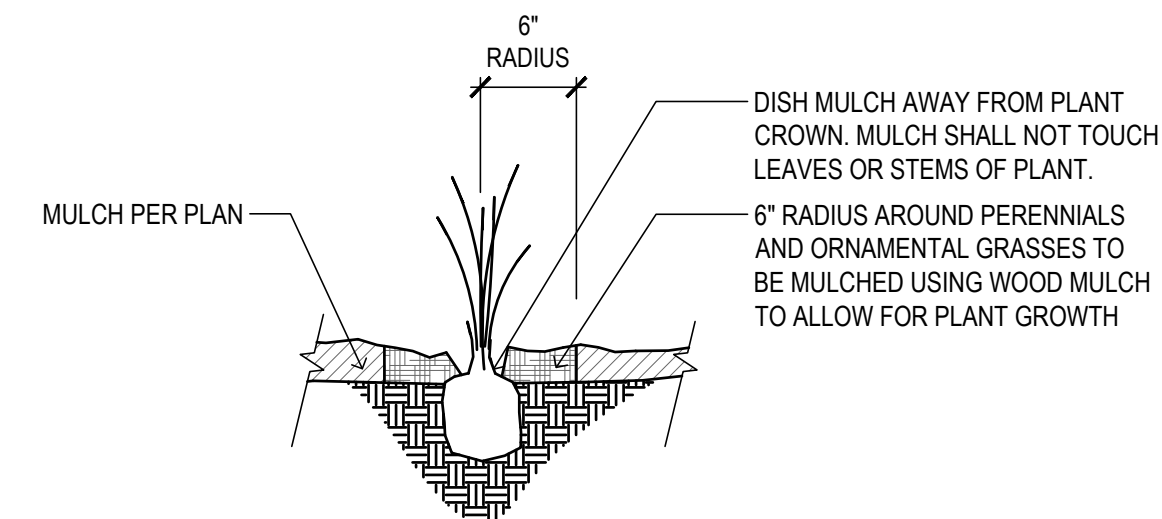

1

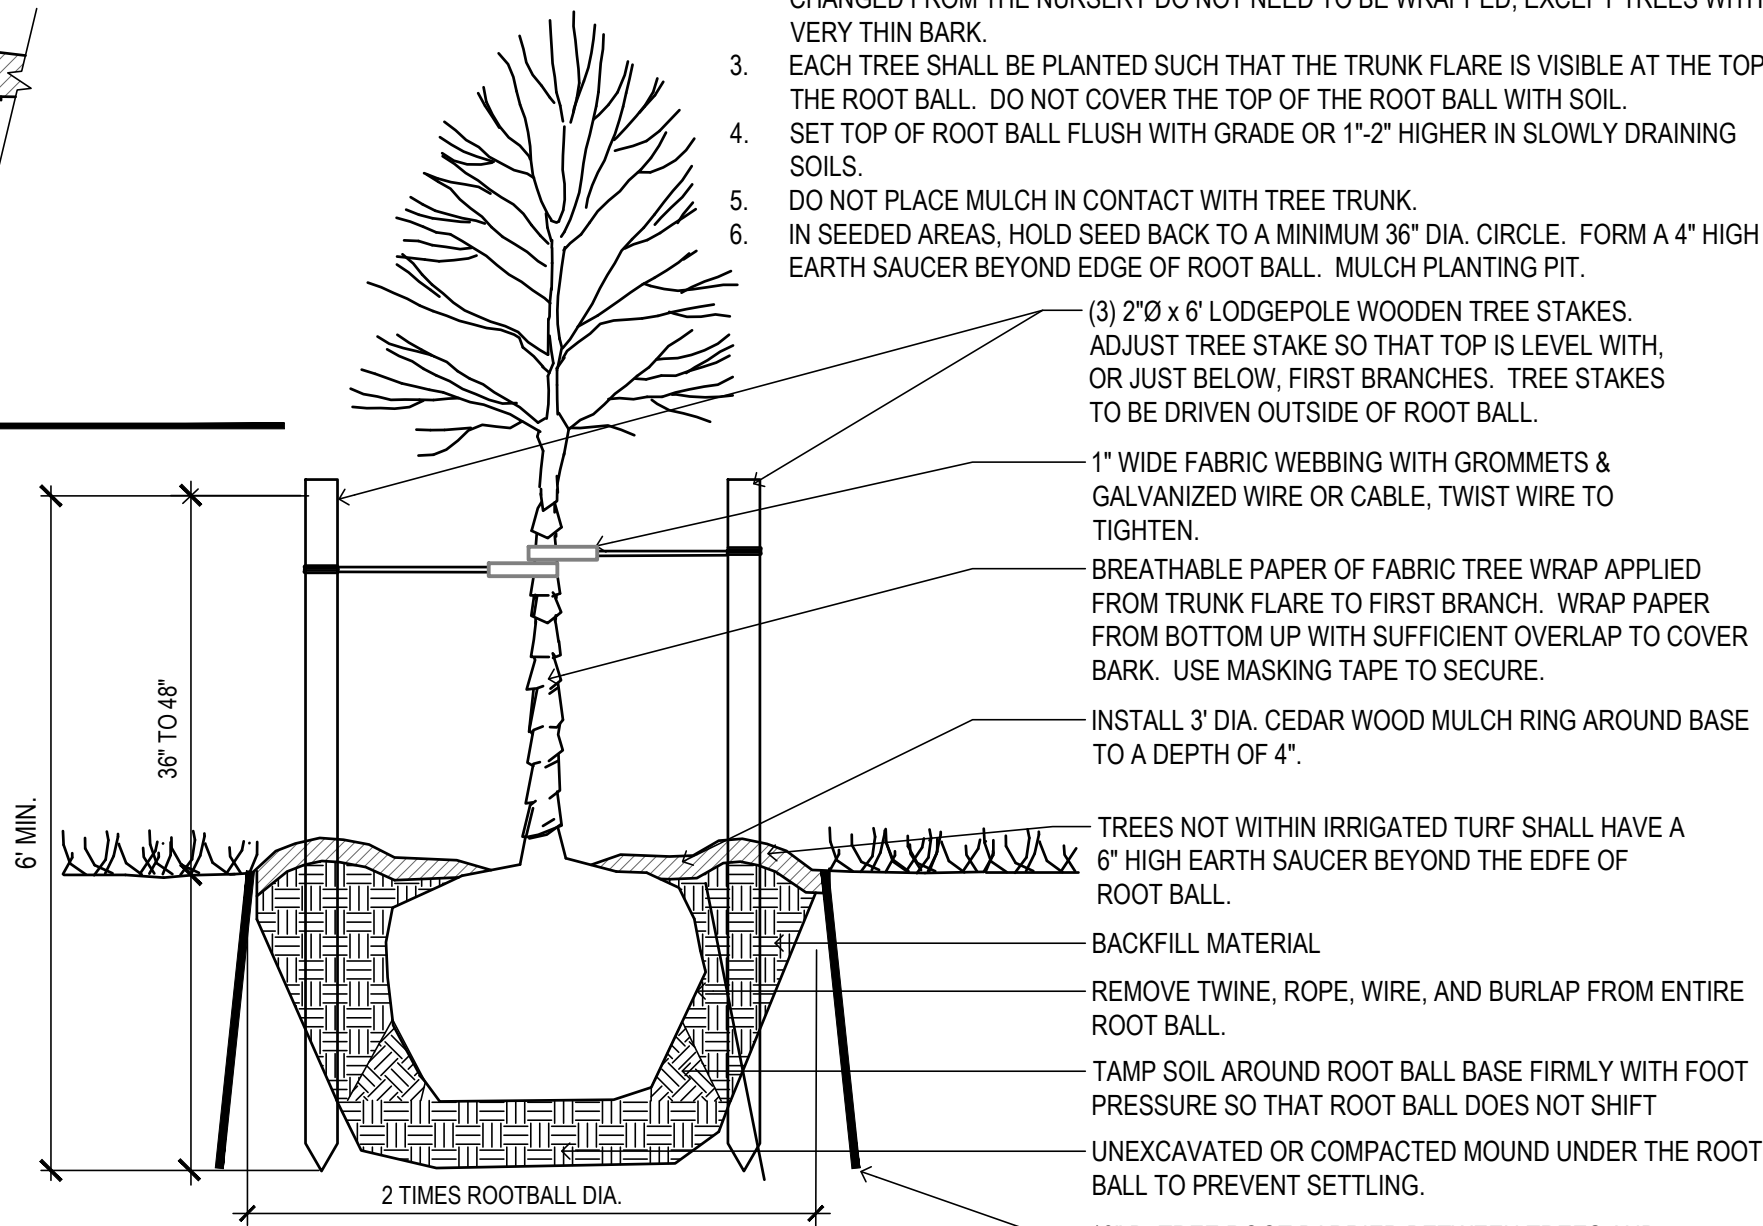DECIDUOUS TREE PLANTING

SCALE: NTS

GENERAL TREE PLANTING NOTES

1. PRUNE ONLY CROSSOVER LIMBS, CO-DOMINANT LEADERS, AND BROKEN OR DEAD BRANCHES. SOME INTERIOR TWIGS AND LATERAL BRANCHES MAY BE PRUNED; HOWEVER, DO NOT REMOVE THE TERMINAL BUDS OF BRANCHES THAT EXTEND TO THE EDGE OF THE CROWN.
2. MARK NORTH SIDE OF THE TREE IN THE NURSERY AND ROTATE TREE TO FACE NORTH AT THE SITE WHENEVER POSSIBLE. TREES WHOSE NORTH ORIENTATION IS NOT CHANGED FROM THE NURSERY DO NOT NEED TO BE WRAPPED, EXCEPT TREES WITH VERY THIN BARK.
3. EACH TREE SHALL BE PLANTED SUCH THAT THE TRUNK FLARE IS VISIBLE AT THE TOP OF THE ROOT BALL. DO NOT COVER THE TOP OF THE ROOT BALL WITH SOIL.
4. SET TOP OF ROOT BALL FLUSH WITH GRADE OR 1"-2" HIGHER IN SLOWLY DRAINING SOILS.
5. DO NOT PLACE MULCH IN CONTACT WITH TREE TRUNK.
6. IN SEEDED AREAS, HOLD SEED BACK TO A MINIMUM 36" DIA. CIRCLE. FORM A 4" HIGH EARTH SAUCER BEYOND EDGE OF ROOT BALL. MULCH PLANTING PIT.

(3) 2"Ø x 6' LODGEPOLE WOODEN TREE STAKES. ADJUST TREE STAKE SO THAT TOP IS LEVEL WITH, OR JUST BELOW, FIRST BRANCHES. TREE STAKES TO BE DRIVEN OUTSIDE OF ROOT BALL.

1" WIDE FABRIC WEBBING WITH GROMMETS & GALVANIZED WIRE OR CABLE, TWIST WIRE TO TIGHTEN.

BREATHABLE PAPER OF FABRIC TREE WRAP APPLIED FROM TRUNK FLARE TO FIRST BRANCH. WRAP PAPER FROM BOTTOM UP WITH SUFFICIENT OVERLAP TO COVER BARK. USE MASKING TAPE TO SECURE.

INSTALL 3' DIA. CEDAR WOOD MULCH RING AROUND BASE TO A DEPTH OF 4".

TREES NOT WITHIN IRRIGATED TURF SHALL HAVE A 6" HIGH EARTH SAUCER BEYOND THE EDGE OF ROOT BALL.



BACKFILL MATERIAL

REMOVE TWINE, ROPE, WIRE, AND BURLAP FROM ENTIRE ROOT BALL.


TAMP SOIL AROUND ROOT BALL BASE FIRMLY WITH FOOT PRESSURE SO THAT ROOT BALL DOES NOT SHIFT

UNEXCAVATED OR COMPACTED MOUND UNDER THE ROOT BALL TO PREVENT SETTLING.

18" D. TREE ROOT BARRIER BETWEEN TREES AND ADJACENT HARDSCAPE (BOTH SIDES), ENSURE IRRIGATION EMITTERS INSTALLED WITHIN BARRIER

Print Date: 12/4/2024	
File Name: 1914_37TH_LANDSCAPE PLANP2B.DWG	
Horiz. Scale: As Noted	Vert. Scale: As Noted
PRIME CONSULTANT: SUB CONSULTANT:	
 	

Sheet Revisions		
Date:	Comments	Init.

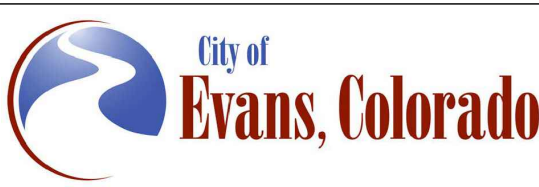

As Constructed	37TH STREET WIDENING PHASE 2B LANDSCAPE DETAILS			Project No.
	No Revisions:			AQC M415-021
Revised:	Designer: DE	Structure		Drawing Number LS-15
	Detailer: DE	Numbers		
Void:	Sheet Subset: LANDSCAPE			Subset Sheets: 15 of 17
				Sheet Number 95


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	No Revisions:			AQC M415-021
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Void:	Detailer:	DE	Numbers	
Sheet Subset: LANDSCAPE		Subset Sheets: 16 of 17		Sheet Number 96

TOP SURFACE OF BOULDERS
WITHIN SIGHT TRIANGLES SHALL BE
35" MAX ABOVE STREET LEVEL

HT. VARIES, 12"-24"
ABOVE CURB, SEE PLAN

6" MIN.
6"

SILOAM SANDSTONE
BOULDER

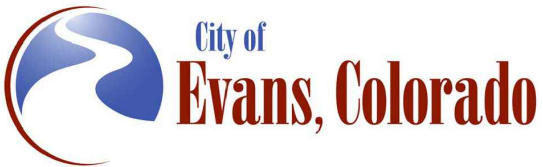LANDSCAPE FABRIC, TYP.
EXTEND 6" BEYOND
BOULDER ON ALL SIDES.

MULCH PER PLAN

COMPACTED
SUBGRADE

BURY BOTTOM OF BOULDER 6" MIN.
BELOW ADJACENT FINISHED GRADE

IF BOULDER IS LOCATED WITHIN
DRIP LINE OF EXISTING TREE, BURY
BOULDER 3" BELOW ADJACENT
FINISHED GRADE, TYP.

*NOTE: BOULDERS SHALL NOT BE PLACED WITHIN 2 FT. OF
SPLASH BLOCK. SEE PLAN FOR HEIGHT AND SIZING.

2


LANDSCAPE BOULDER

SCALE: NTS


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MEDIAN TREE PLANTING

SCALE: NTS

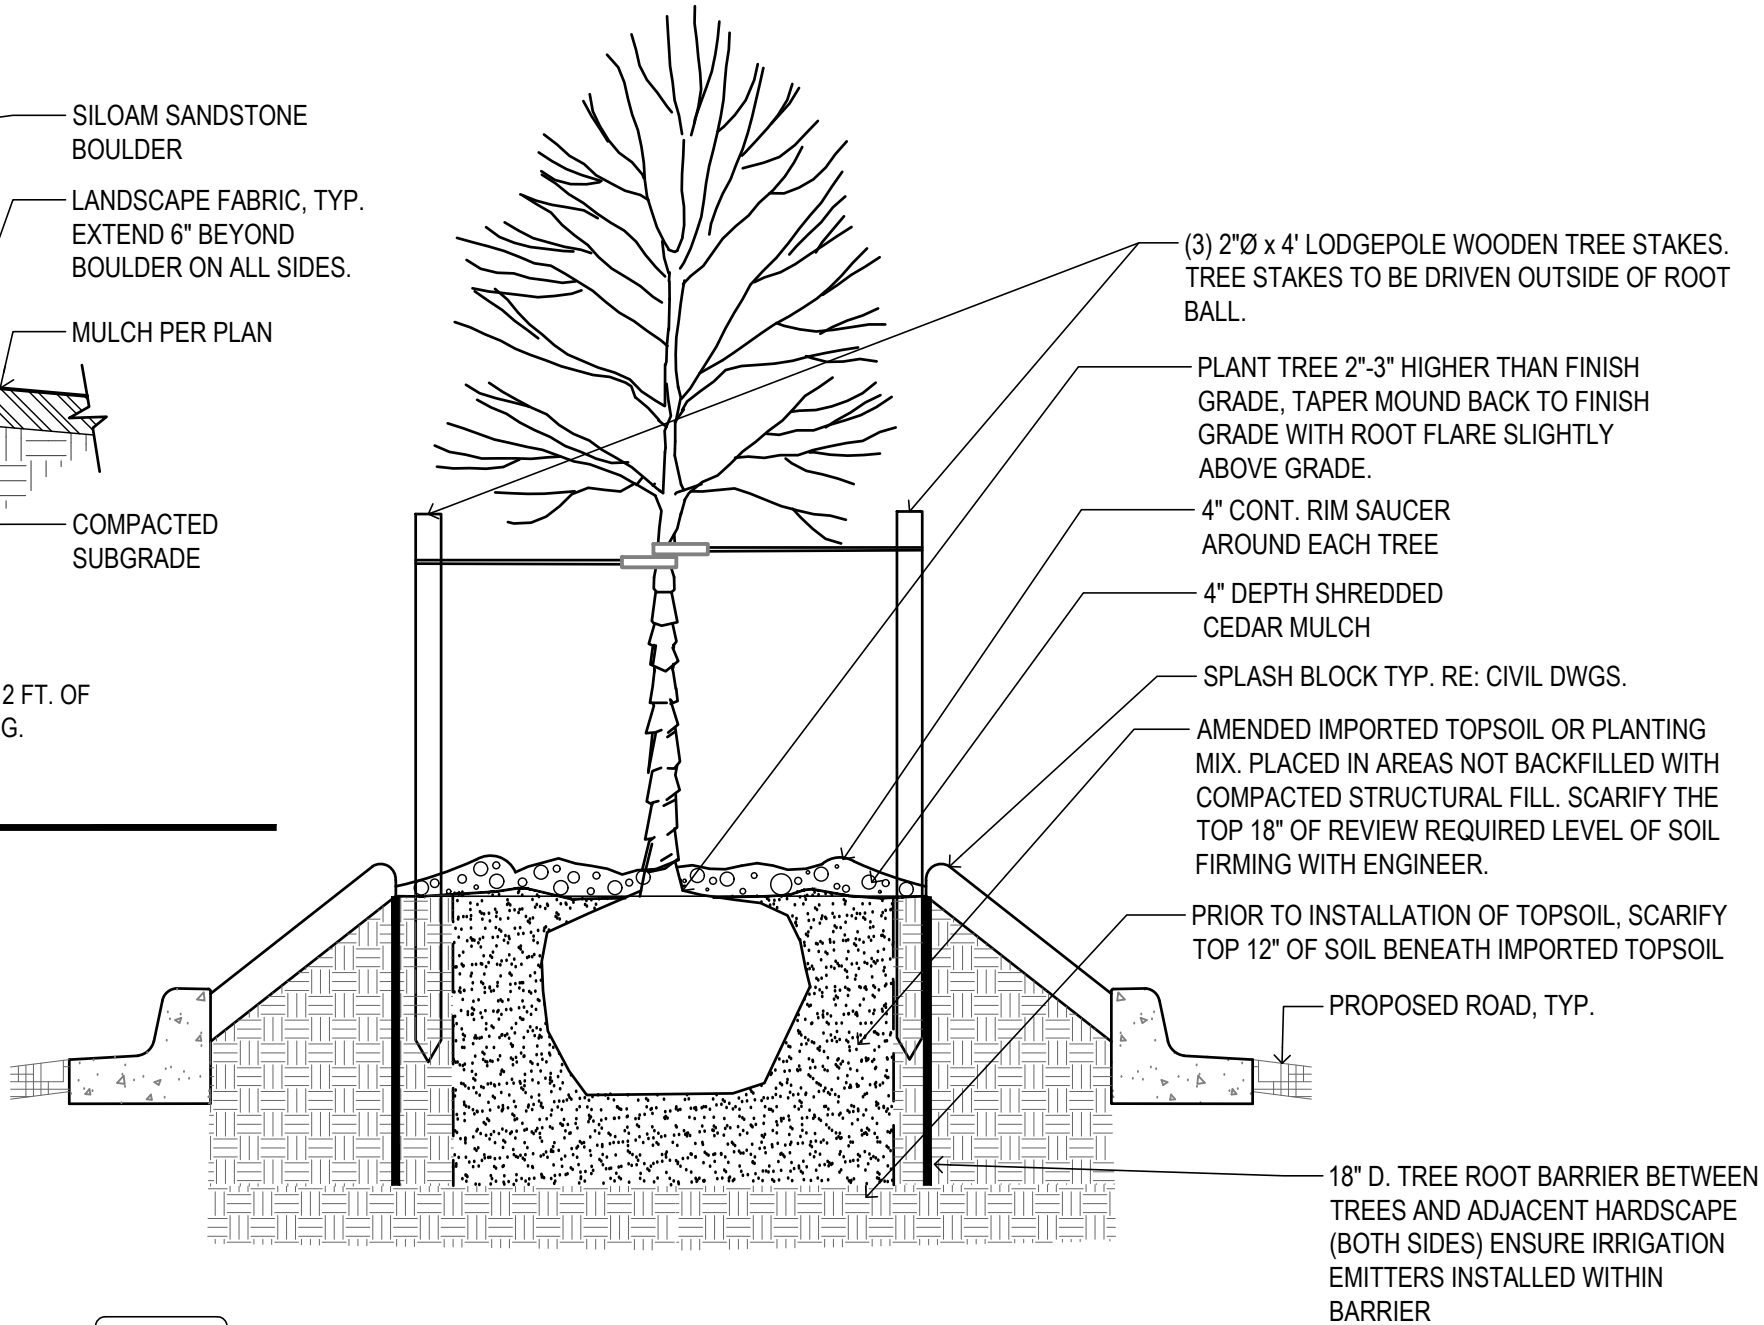

Plot Date: 12/4/2024 1:55 PM Plotted By: Doug Eger
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

- NOTES:
1. SIGHT DISTANCE TRIANGLES: BOULDER AND PLANTS (MATURE SIZE) LOCATED WITHIN SIGHT DISTANCE TRIANGLES SHALL NOT EXTEND MORE THAN 29" ABOVE STREET LEVEL. REFER TO LANDSCAPE AND THE MULCH AND BOULDER PLAN FOR SIGHT TRIANGLE LOCATIONS. SEE PLANS FOR SIGHT DISTANCE TRIANGLE AREA.
 2. CONTRACTOR SHALL SUBMIT PHOTOS OF BOULDERS AT QUARRY FOR THE CITY OF EVANS OR ENGINEER TO REVIEW AND APPROVE PRIOR TO DELIVERY TO PROJECT SITE. INCLUDE AN EXTENDED TAPE MEASURE PLACED NEXT TO BOULDER IN PHOTO FOR SCALE.
 3. THE CITY OF EVANS OR ENGINEER SHALL REVIEW AND APPROVE BOULDER LOCATIONS PRIOR TO PLACEMENT. LOCATIONS SHOULD BE STAKED FOR REVIEW.
 4. VERTICAL JOINTS BETWEEN BOULDERS SHALL NOT EXCEED 1". STONE CHINKING IS NOT ACCEPTABLE.
 5. DAMAGED/SCARRED BOULDERS MAY BE REJECTED BY THE CITY OF EVANS OR ENGINEER.
 6. COMPACT SOIL BENEATH BOULDERS TO REDUCE SETTLING.
 7. PLACE BOULDERS WITH FLATTEST SIDE UP AND MOST ATTRACTIVE FACE (AS DETERMINED BY OWNER'S REPRESENTATIVE) FACING ROADWAY. TOP SURFACE OF BOULDER SHALL BE FLAT AND SLIGHTLY SLOPED FOR DRAINAGE.

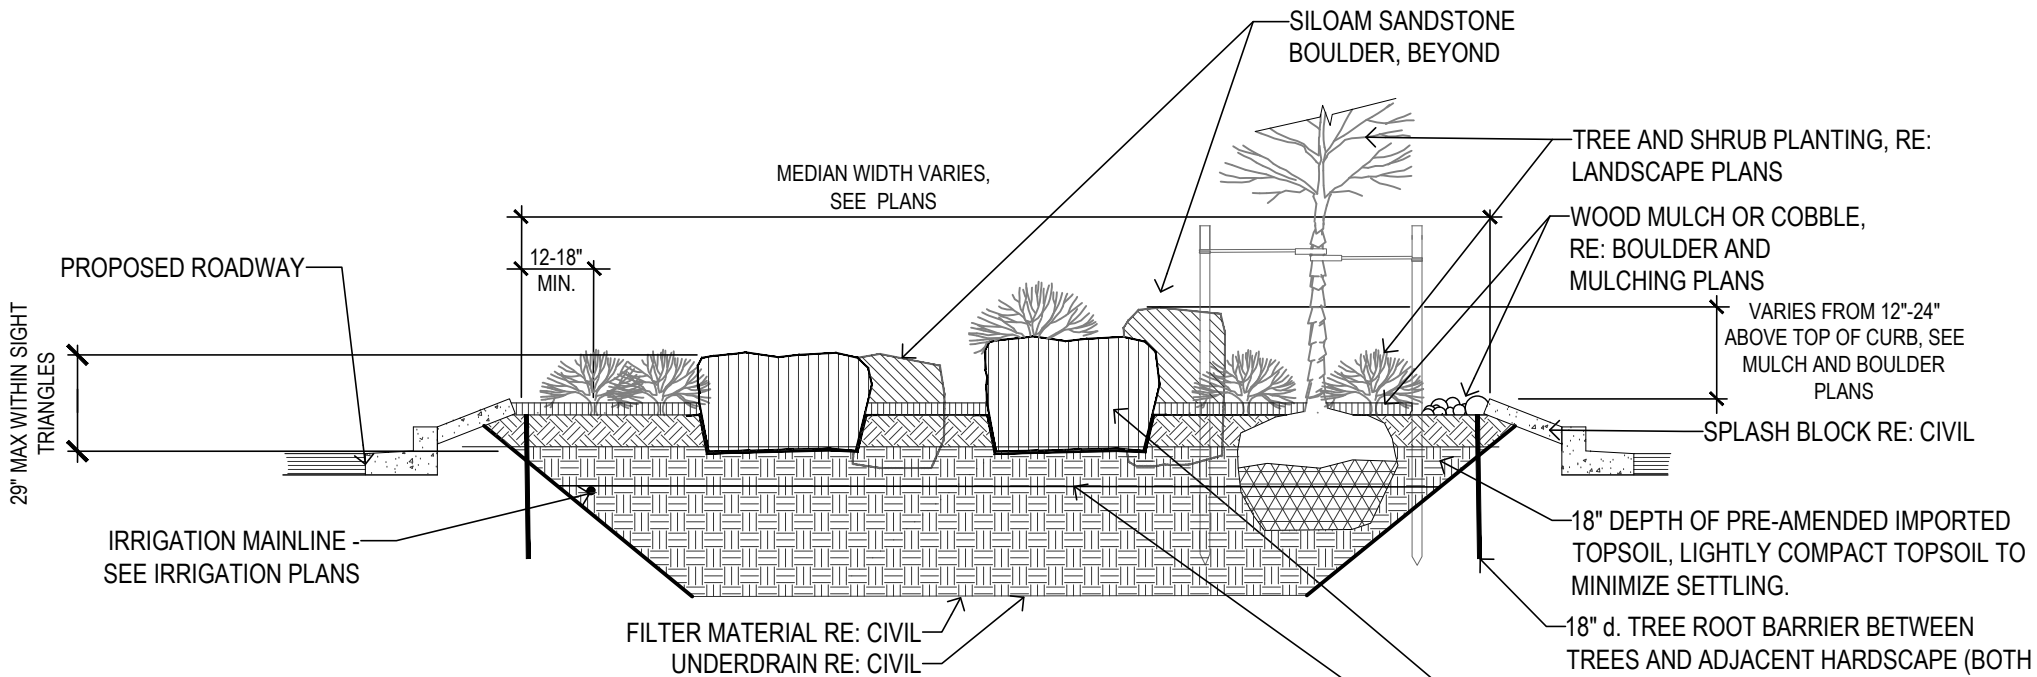1

MEDIAN CROSS SECTION


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Date:	Comments	Init.



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No Revisions:				AQC M415-021
Revised:	Designer: DE	Structure		Drawing Number LS-17
Void:	Detailer: DE	Numbers		Sheet Number 97
		Sheet Subset: LANDSCAPE	Subset Sheets: 17 of 17	

GENERAL DESCRIPTION

A FULLY AUTOMATED SPRINKLER AND DRIP IRRIGATION SYSTEM WILL IRRIGATE TURF AREAS AND TREES. POP-UP SPRAY SPRINKLERS WILL IRRIGATE TURF. INLINE DRIP TUBING WILL IRRIGATE TREES IN MEDIANS (REFER TO IRRIGATION PLANS AND DETAILS).

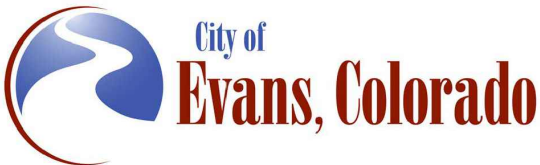RAW WATER FROM PHASE 2A MAINLINE STUB OUTS WILL BE USED FOR IRRIGATION.

SINCE THE IRRIGATION SYSTEM UTILIZES NON-POTABLE WATER, THE FOLLOWING ITEMS ARE REQUIRED:



- IRRIGATION PIPING (SLEEVES, MAINLINE, LATERAL) IS PURPLE
- IRRIGATION EQUIPMENT DESIGNED FOR NON-POTABLE USE (IE. DIRTY WATER VALVES)
- SPRINKLERS TO HAVE PURPLE TOPS
- VALVE BOXES TO HAVE PURPLE LIDS

AN EXISTING IRRIGATION CONTROLLER FROM PHASE 2A WILL BE UTILIZED. TWO WIRE CABLE STUB OUTS FROM PHASE 2A IRRIGATION SYSTEM WILL BE CONNECTED TO AND EXTENDED.

ISOLATION GATE VALVES PERMIT THE ISOLATION OF SECTIONS OF THE SYSTEM FOR REPAIRS OR MAINTENANCE. QUICK COUPLING VALVES HAVE BEEN PROVIDED THROUGHOUT THE SITE FOR INCIDENTAL WATERING.

GENERAL NOTES

1. THE SYSTEM DESIGN ASSUMES A MINIMUM STATIC PRESSURE AND MINIMUM DISCHARGE AS INDICATED ON THE PLANS FOR EACH POINT-OF-CONNECTION. VERIFY PRESSURE AND FLOW ON SITE PRIOR TO CONSTRUCTION AND REPORT ANY DISCREPANCIES WITH THE ASSUMPTIONS.
2. COORDINATE UTILITY LOCATES ("CALL BEFORE YOU DIG") OF UNDERGROUND UTILITIES PRIOR TO CONSTRUCTION.
3. DO NOT PROCEED WITH THE INSTALLATION OF THE IRRIGATION SYSTEM WHEN IT IS OBVIOUS IN THE FIELD THAT OBSTRUCTIONS OR GRADE DIFFERENCES EXIST THAT MIGHT NOT HAVE BEEN CONSIDERED IN THE ENGINEERING, OR IF DISCREPANCIES IN CONSTRUCTION DETAILS, LEGEND, NOTES, OR SPECIFICATIONS ARE DISCOVERED. BRING ALL SUCH OBSTRUCTIONS OR DISCREPANCIES TO THE ATTENTION OF THE OWNER'S REPRESENTATIVE.
4. THE DRAWINGS ARE DIAGRAMMATIC. THEREFORE, THE FOLLOWING SHOULD BE NOTED:
 - A. IRRIGATION COMPONENTS MAY BE SHOWN OUTSIDE PLANTING AREAS FOR CLARITY. AVOID CONFLICTS BETWEEN THE IRRIGATION SYSTEM, PLANTING MATERIALS, AND ARCHITECTURAL FEATURES. INSTALL IRRIGATION PIPE AND WIRING IN LANDSCAPED AREAS WHENEVER POSSIBLE.
 - B. USE ONLY STANDARD TEES AND ELBOW FITTINGS. USE OF CROSS TYPE FITTINGS IS NOT PERMITTED.
5. SELECT NOZZLES FOR SPRAY SPRINKLERS WITH ARCS WHICH PROVIDE COMPLETE AND ADEQUATE COVERAGE WITH MINIMUM OVERSPRAY FOR THE SITE CONDITIONS.
6. THE IRRIGATION CONTRACTOR IS RESPONSIBLE FOR THE INSTALLATION OF IRRIGATION SLEEVING. SLEEVES ARE TO BE INSTALLED FOR BOTH PIPING AND ELECTRICAL WIRING AT EACH HARDSCAPE CROSSING. COORDINATE INSTALLATION OF SLEEVING WITH OTHER TRADES. ANY PIPE OR WIRE WHICH PASSES BENEATH EXISTING HARDSCAPE REQUIRES HORIZONTAL BORING BY THE IRRIGATION CONTRACTOR.
7. WITH REGARD TO PIPE SIZING, THE FOLLOWING SHOULD BE NOTED: IF A SECTION OF UNSIZED PIPE IS LOCATED BETWEEN TWO IDENTICALLY SIZED SECTIONS, THE UNSIZED PIPE IS THE SAME NOMINAL SIZE AS THE TWO SIZED SECTIONS. THE UNSIZED PIPE SHOULD NOT BE CONFUSED WITH THE DEFAULT PIPE SIZE NOTED IN THE LEGEND.
8. INSTALL VAN NOZZLES WHERE SPRAY ANGLES ARE LESS OR GREATER THAN WHAT A FIXED SPRAY NOZZLE CAN IRRIGATE WITHOUT EXCESSIVE OVERSPRAY.
9. CONTRACTOR TO INSTALL SPRINKLERS PERPENDICULAR TO GRADE AND FINE GRADING TECHNIQUES EMPLOYED TO REDUCE SEDIMENT, HEAD DAMAGE, AND RUNOFF TO HARD SURFACES.
10. CONTRACTOR MUST USE CYCLE/SOAK PROGRAMMING TECHNIQUES TO MINIMIZE RUN OFF.

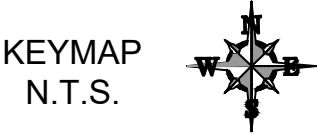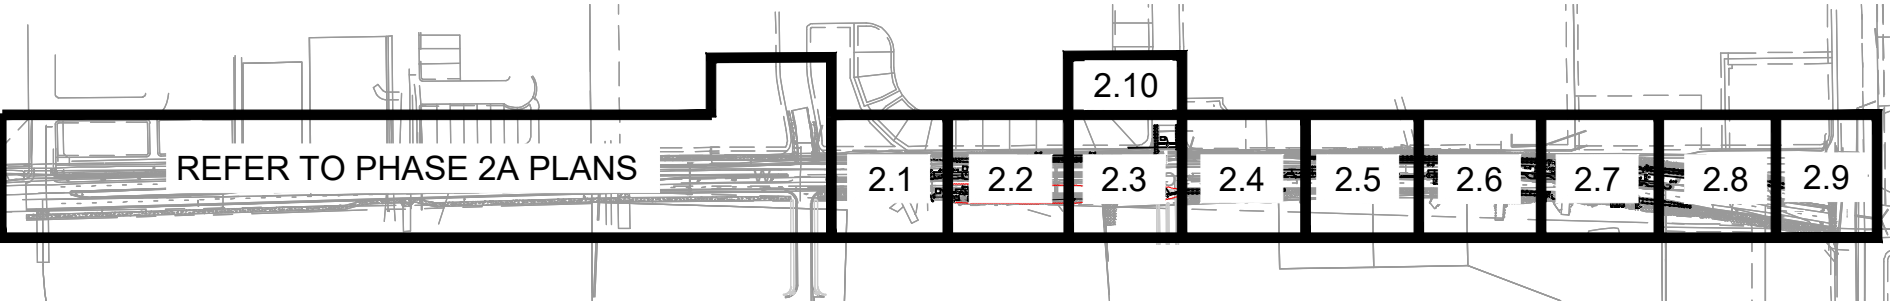

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Sheet Revisions			
Date:	Comments	Init.	



As Constructed		37TH STREET WIDENING PHASE 2B IRRIGATION COVER SHEET		Project No.
No Revisions:				37TH STREET 2B
Revised:	Designer: JHK	Structure		Drawing Number IR1.0
	Detailer: JHK	Numbers		
Void:	Sheet Subset: IRRIGATION	Subset Sheets: 1 of 18		Sheet Number 98

Plot Date: 11/22/2024 1:30 PM, Plotted By: Jason H. Kowarski, D:\BNA\EVANS-STREET\PHASE 2B\Y-PHASE 2B.DWG

LEGEND

---	EXISTING MAINLINE PIPE		POP-UP SPRINKLER: RAIN BIRD MPR SERIES ON 1806-SAM-PRS-NP OR EQUAL @ 30 PSI			
=====	SLEEVING *TYPE: CLASS 200 PVC, COLOR PURPLE	●●● ▲▲▲ ●●● ◆■ ●●●	RADIUS: 5' FLOW (GPM): Q - 0.10 H - 0.20 F - 0.41 RADIUS: 8' FLOW (GPM): Q - 0.26 H - 0.52 F - 1.05 RADIUS: 10' FLOW (GPM): Q - 0.39 H - 0.79 F - 1.58 RADIUS: 12' FLOW (GPM): Q - 0.65 H - 1.30 F - 2.60 RADIUS: 15' FLOW (GPM): Q - 0.92 H - 1.85 F - 3.70			
————	MAINLINE PIPE *TYPE: CLASS 200 PVC, SIZE PER PLAN, COLOR PURPLE					
————	LATERAL PIPE TO SPRINKLERS AND INLINE DRIP RINGS *TYPE: CLASS 200 PVC, COLOR PURPLE *1-INCH UNLESS OTHERWISE NOTED	⊗	INLINE DRIP RING ASSEMBLY (TREE IRRIGATION) *RAIN BIRD XFCV, 9 GPH/EMITTER, 12-INCH EMITTER SPACING OR EQUAL			
— — —	MANIFOLD PIPE TO ZONE CONTROL VALVES *TYPE: CLASS 200 PVC, COLOR PURPLE *SIZE: 1-INCH	□	INLINE DRIP FLUSH VALVE ASSEMBLY *REFER TO DETAIL			
~~~~~	DRIP LATERAL PIPE TO EMITTERS *TYPE: RAIN BIRD XT-700 OR EQUAL *3/4-INCH SIZE UNLESS OTHERWISE NOTED *EMITTER TYPE: RAIN BIRD XERI-BUG OR EQUAL		IRRIGATION CONTROL NOTES: *REFER TO PHASE 2A IRRIGATION PLANS FOR ADDITIONAL INFORMATION REGARDING THE IRRIGATION CONTROL SYSTEM *14 GAUGE P7072D TWO WIRE CABLE (MAXI WIRE)			
-----	INLINE DRIP TO TREES *TYPE: RAIN BIRD XFCV, 0.9 GPH/EMITTER, 12-INCH EMITTER SPACING *INSTALL CHRIS CROSS PATTERN THROUGH TREE AREAS (REFER TO DETAIL)	<table><tr><td>B-1</td></tr><tr><td>15</td></tr><tr><td>1"</td></tr></table>	B-1	15	1"	INDICATES CONTROLLER AND CONTROLLER STATION NUMBER INDICATES LATERAL DISCHARGE IN GPM INDICATES REMOTE CONTROL VALVE SIZE IN INCHES
B-1						
15						
1"						
————	INLINE DRIP HEADER PIPE *TYPE: CLASS 200 PVC, COLOR PURPLE *SIZE: 1-INCH		VALVE BOXES *MODEL: RAIN BIRD VB SERIES OR EQUAL. LID COLORS PURPLE.			
⚡	UNCONNECTED PIPE CROSSING		VALVE DECODER NOTES: *INSTALL ONE BL-5201 DECODER WITH AN INDIVIDUAL VALVE *INSTALL BL-5202 TWO STATION DECODER WHERE THERE ARE A PAIR OF CLUSTERED VALVES *INSTALL BL-5204 FOUR STATION DECODER WHERE THERE ARE FOUR CLUSTERED VALVES			
└─┐	POINT-OF-CONNECTION (P.O.C.)					
⊗	ISOLATION GATE VALVE ASSEMBLY *MODEL (2.5-INCH AND SMALLER): NIBCO T113K OR EQUAL *MODEL (3-INCH AND LARGER): MATCO 10RT *NOMINAL SIZE OF GATE VALVE TO MATCH NOMINAL MAINLINE SIZE					
⌚	QUICK COUPLING VALVE ASSEMBLY *MODEL: RAIN BIRD 44NP OR EQUAL					
⊕	REMOTE CONTROL VALVE ASSEMBLY *MODEL: RAIN BIRD PESB-R OR EQUAL *SIZE AS SHOWN ON PLANS *BALL VALVE: SPEARS PVC COMPACT OR EQUAL *DECODER: SEE DECODER NOTES TO RIGHT					
⊕	DRIP REMOTE CONTROL VALVE ASSEMBLY *MODEL: RAIN BIRD XCZ-100-PRB-COM OR EQUAL *BALL VALVE INCLUDED WITH DRIP ZONE KIT *DECODER: SEE DECODER NOTES TO RIGHT					
⊞	ZONE CONTROL VALVE ASSEMBLY *BALL VALVE: SPEARS PVC COMPACT OR EQUAL *SIZE: 1-INCH					
~~~~~	FLUSH CAP ASSEMBLY *MODEL: RAIN BIRD OR EQUAL					

FLAG NOTES


- 1
- EXCAVATE AND EXPOSE EXISTING PHASE 2A IRRIGATION MAINLINE IN APPROXIMATE LOCATION SHOWN. CUT AND REMOVE CAPPED END AND INSTALL RESTRAINED DUCTILE IRON COUPLING. INSTALL NEW MAINLINE FROM COUPLING. COORDINATE CONNECTION WITH OWNER'S REPRESENTATIVE ON SITE PRIOR TO CONSTRUCTION.
- 2
- EXCAVATE AND EXPOSE EXISTING LATERAL PIPE (BUBBLER ZONE) IN APPROXIMATE LOCATION - REFER TO PHASE 2A IRRIGATION PLANS. CUT LATERAL PIPE AND INSTALL NECESSARY SOLVENT WELD SCH. 40 PVC FITTINGS. INSTALL NEW LATERAL PIPING FROM FITTING TO NEW BUBBLERS. COORDINATE CONNECTION WITH OWNER'S REPRESENTATIVE ON SITE PRIOR TO CONSTRUCTION.
- 3
- EXCAVATE AND EXPOSE EXISTING DRIP TUBING (POINT SOURCE OR INLINE) IN APPROXIMATE LOCATION - REFER TO PHASE 2A IRRIGATION PLANS. CUT DRIP TUBING AND INSTALL PVC BARBED INSERT FITTING SECURED WITH STAINLESS STEEL PINCH CLAMPS. INSTALL NEW DRIP TUBING FROM INSERT FITTING. COORDINATE CONNECTION WITH OWNER'S REPRESENTATIVE ON SITE PRIOR TO CONSTRUCTION.
- 4
- INSTALL IRRIGATION DECODER GROUNDING EQUIPMENT THAT MEETS CONTROLLER MANUFACTURER'S GUIDELINES AT LOCATION ADJACENT TO INDICATED REMOTE CONTROL VALVE ASSEMBLY. COORDINATE EXACT LOCATION OF GROUNDING EQUIPMENT WITH THE OWNER'S REPRESENTATIVE ON SITE PRIOR TO CONSTRUCTION. THE IRRIGATION CONTRACTOR IS RESPONSIBLE FOR GROUNDING THE ENTIRE TWO WIRE PATH PER MANUFACTURER'S GUIDELINES.
- 5
- EXCAVATE AND EXPOSE TWO WIRE CABLE STUB OUT FROM PHASE 2A IN APPROXIMATE LOCATION - REFER TO PHASE 2A IRRIGATION PLANS. SPLICE NEW TWO WIRE CABLE TO THE EXISTING TWO WIRE CABLE USING 3M DBR/Y-6 WIRE SPLICE KITS. PLACE WIRE SPLICE WITHIN 10-INCH ROUND VALVE BOX. INSTALL NEW TWO WIRE CABLE. COORDINATE CONNECTION TO TWO WIRE STUB OUT WITH OWNER'S REPRESENTATIVE ON SITE PRIOR TO CONSTRUCTION.
- 6
- INSTALL SLEEVING FOR EITHER OF THE FOLLOWINGS:
1. ONE (1) 6-INCH SLEEVE FOR IRRIGATION MAINLINE AND ONE (1) 2-INCH SLEEVE FOR TWO WIRE CABLE.
2. ONE (1) SLEEVE FOR LATERAL PIPING. REFER TO SIZE REQUIRED ON PLAN.
COORDINATE SLEEVING INSTALLATION WITH OWNER'S REPRESENTATIVE ON SITE PRIOR TO CONSTRUCTION.
- 7
- IRRIGATION PIPE AND VALVES MAY BE SHOWN OUTSIDE PLANTING AREA IN HARDSCAPE FOR CLARITY ONLY. INSTALL ALL IRRIGATION COMPONENTS IN LANDSCAPED AREA.



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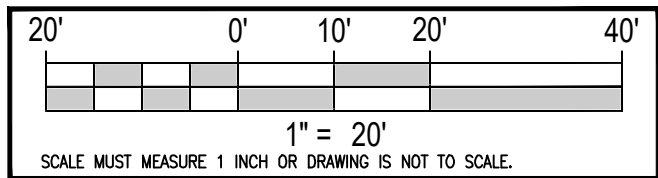
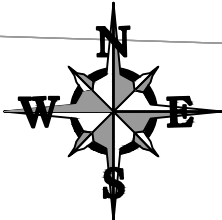


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No Revisions:				37TH STREET 2B
Revised:	Designer: JHK	Structure Numbers		Drawing Number IR1.1
Void:	Detailer: JHK			
	Sheet Subset: IRRIGATION	Subset Sheets: 2 of 18		Sheet Number

Plot Date: 11/22/2024 1:30 PM Plotted By: Jason H. Kousner
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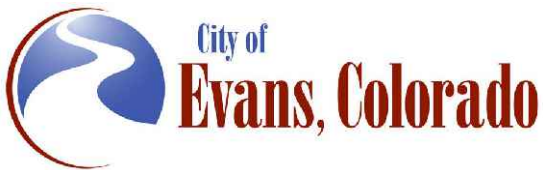

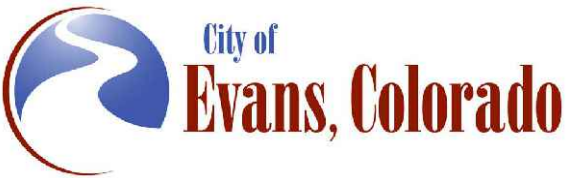
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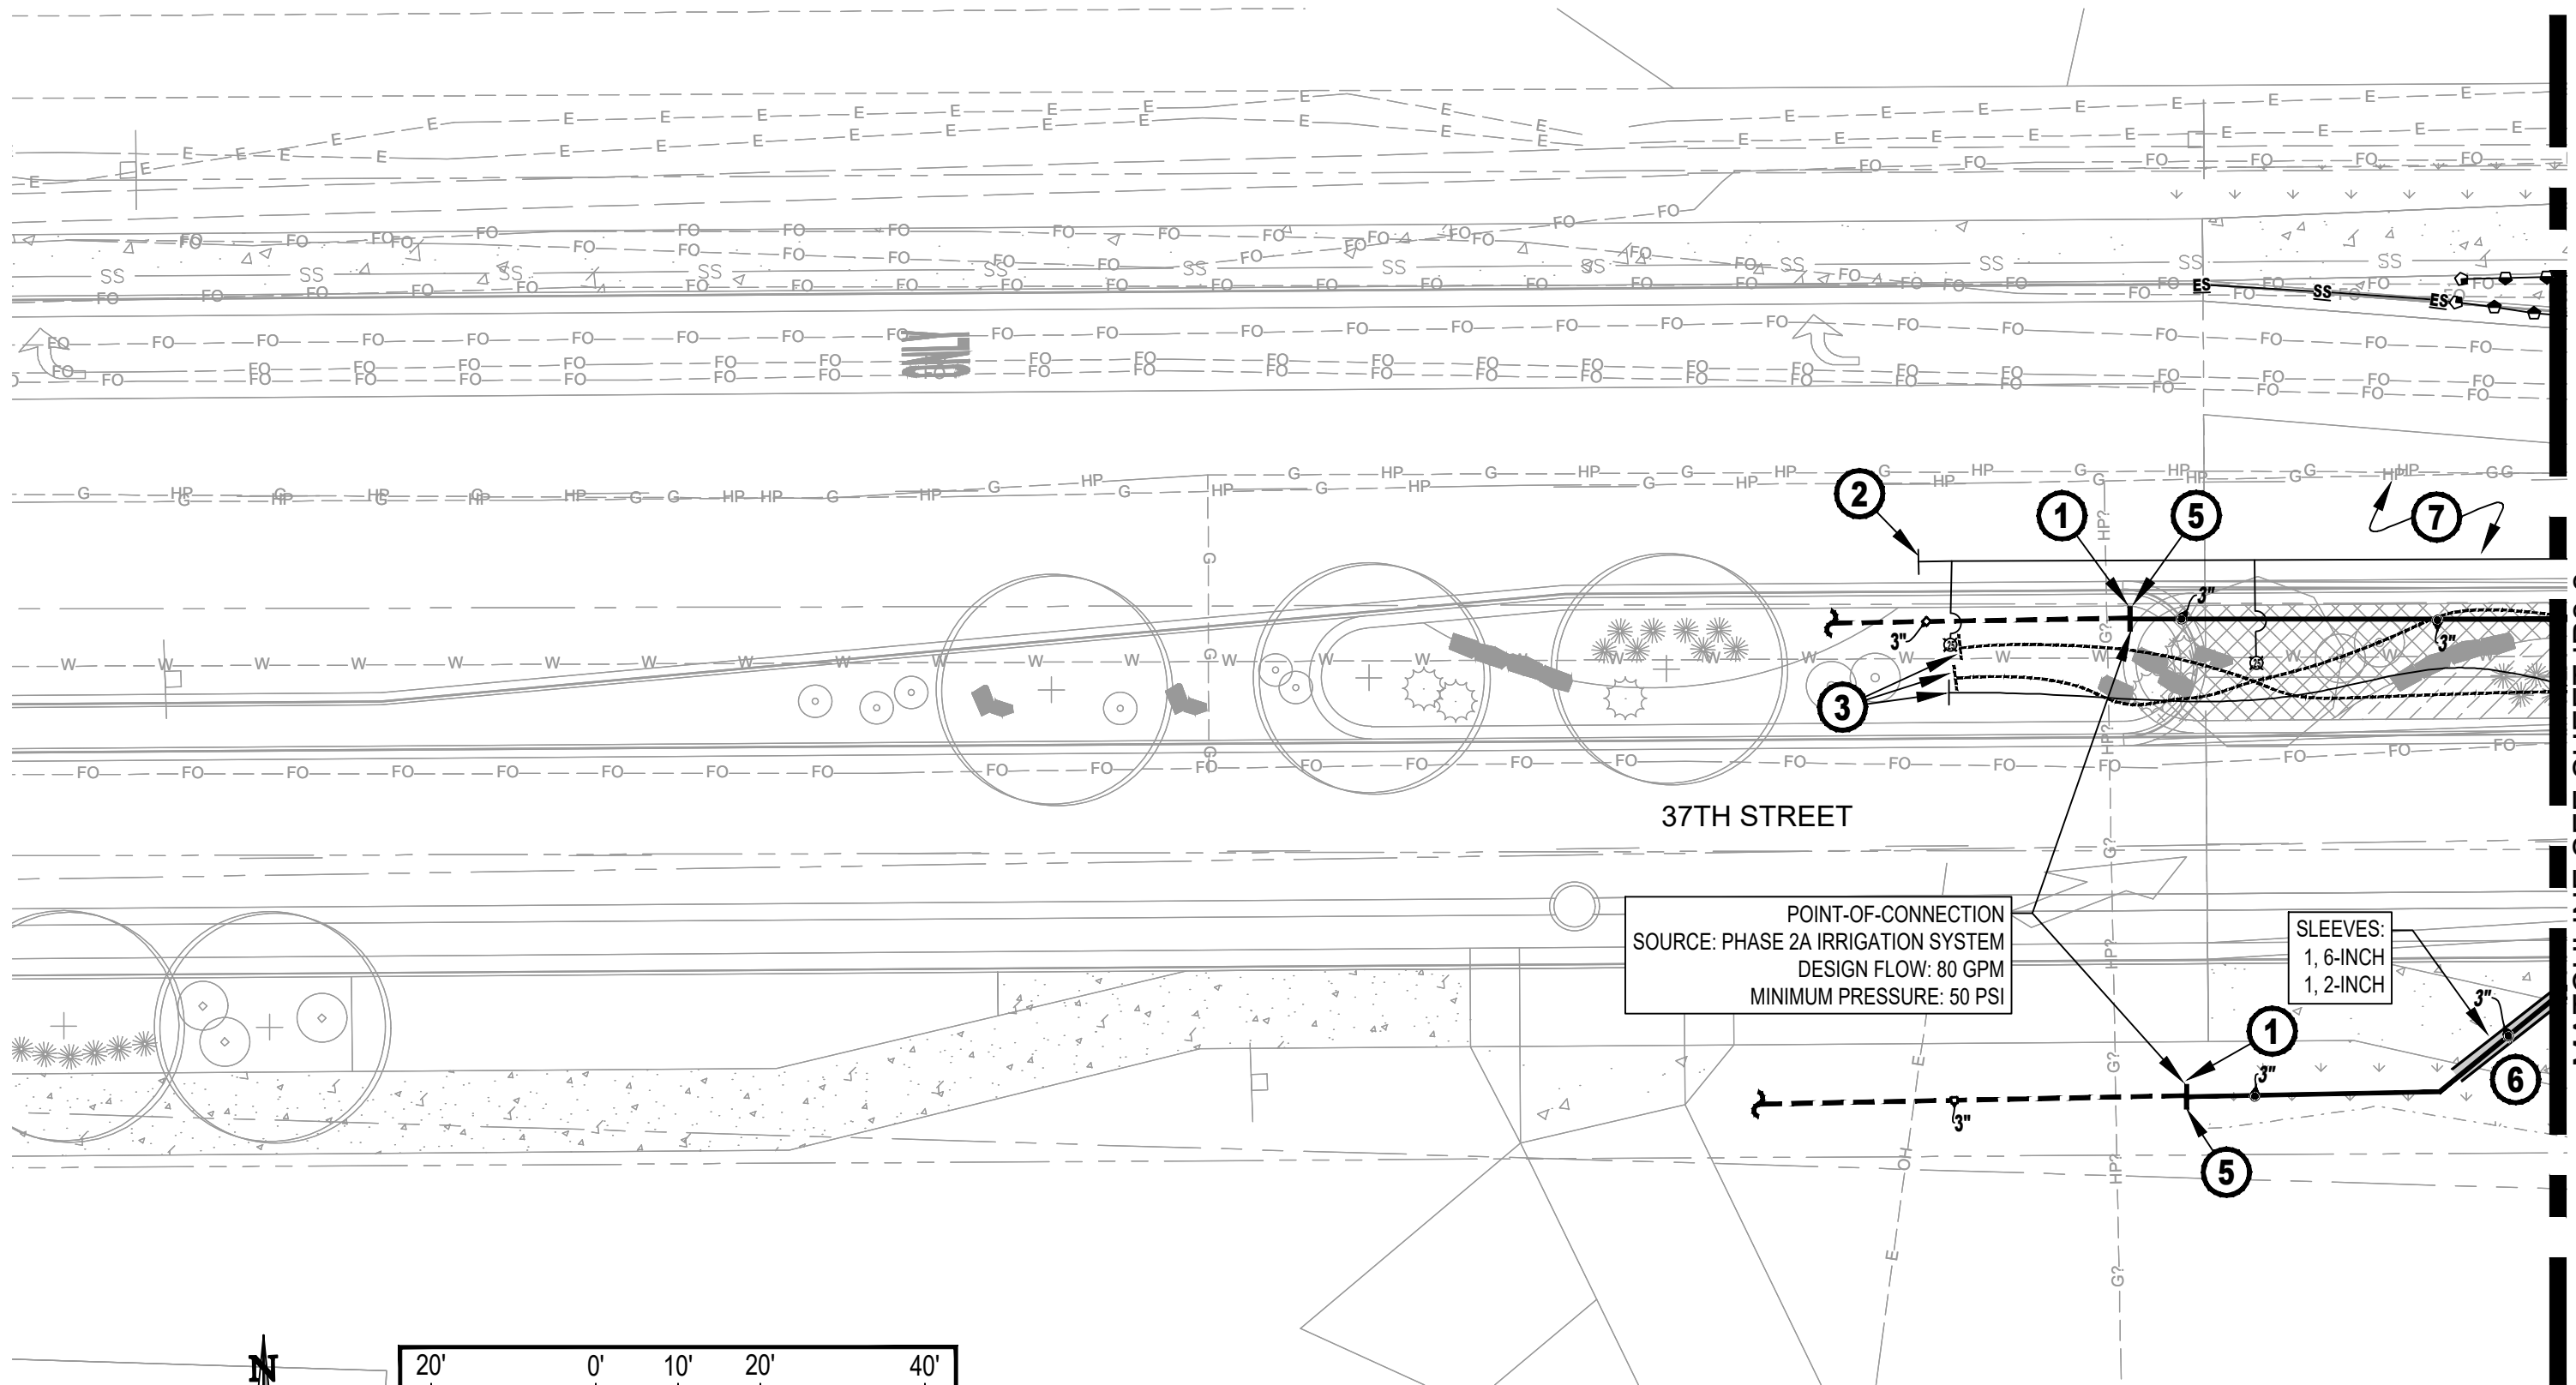


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No Revisions:	IRRIGATION PLAN			37TH STREET 2B
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Void:	Detailer: JHK			Sheet Number 100
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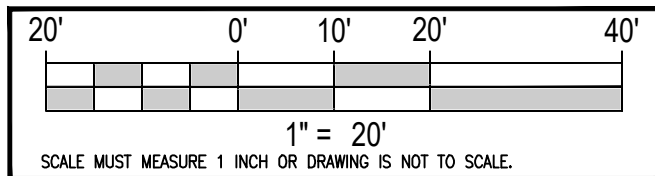
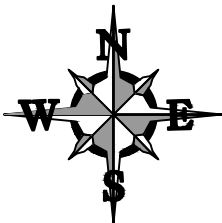
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AD PLANS 3/26/2025

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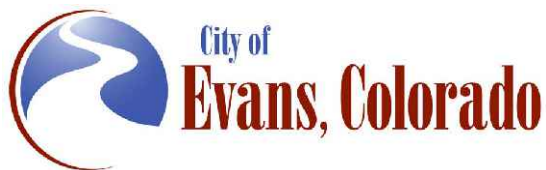


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	Designer:	JHK	Structure Numbers	Drawing Number IR2.2
	Detailer:	JHK		
	Sheet Subset: IRRIGATION	Subset Sheets: 4 of 18		Sheet Number 101

MATCHLINE SEE SHEET IR2.1



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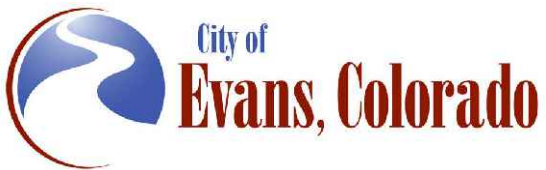


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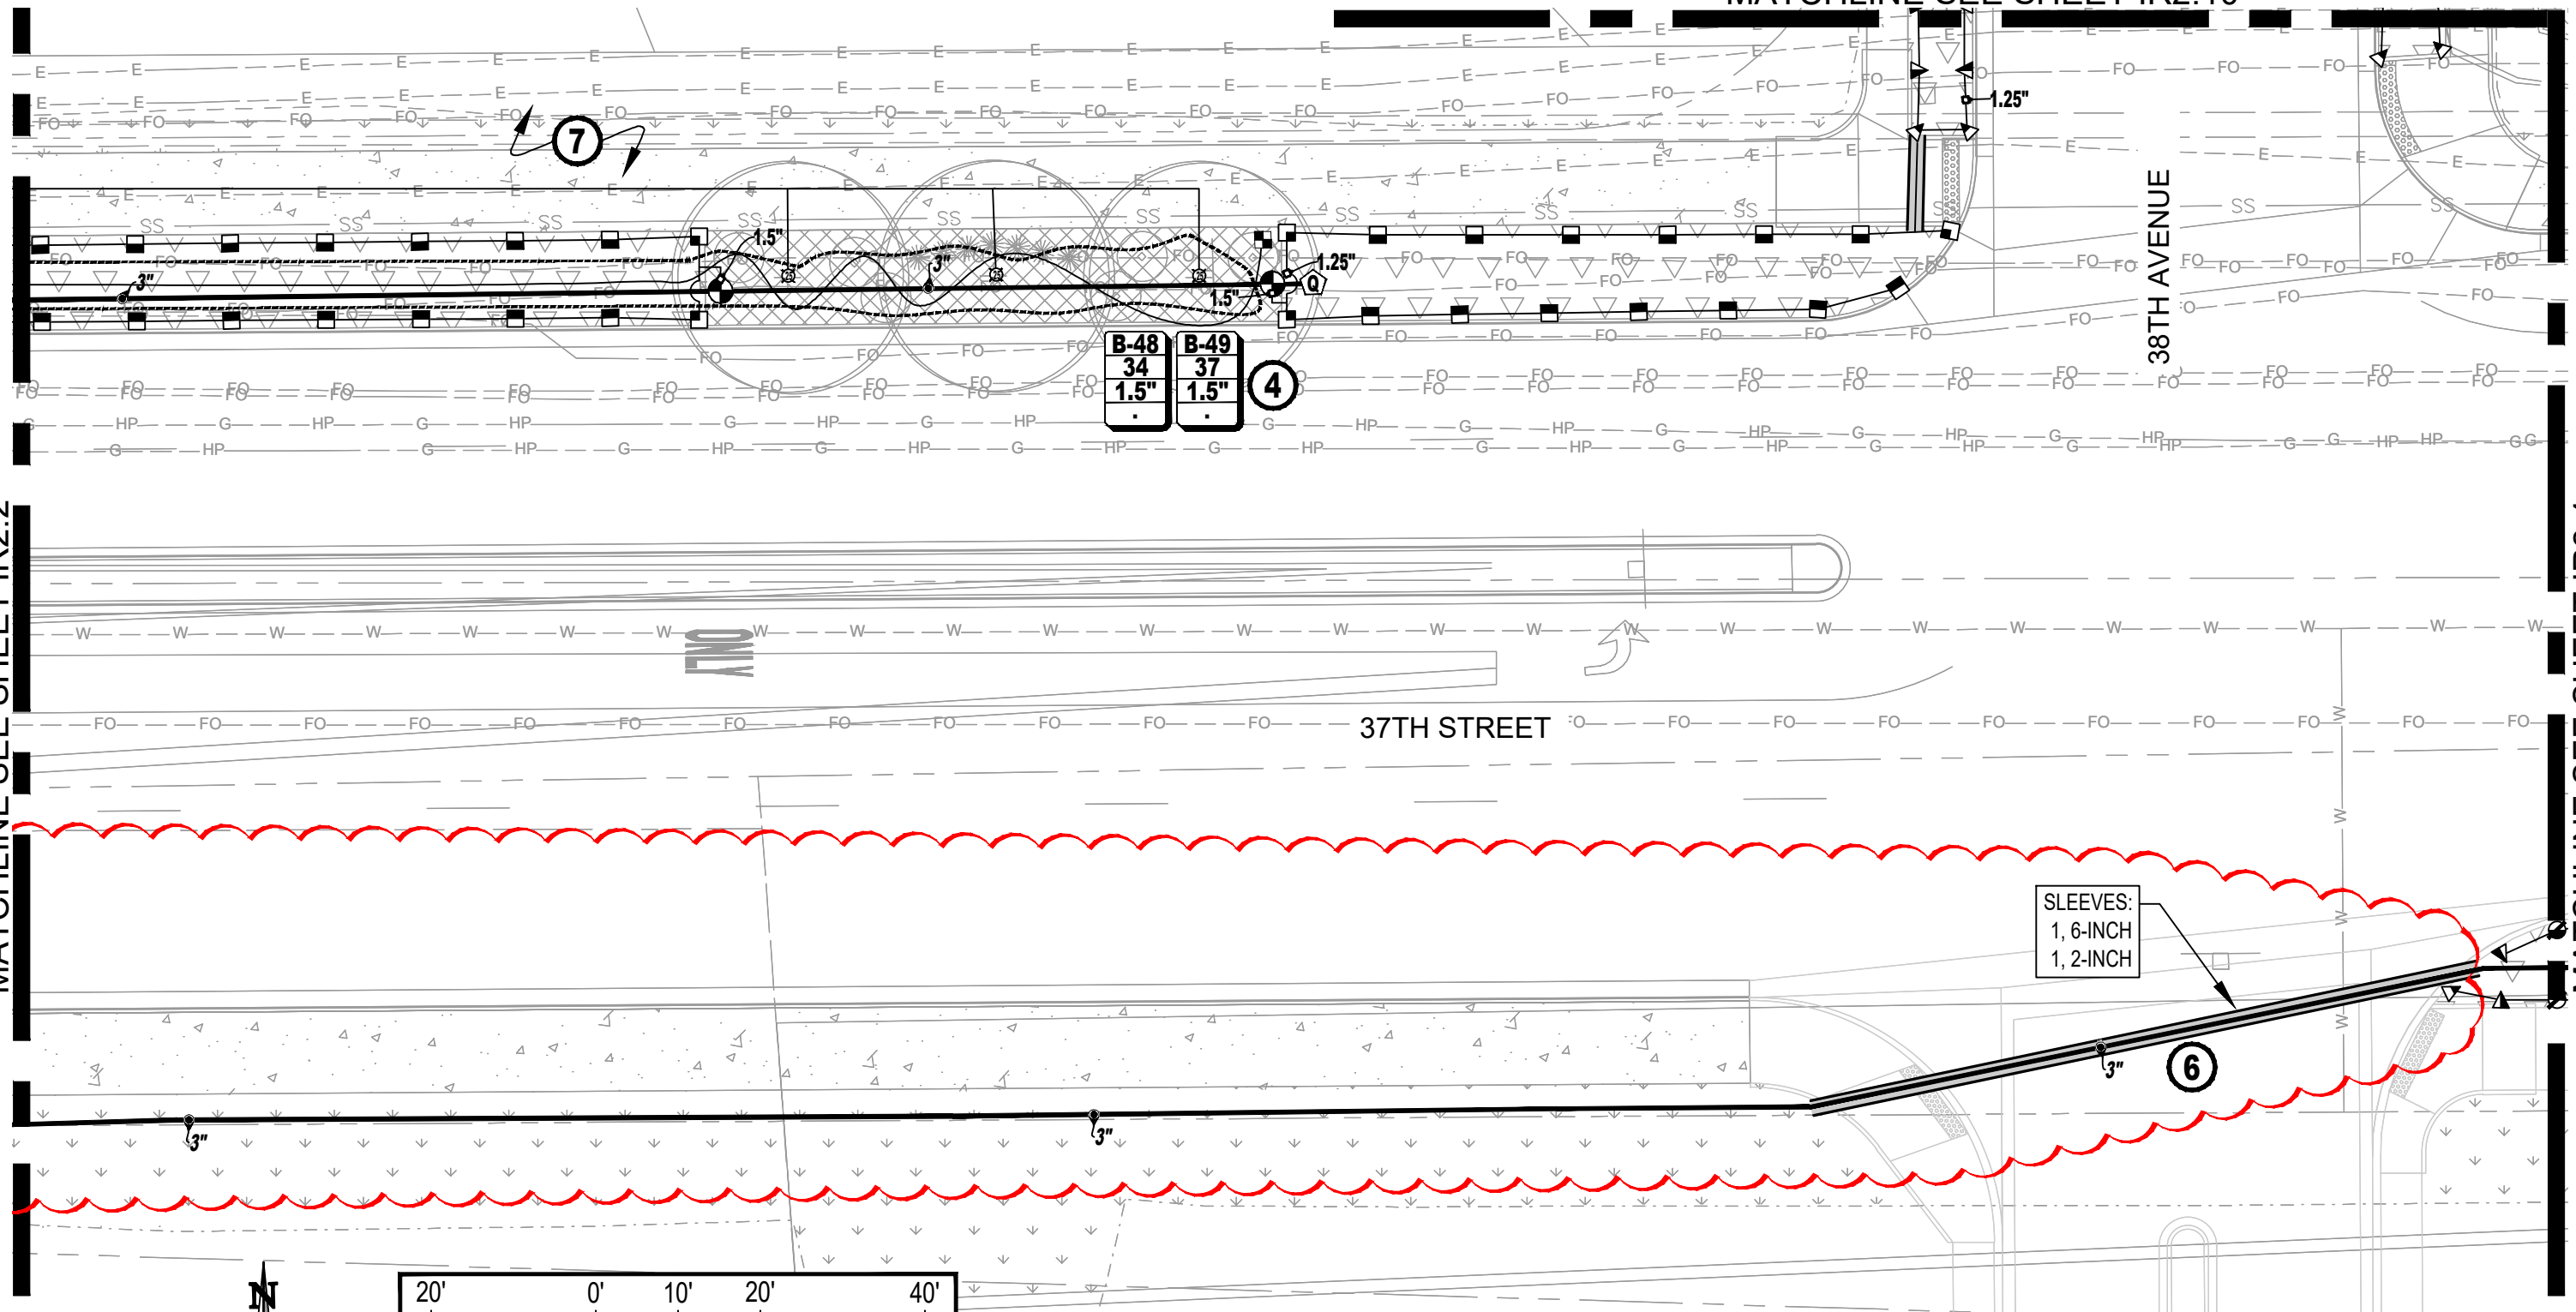
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As Constructed No Revisions: Revised: Void:	37TH STREET WIDENING PHASE 2B IRRIGATION PLAN			Project No. 37TH STREET 2B	
	Designer:	JHK	Structure Numbers	Drawing Number	IR2.3
	Detailer:	JHK		Sheet Number	102
	Sheet Subset:	IRRIGATION	Subset Sheets: 5 of 18		

MATCHLINE SEE SHEET IR2.2





MATCHLINE SEE SHEET IR2.4

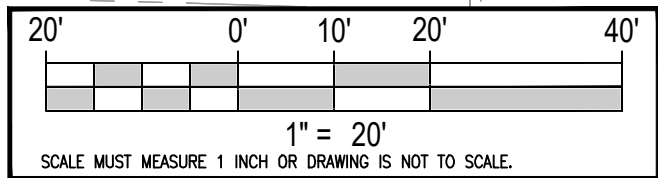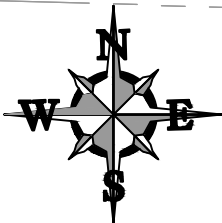AD PLANS 3/26/2025

Plot Date: 11/22/2024 1:30 PM Plotted By: Jason H. Kousner
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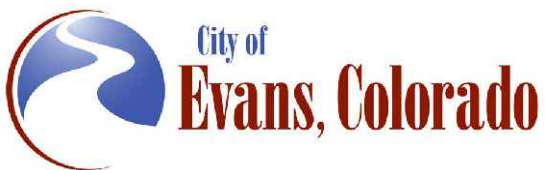


Know what's below.
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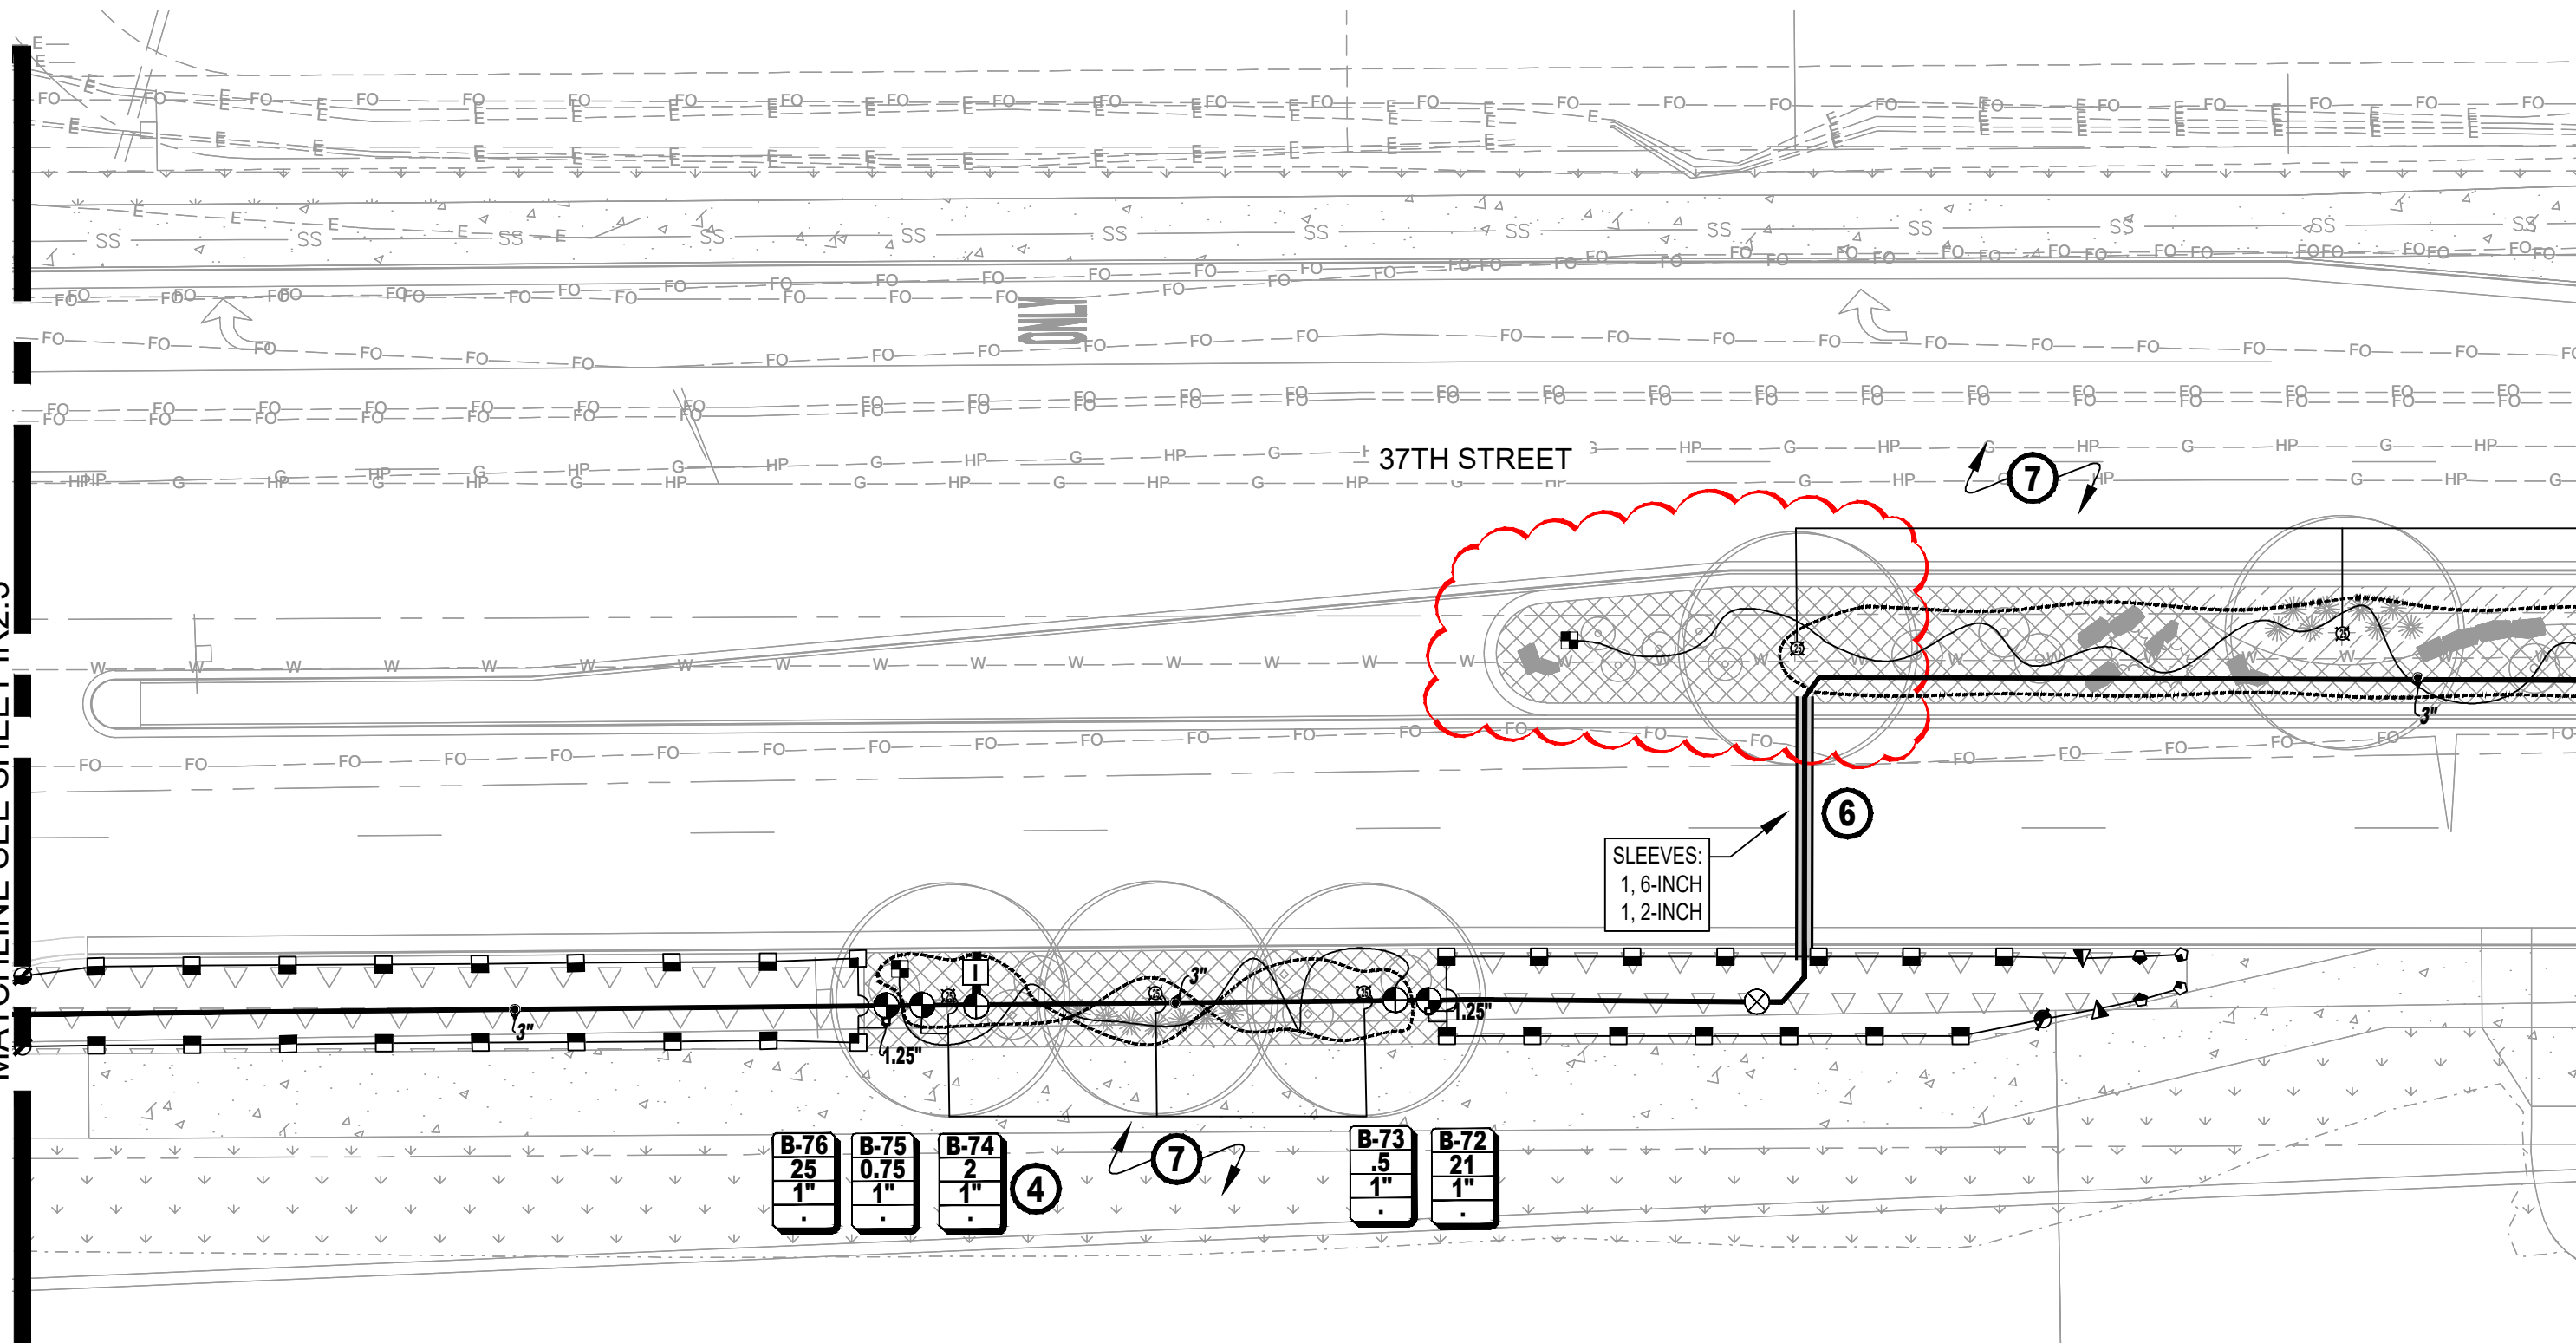
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PRIME CONSULTANT:	SUB CONSULTANT:
 RockSol Consulting Group, Inc.	 Aqua Engineering Inc. 200 Broadway Drive, Unit 40 Fort Collins, CO 80501-2002 (970) 225-8800 www.aquaengineering.com

Sheet Revisions		
Date:	Comments	Init.

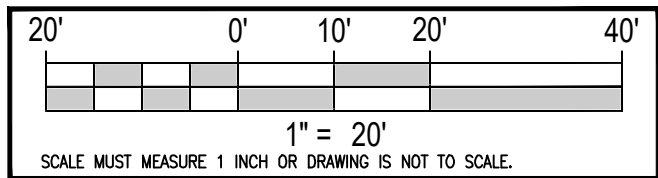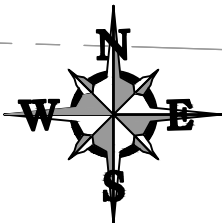

As Constructed	37TH STREET WIDENING PHASE 2B			Project No.
	IRRIGATION PLAN			37TH STREET 2B
No Revisions:	Designer:	JHK	Structure	Drawing Number
Revised:	Detailer:	JHK	Numbers	IR2.4
Void:	Sheet Subset:	IRRIGATION	Subset Sheets: 6 of 18	Sheet Number 103

MATCHLINE SEE SHEET IR2.3





MATCHLINE SEE SHEET IR2.5

AD PLANS 3/26/2025

Plot Date: 11/22/2024 1:30 PM Plotted By: Jason H. Kousner
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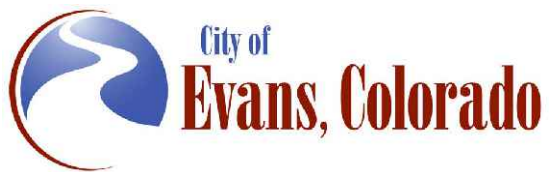


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Date:	Comments	Init.

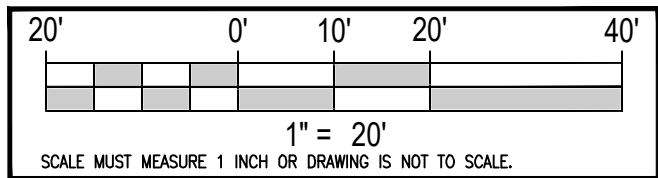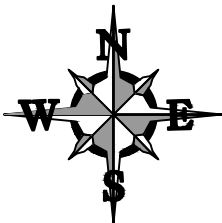

As Constructed No Revisions: Revised: Void:	37TH STREET WIDENING PHASE 2B IRRIGATION PLAN			Project No. 37TH STREET 2B
	Designer:	JHK	Structure Numbers	Drawing Number IR2.5
	Detailer:	JHK		
	Sheet Subset: IRRIGATION	Subset Sheets: 7 of 18		Sheet Number 104

MATCHLINE SEE SHEET IR2.4

MATCHLINE SEE SHEET IR2.6

AD PLANS 3/26/2025

Plot Date: 11/22/2024 1:30 PM Plotted By: Jason H. Kousner
D:\BHA\EVANS-37TH\47TH\EAST OF ROUNDABOUT\PHASE 2B\PHASE 2B.DWG



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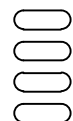
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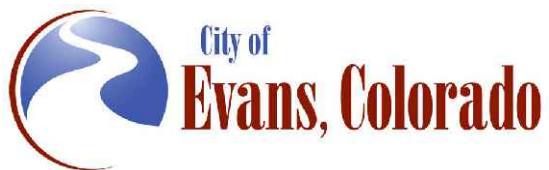


SUB CONSULTANT:



Sheet Revisions

Date:	Comments	Init.



As Constructed

No Revisions:

Revised:

Void:

37TH STREET WIDENING PHASE 2B
IRRIGATION PLAN

Designer: JHK
Detailer: JHK

Structure Numbers
Sheet Subset: IRRIGATION Subset Sheets: 8 of 18

Project No.

37TH STREET 2B

Drawing Number IR2.6

Sheet Number 105

MATCHLINE SEE SHEET IR2.5



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AD PLANS 3/26/2025

Plot Date: 11/22/2024 1:30 PM Plotted By: Jason H. Kousner
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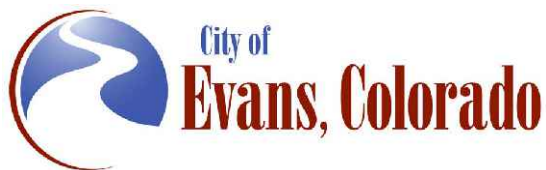


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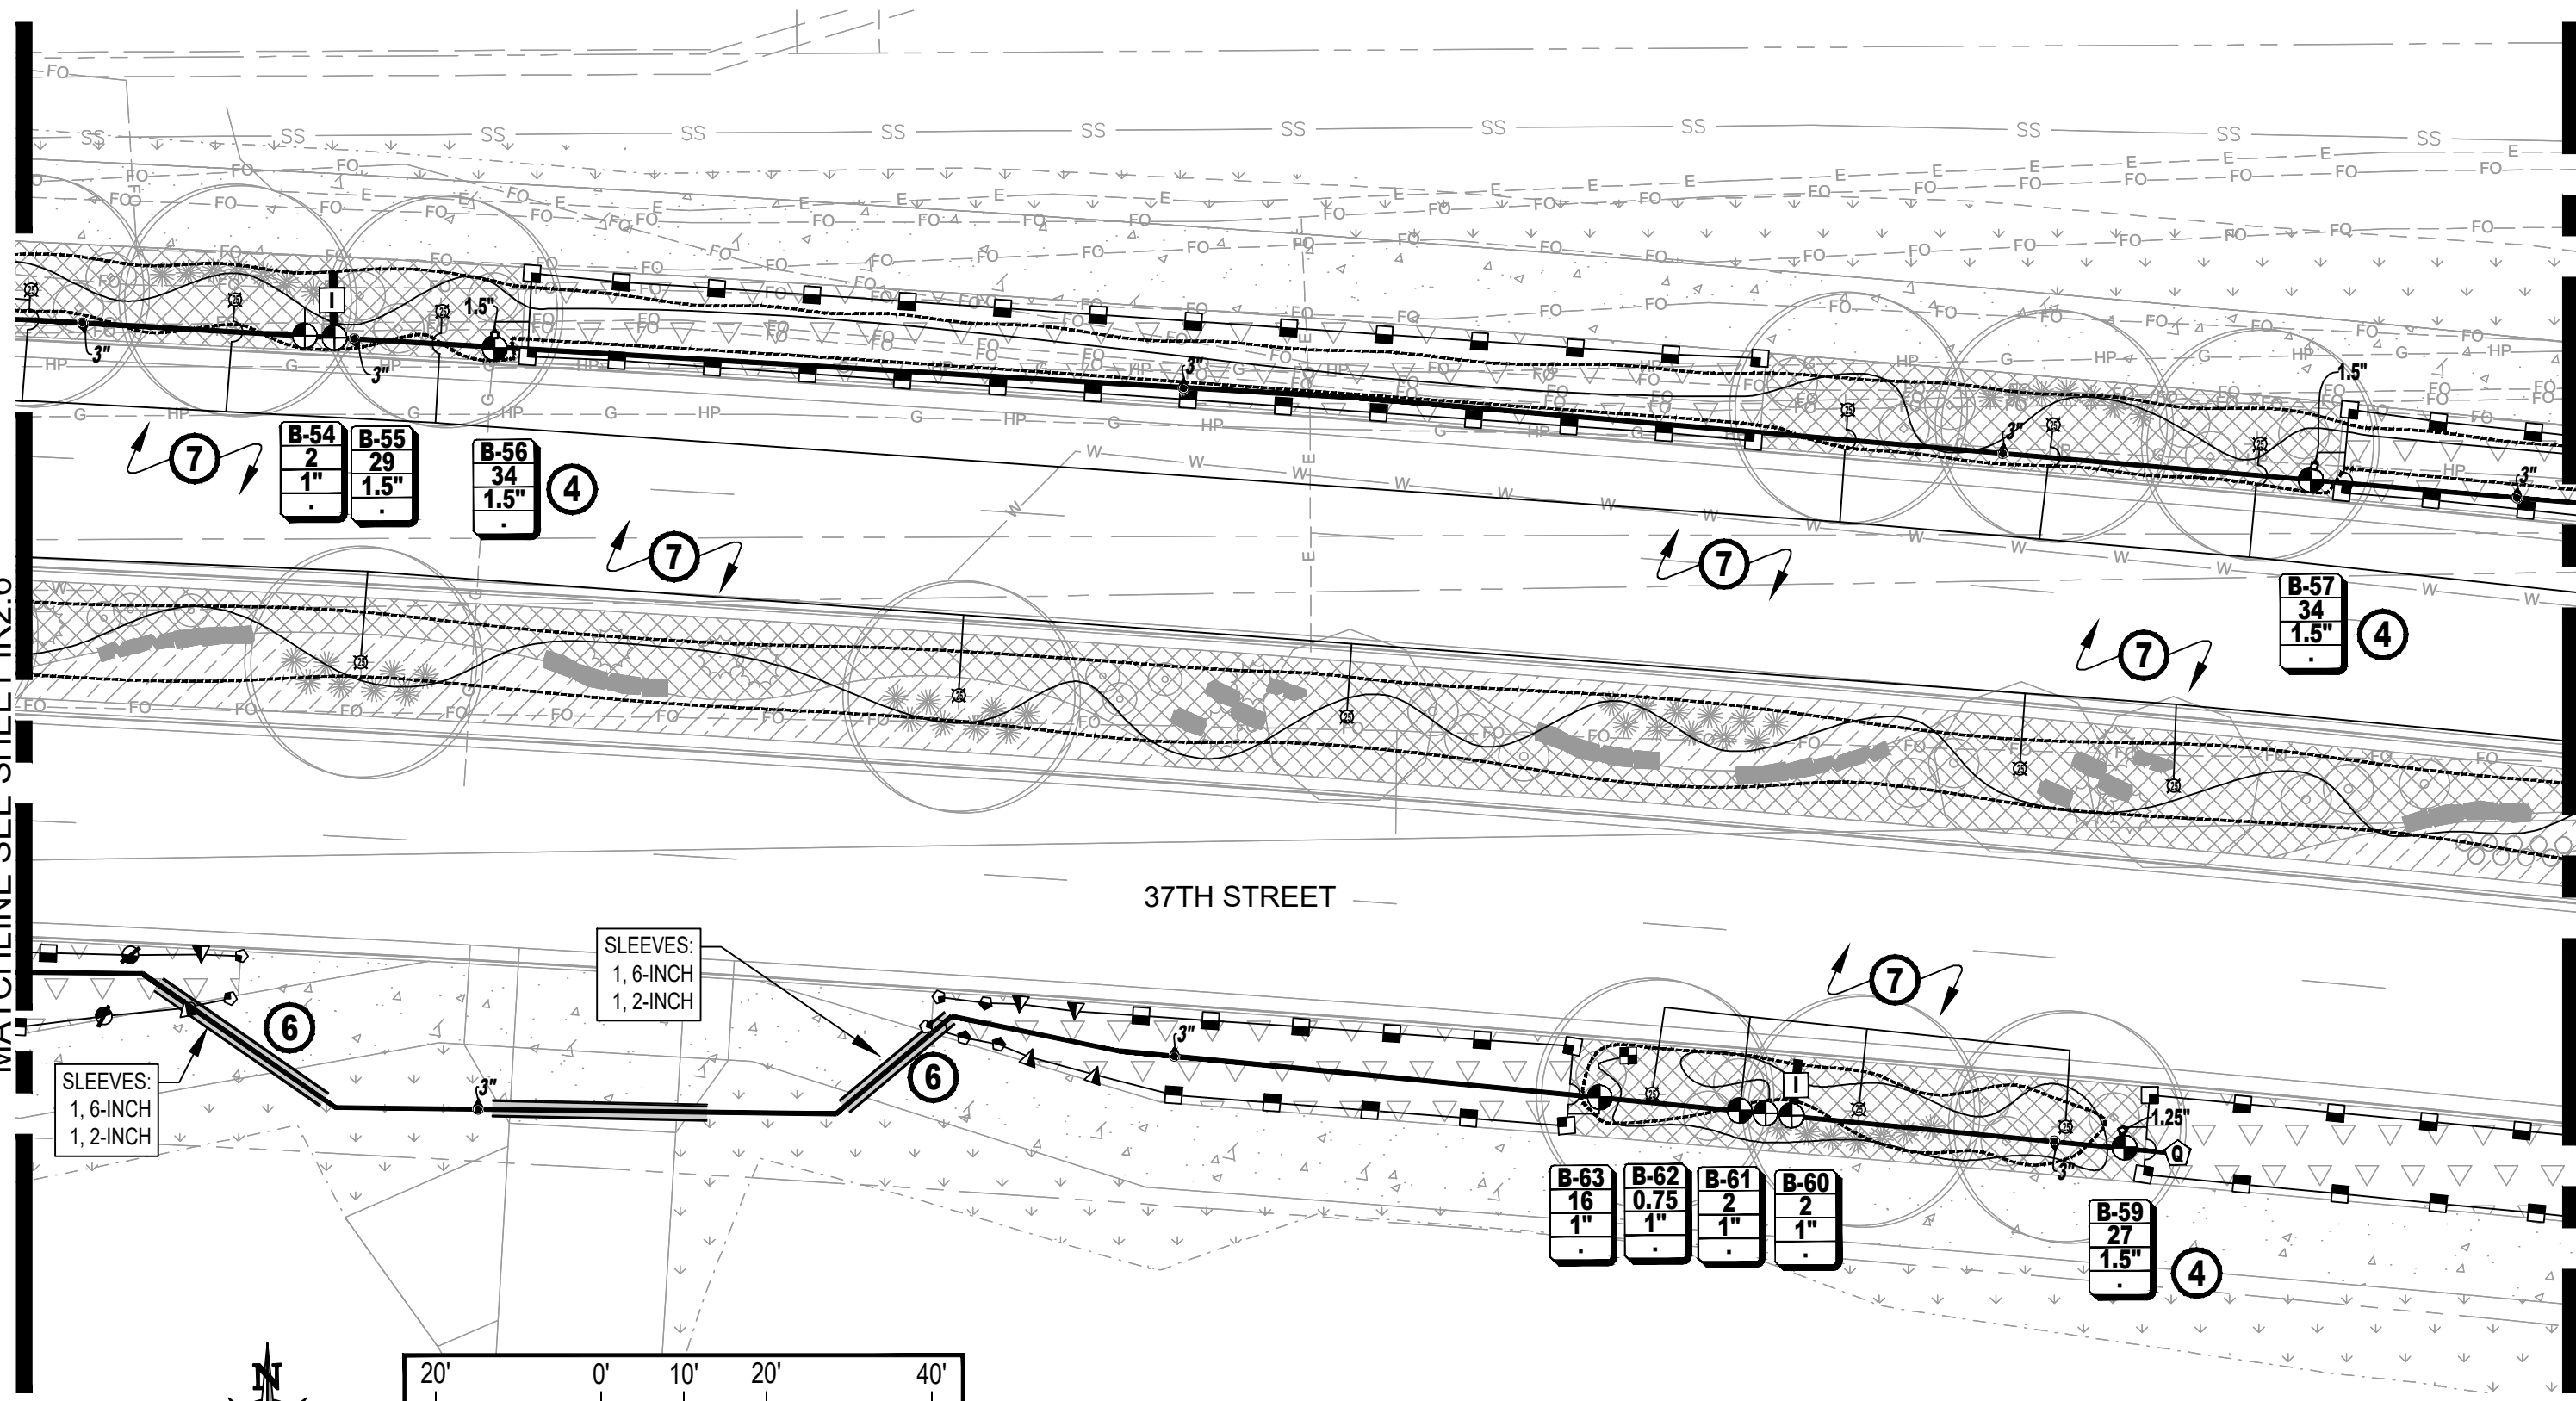
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PRIME CONSULTANT:	SUB CONSULTANT:
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Date:	Comments	Init.



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	Designer:	JHK	Structure Numbers	Drawing Number IR2.7
	Detailer:	JHK		
	Sheet Subset: IRRIGATION	Subset Sheets: 9 of 18		Sheet Number 106

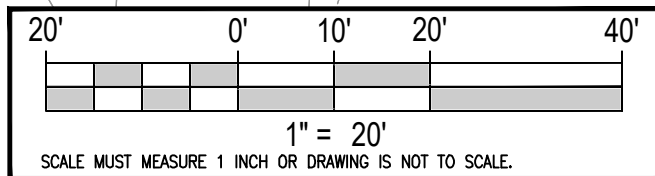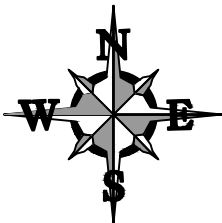MATCHLINE SEE SHEET IR2.6




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AD PLANS 3/26/2025

Plot Date: 11/22/2024 1:31 PM Plotted By: Jason H. Kautner
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MATCHLINE SEE SHEET IR2.7


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Sheet Revisions		
Date:	Comments	Init.





As Constructed	37TH STREET WIDENING PHASE 2B IRRIGATION PLAN			Project No.
No Revisions:				37TH STREET 2B
Revised:	Designer: JHK	Structure		Drawing Number IR2.8
	Detailer: JHK	Numbers		
Void:	Sheet Subset: IRRIGATION	Subset Sheets: 10 of 18		Sheet Number 107

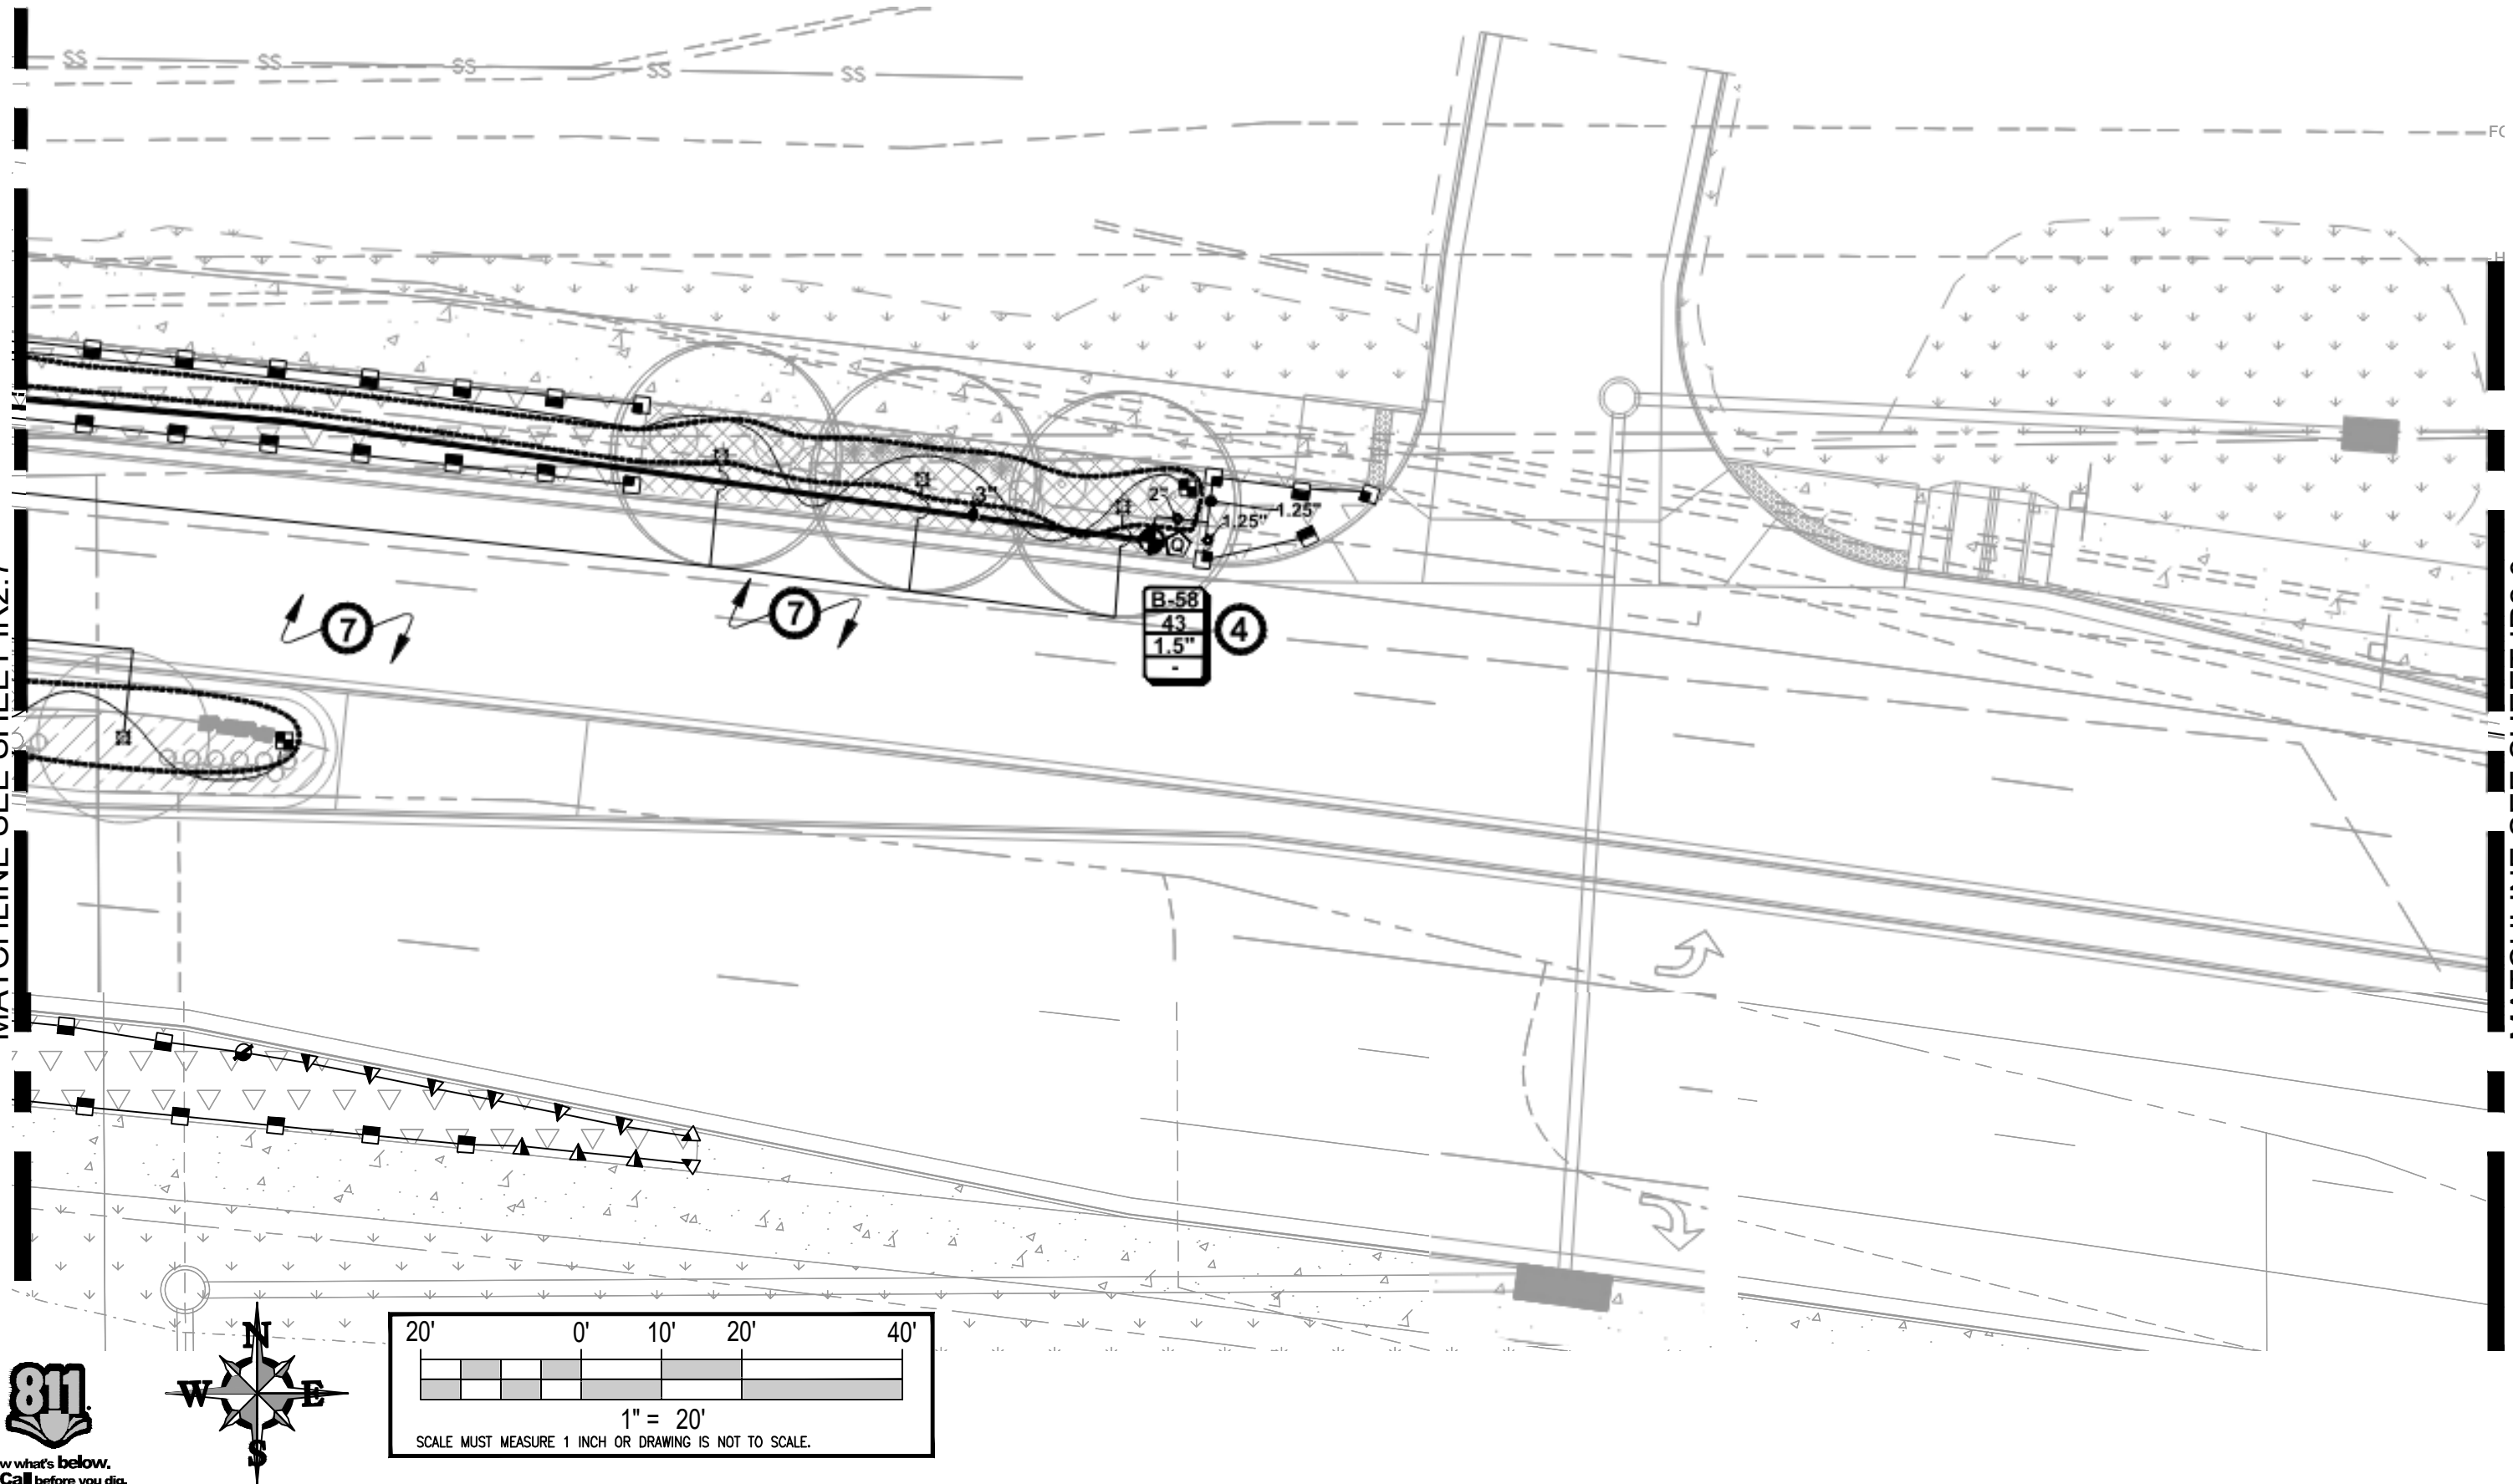Plot Date: 11/22/2022 1:31 PM, Plotted By: Jason H. Kowarsky
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MATCHLINE SEE SHEET IR2.8

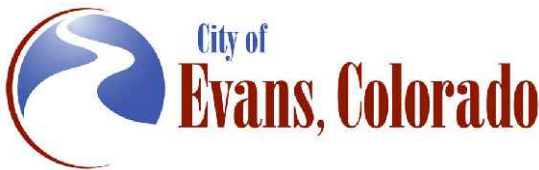


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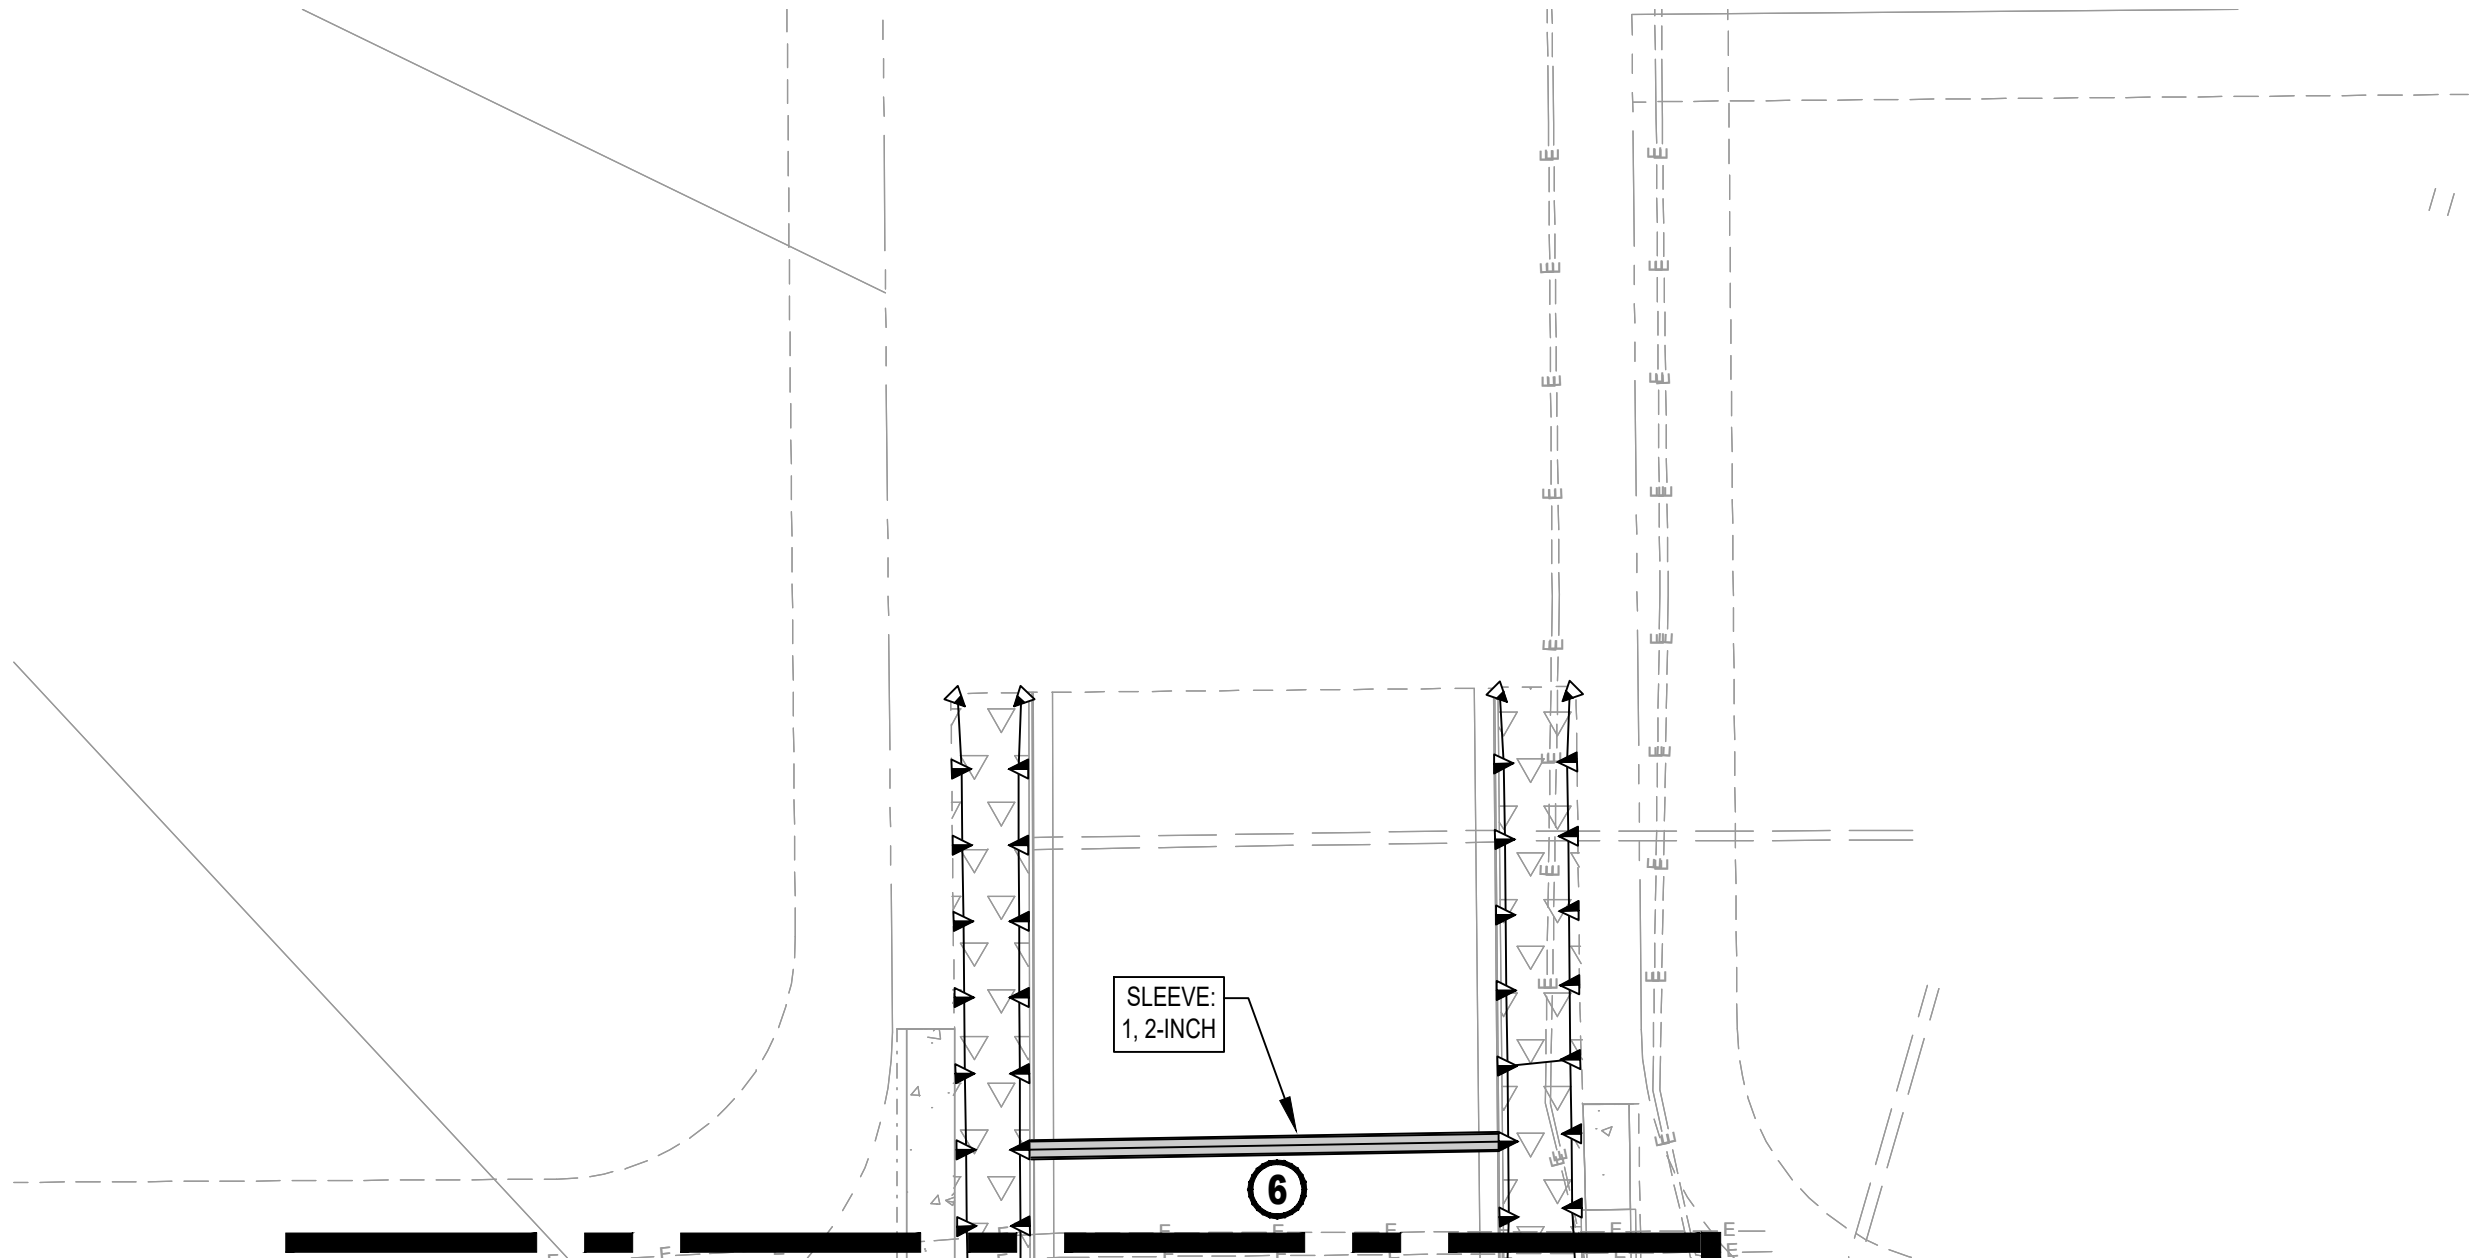


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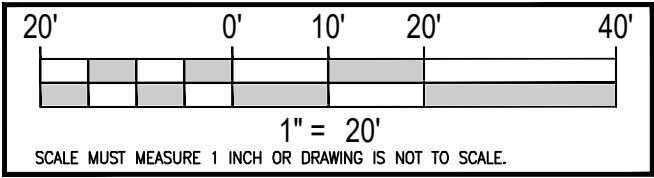
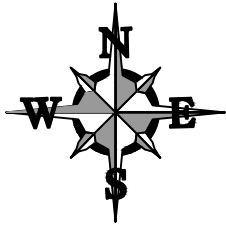

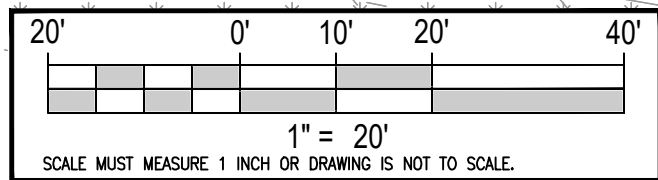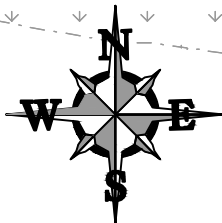
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	No Revisions:			37TH STREET 2B	
Revised:	Designer: JHK	Structure Numbers		Drawing Number	IR2.9
Void:	Detailer: JHK			Sheet Number	108
Sheet Subset: IRRIGATION		Subset Sheets: 11 of 18			

AD PLANS 3/26/2025

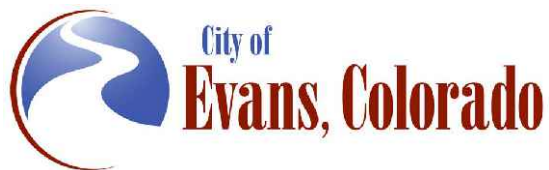

MATCHLINE SEE SHEET IR2.3




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Sheet Revisions

Date:	Comments	Init.



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Void:


37TH STREET WIDENING PHASE 2B
IRRIGATION PLAN

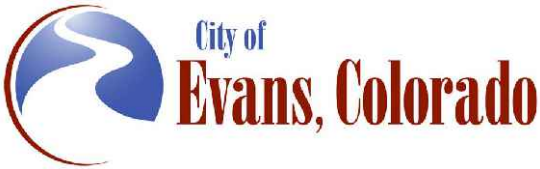Designer:	JHK	Structure	
Detailer:	JHK	Numbers	
Sheet Subset:	IRRIGATION	Subset Sheets:	12 of 18


Project No.
37TH STREET 2B
Drawing Number IR2.10
Sheet Number 109

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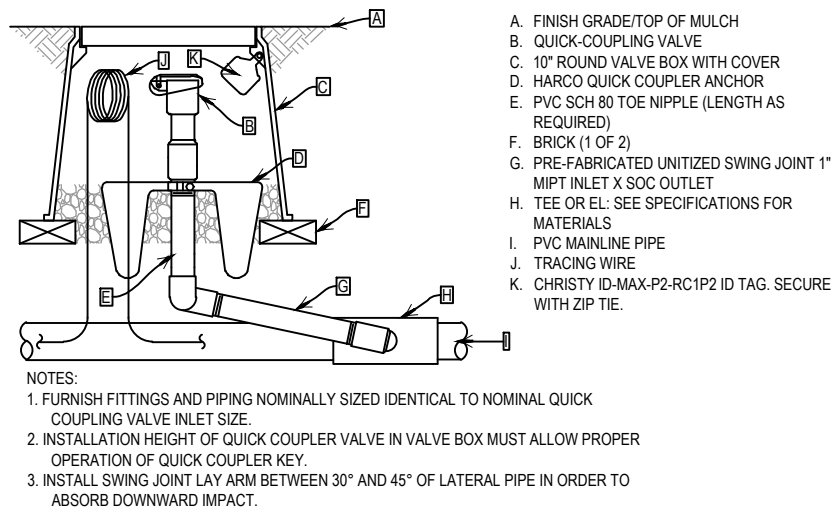
Plot Date: 11/22/2024 1:31 PM, Plotted By: Jason H. Kowarsky
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1 ISOLATION GATE VALVE ASSEMBLY (2.5" AND SMALLER) N.T.S.

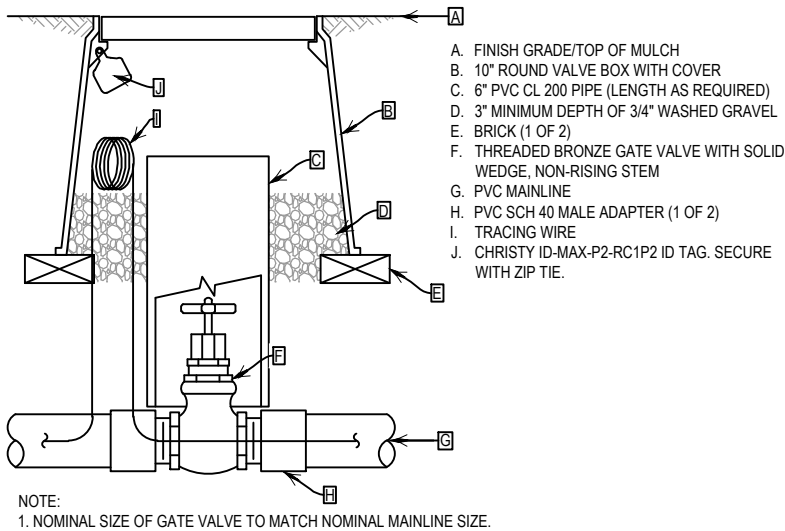

2 ISOLATION GATE VALVE ASSEMBLY (3" AND LARGER) N.T.S.

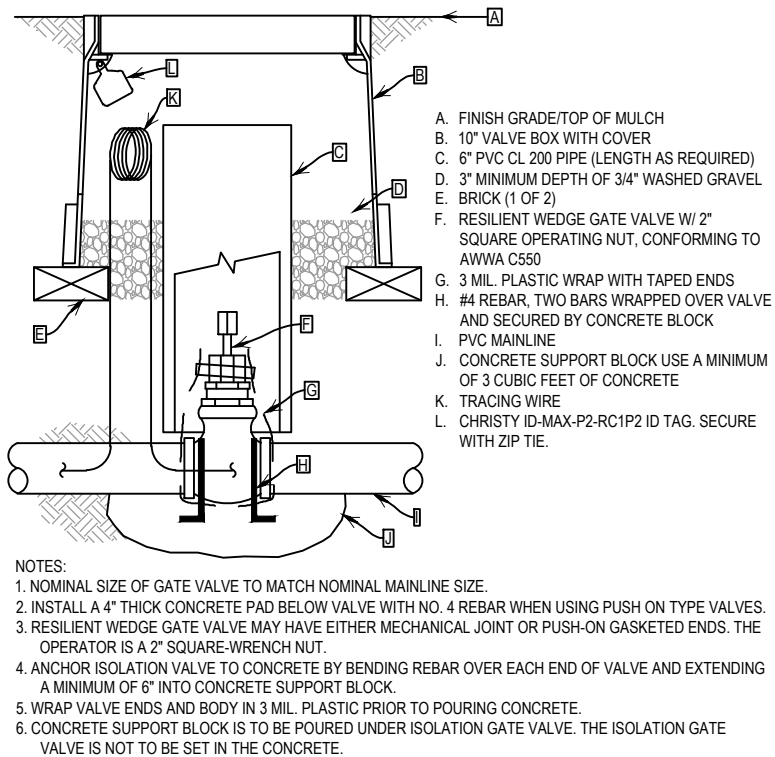


3 QUICK COUPLING VALVE ASSEMBLY N.T.S.




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Sheet Revisions			
Date:	Comments	Init.	



As Constructed	37TH STREET WIDENING PHASE 2B IRRIGATION DETAILS			Project No.
No Revisions:				37TH STREET 2B
Revised:	Designer: JHK	Structure Numbers		Drawing Number IR3.0
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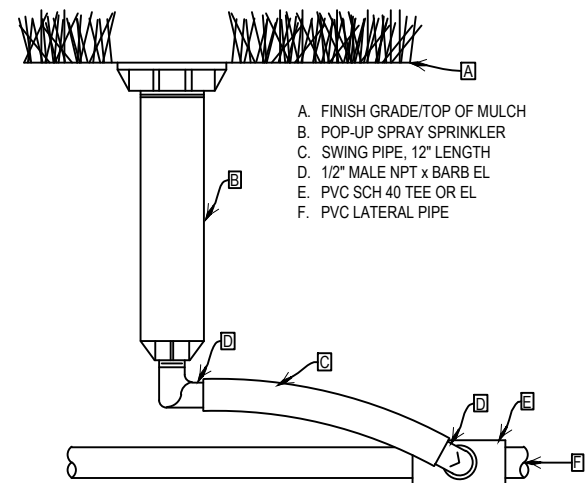


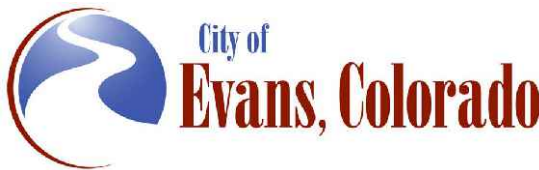- NOTES:
1. USE VALVE BOX EXTENSION AS NECESSARY TO ACHIEVE MINIMUM DIMENSIONS ABOVE ASSEMBLY.
 2. NOMINAL SIZE OF ALL COMPONENTS ARE TO BE THE SAME NOMINAL SIZE AS THE SOLENOID VALVE (SIZED AS SHOWN).
 3. INSTALL FILTER FABRIC AROUND EXTERIOR OF VALVE BOX. USE DUCT TAPE TO SECURE FABRIC TO PIPE AND VALVE BOX.
 4. TRANSITION TO PROPER LATERAL PIPE BURIAL DEPTH USING 45° ELBOW FITTINGS DOWNSTREAM OF REMOTE CONTROL VALVE ASSEMBLY.
 5. DO NOT CUT OUT ENDS OF VALVE BOX UNNECESSARILY.
 6. POSITION VALVE BOX OVER VALVE TO ALLOW ACCESS TO SOLENOID AND PROPER OPERATION OF BALL VALVE.
 7. COIL 3-FEET OF WIRE FOR EACH DECODER FOR SERVICE PURPOSES.

- A. DECODER
B. WIRE FROM DECODER TO VALVE SEE SPECIFICATIONS
C. PVC BALL VALVE
D. REMOTE CONTROL VALVE
E. WIRE CONNECTOR FROM TWO-WIRE CABLE TO DECODER (1 OF 2)
F. CHRISTY ID TAG
G. FINISH GRADE
H. PVC SCH 80 CLOSE NIPPLE
I. WIRE CONNECTOR FROM DECODER TO SOLENOID VALVE (1 OF 2)
J. PVC SCH 40 MALE ADAPTER
K. 12" STANDARD VALVE BOX WITH COVER
L. PVC LATERAL PIPE
M. FILTER FABRIC
N. PVC SCH 80 TOE NIPPLE (LENGTH AS REQUIRED)
O. PVC SCH 40 EL
P. PVC SCH 40 PIPE (LENGTH AS REQUIRED)
Q. BRICK (1 OF 4)
R. PVC MAINLINE
S. TWO-WIRE CABLE
T. 3" MINIMUM DEPTH OF 3/4" WASHED GRAVEL
U. TEE OR EL: SEE SPECIFICATIONS FOR MATERIALS
V. PVC SCH 80 TOE NIPPLE (LENGTH AS REQUIRED, HIDDEN) AND PVC SCH 40 EL
W. CHRISTY ID-MAX-P2-RC1P2 ID TAG. SECURE WITH ZIP TIE.

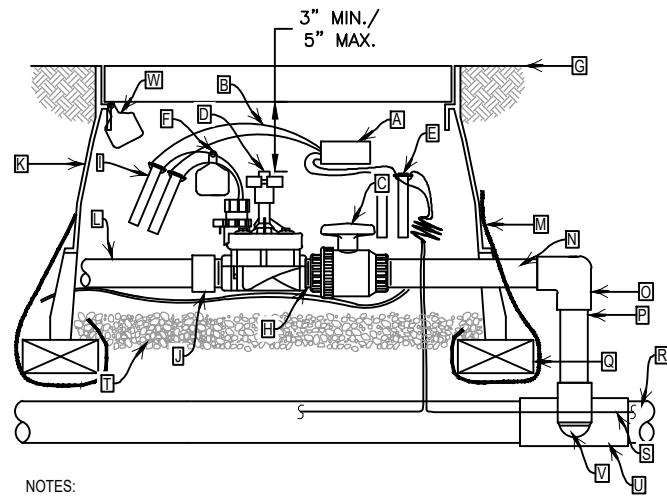1 REMOTE CONTROL VALVE ASSEMBLY

N.T.S.



- A. FINISH GRADE/TOP OF MULCH
B. POP-UP SPRAY SPRINKLER
C. SWING PIPE, 12" LENGTH
D. 1/2" MALE NPT x BARB EL
E. PVC SCH 40 TEE OR EL
F. PVC LATERAL PIPE

2 POP-UP SPRAY SPRINKLER ASSEMBLY


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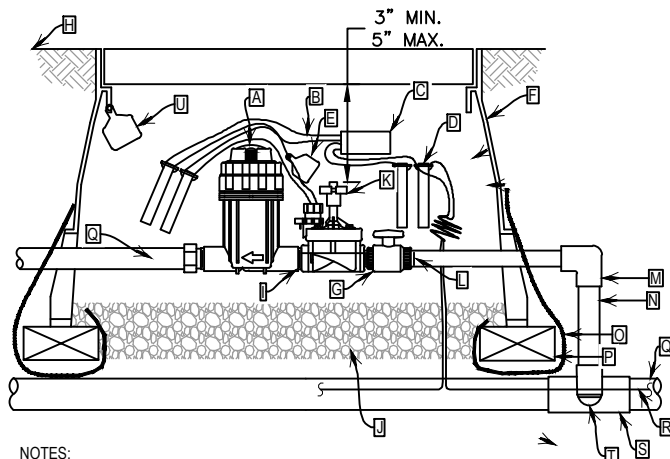
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Sheet Revisions			
Date:	Comments	Init.	




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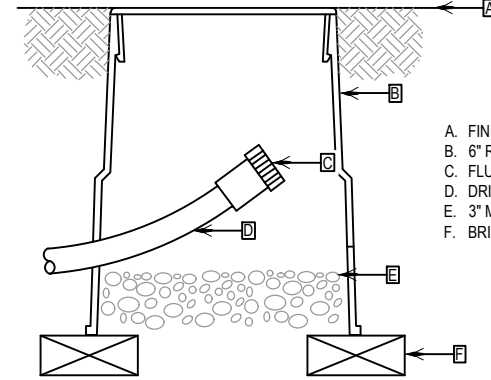


- NOTES:
- 1. USE VALVE BOX EXTENSION AS NECESSARY TO ACHIEVE MINIMUM DIMENSIONS ABOVE ASSEMBLY.
 - 2. NOMINAL SIZE OF ALL COMPONENTS ARE TO BE THE SAME NOMINAL SIZE AS THE SOLENOID VALVE (SIZED AS SHOWN).
 - 3. INSTALL FILTER FABRIC AROUND EXTERIOR OF VALVE BOX. USE DUCT TAPE TO SECURE FABRIC TO PIPE AND VALVE BOX.
 - 4. TRANSITION TO PROPER LATERAL PIPE BURIAL DEPTH USING 45° ELBOW FITTINGS DOWNSTREAM OF REMOTE CONTROL VALVE ASSEMBLY.
 - 5. DO NOT CUT OUT ENDS OF VALVE BOX UNNECESSARILY.
 - 6. POSITION VALVE BOX OVER VALVE TO ALLOW ACCESS TO SOLENOID, AND PROPER OPERATION OF BALL VALVE.
 - 7. COIL 3- FEET OF WIRE FOR EACH DECODER FOR SERVICE PURPOSES.
 - 8. IN CASES OF DIRECT DRIP LATERAL PIPE CONNECTION INSTALL SCH. 40 PVC BARB FITTING TO PRESSURE REGULATING BASKET. SECURE CONNECTION WITH STAINLESS STEEL PINCH CLAMPS.
 - 9. SEE DECODER GROUNDING SCHEMATIC FOR ADDITIONAL DECODER GROUNDING INFORMATION.

- A. PRESSURE REGULATING FILTER
- B. WIRE FROM DECODER TO VALVE SEE SPECIFICATIONS
- C. DECODER
- D. WIRE CONNECTOR FROM TWO-WIRE CABLE TO DECODER (1 OF 2)
- E. CHRISTY I.D. TAG
- F. JUMBO VALVE BOX WITH COVER
- G. PVC BALL VALVE
- H. FINISH GRADE/TOP OF MULCH
- I. PVC SCH 80 NIPPLE
- J. 3" MINIMUM DEPTH OF 3/4" WASHED GRAVEL
- K. REMOTE CONTROL VALVE
- L. PVC SCH 80 TOE NIPPLE
- M. PVC SCH 40 EL
- N. PVC SCH 40 PIPE (TYPICAL) (LENGTH AS REQUIRED)
- O. FILTER FABRIC
- P. BRICK (1 OF 4)
- Q. MANIFOLD/DRIP LATERAL. SEE NOTE 8.
- R. TWO-WIRE CABLE
- S. TEE OR EL: SEE SPECIFICATIONS FOR MATERIALS
- T. PVC SCH 80 TOE NIPPLE (LENGTH AS REQUIRED, HIDDEN) AND PVC SCH 40 EL
- U. CHRISTY ID-MAX-P2-RC1P2 ID TAG. SECURE WITH ZIP TIE.

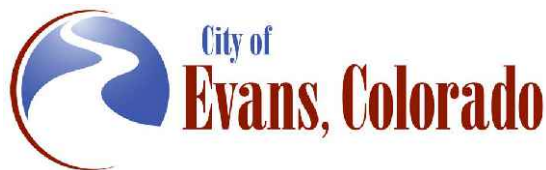

- A. 6" ROUND VALVE BOX WITH COVER
- B. FINISH GRADE/TOP OF MULCH
- C. PVC SCH. 40 EL
- D. PVC BALL VALVE
- E. PVC SCH. 40 TRANSITION NIPPLE (MIPTxMHT)
- F. COMPRESSIONx FEMALE HOSE SWIVEL ADAPTER
- G. DRIP LATERAL PIPING
- H. 3" MINIMUM DEPTH OF 3/4" WASHED GRAVEL
- I. BRICK (1 OF 2)
- J. PVC SCH 80 NIPPLE (LENGTH AS REQUIRED, 1 OF 2)
- K. PVC SCH 40 EL
- L. PVC SCH 40 STREET EL (1 OF 2)
- M. PVC DRIP MANIFOLD PIPE
- N. PVC SCH 40 TEE OR EL
- O. PVC SCH 80 NIPPLE (LENGTH AS REQUIRED)

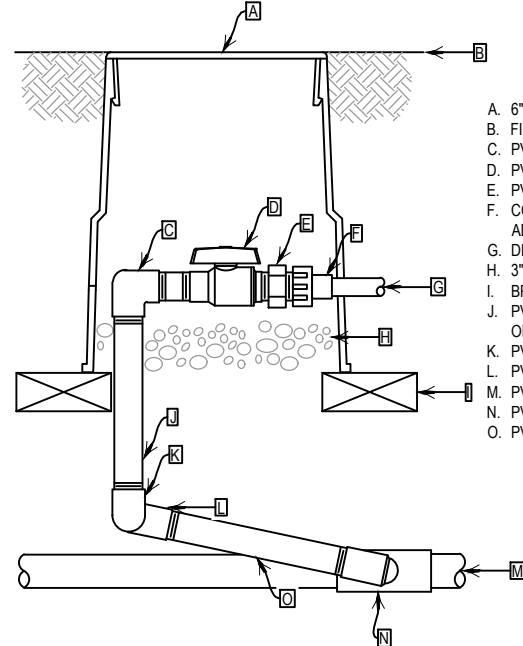

- NOTE:
- 1. INSTALL FLUSH CAP ASSEMBLY AT THE END OF EACH DRIP LATERAL SEGMENT.

1 DRIP REMOTE CONTROL VALVE ASSEMBLY

2 ZONE CONTROL VALVE ASSEMBLY

3 FLUSH CAP ASSEMBLY



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Date:	Comments	Init.	

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No Revisions:					37TH STREET 2B
Revised:	Designer: JHK	Structure Numbers			Drawing Number IR3.2
Void:	Detailer: JHK				
	Sheet Subset: IRRIGATION	Subset Sheets: 15 of 18			Sheet Number 112


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Plot Date: 11/22/2022 1:31 PM, Plotted By: Jason H. Kowarsky
D:\WA\EVANS-STREET\PHASE 2B\1-Phase 2B.DWG

1

POINT SOURCE DRIP EMITTER
PLACEMENT

N.T.S.

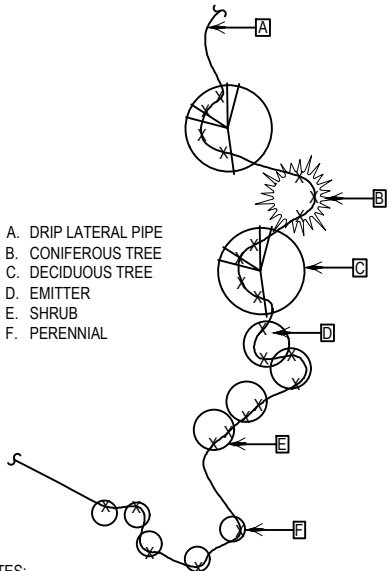


- NOTES:
1. EMITTERS SHALL BE LOCATED IMMEDIATELY ADJACENT TO PERENNIALS AND AT THE OUTSIDE PERIMETER OF THE PLANTING PIT OF ALL SHRUBS AND TREES.
 2. INSTALL FOUR 1 GPH EMITTERS PER DECIDUOUS TREE.
 3. INSTALL THREE 1 GPH EMITTER PER CONIFEROUS TREE.
 4. INSTALL TWO 1 GPH EMITTER PER SHRUB.
 5. INSTALL ONE 1 GPH EMITTER PER PERENNIAL.

2

INLINE DRIP RING
ASSEMBLY

N.T.S.

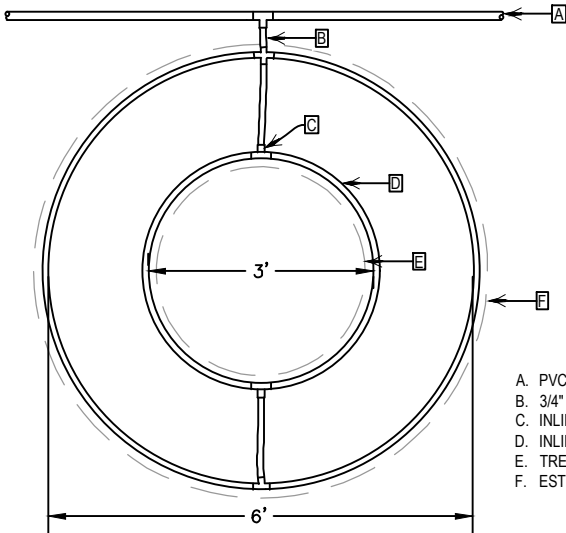


- NOTE:
1. PROVIDE A 3-FT AND 6-FT DIAMETER RING OF INLINE DRIP TUBING AROUND EACH TREE ROOTBALL. TOTAL ESTIMATED FLOW PER TREE IS 0.4 GPM.
 2. INSTALL INLINE DRIP TUBING 4" BELOW GRADE AROUND EACH TREE.

- A. PVC PIPE
B. 3/4" POLYETHYLENE PIPE
C. INLINE DRIP TUBING TEE FITTING
D. INLINE DRIP TUBING
E. TREE ROOTBALL
F. ESTIMATED DRIPLINE OF TREE

3

INLINE DRIP TO TREES
LAYOUT

N.T.S.

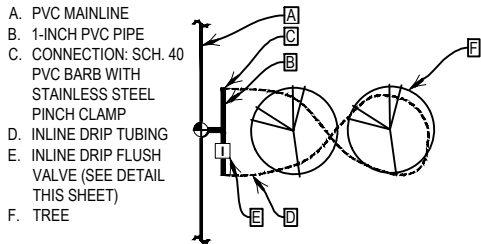

- NOTES:
1. 1-INCH PVC PIPE TO BE 12-INCHES BELOW GRADE.
 2. INLINE DRIP TUBING TO BE 4-INCHES BELOW GRADE.

- A. PVC MAINLINE
B. 1-INCH PVC PIPE
C. CONNECTION: SCH. 40
PVC BARB WITH
STAINLESS STEEL
PINCH CLAMP
D. INLINE DRIP TUBING
E. INLINE DRIP FLUSH
VALVE (SEE DETAIL
THIS SHEET)
F. TREE




Know what's below.
Call before you dig.

Print Date: 11/22/2022	
File Name:	
Horiz. Scale: As Noted	Vert. Scale: As Noted
PRIME CONSULTANT:	SUB CONSULTANT:
 RockSol Consulting Group, Inc.	 Aqua Engineering Innovative Water Solutions




Sheet Revisions		
Date:	Comments	Init.

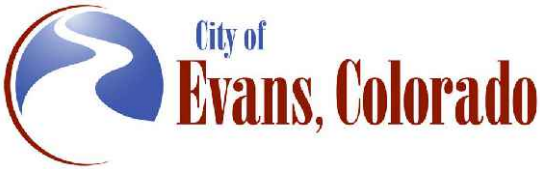

As Constructed	37TH STREET WIDENING PHASE 2B IRRIGATION DETAILS			Project No.
No Revisions:				37TH STREET 2B
Revised:	Designer: JHK	Structure Numbers		Drawing Number IR3.3
Void:	Detailer: JHK			Sheet Number 113
	Sheet Subset: IRRIGATION	Subset Sheets: 16 of 18		

-
- A technical drawing of a mechanical device, possibly a pump or a motor assembly, shown in a cross-sectional view. The device is mounted on a base (E) and features a central shaft (D) with a handle (I) and a motor unit (J). The motor unit is connected to a drive shaft (A) and a pulley (B). The device is supported by two vertical legs (F) which are anchored into a base (E). The base is filled with a material (G) and has a top cover (C) and a side cover (A). The entire assembly is shown in a cross-sectional view with hatching indicating different materials.

1 INLINE DRIP FLUSH VALVE ASSEMBLY

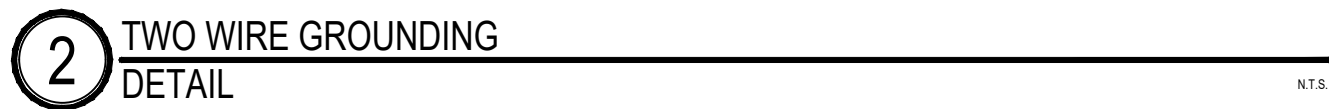

1 INLINE DRIP FLUSH VALVE ASSEMBLY

2 TWO WIRE GROUNDING DETAIL



Print Date: 11/22/2022		<div><div></div><div></div><div></div><div></div><div></div></div>	Sheet Revisions			<div><div><div></div><div></div></div><div>City of Evans, Colorado</div><div><div><div></div><div></div><div></div></div><div>FREEDOM Parkway</div></div></div>	As Constructed		37TH STREET WIDENING PHASE 2B IRRIGATION DETAILS			Project No.	
File Name:			Date:	Comments	Init.		No Revisions:					37TH STREET 2B	
Horiz. Scale: As Noted Vert. Scale: As Noted							Revised:		Designer: JHK	Structure Numbers	Drawing Number IR3.4		
PRIME CONSULTANT: SUB CONSULTANT:							Detailer: JHK						
<div><div><div></div><div>RockSol</div><div>Consulting Group, Inc.</div></div><div><div><div></div><div>Aqua Engineering</div><div>Inc.</div><div>1000 Southpark Drive, Unit 40</div><div>Fort Collins, CO 80520-3503</div><div>970.220.8880</div><div>www.aquaengineering.com</div></div></div></div>							Void:		Sheet Subset: IRRIGATION		Subset Sheets: 17 of 18		Sheet Number 114

Plot Date: 11/22/2024 1:31 PM, Plotted By: Jason H. Kowarsky
D:\BA EVANS-37TH\PHASE 2B\PHASE 2B.DWG



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Print Date: 11/22/2022

File Name:

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PRIME CONSULTANT:

SUB CONSULTANT:



Sheet Revisions

Date:	Comments	Init.



City of
Evans, Colorado



As Constructed

No Revisions:

Revised:

Void:

37TH STREET WIDENING PHASE 2B
IRRIGATION DETAILS

Designer: JHK

Detailer: JHK

Sheet Subset: IRRIGATION

Structure

Numbers


Subset Sheets: 18 of 18

Project No.

37TH STREET 2B

Drawing Number IR3.5


Sheet Number 115

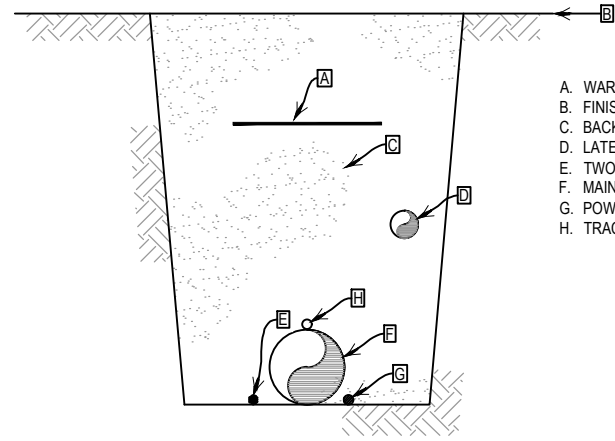

NOTE:
1. REFER TO IRRIGATION SPECIFICATIONS FOR COVERAGE
DEPTH TO BURIED PIPE AND WIRE.

1 TRENCH DETAIL


N.T.S.

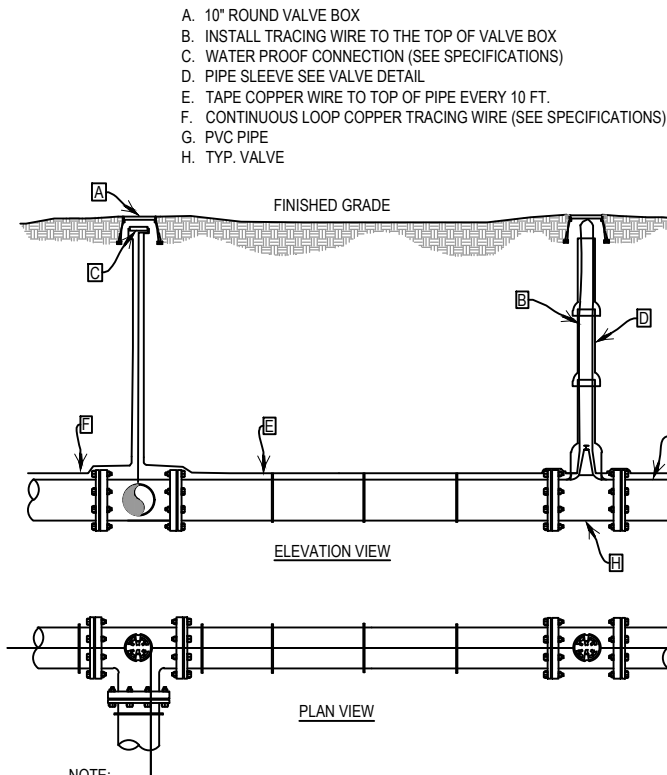

NOTE:
1. COPPER TRACING WIRE WILL START AT THE MASTER VALVE AND WILL BE ROUTED
WITH ALL MAINLINE PIPE.
2. SPLICE TRACING WIRE IN IRRIGATION MAINLINE COMPONENT VALVE BOXES WHEN
POSSIBLE, OTHERWISE, PLACE SPLICE IN SEPARATE VALVE BOX.

2 TRACING WIRE DETAIL

N.T.S.

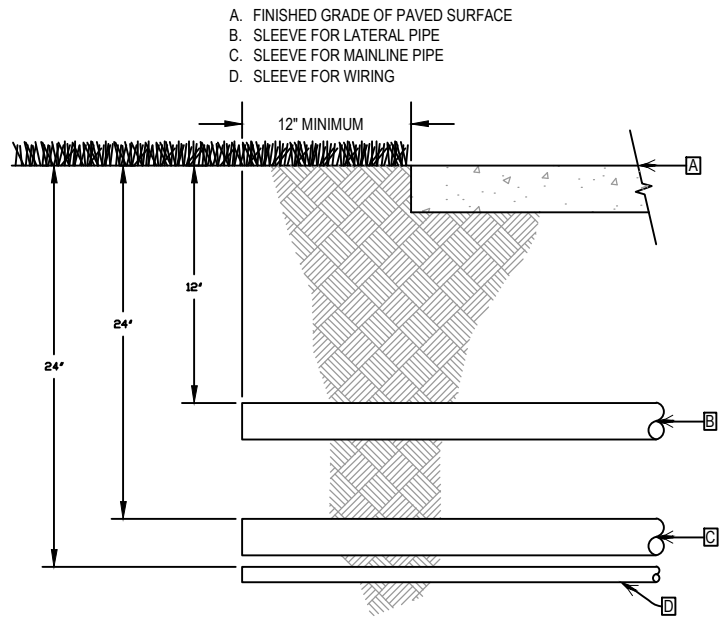

NOTE:
1. INSTALL SLEEVE SO THAT ITS LOWEST ELEVATION OCCURS AT ONE OR BOTH ENDS - NOT
ALONG ITS LENGTH.

3 SLEEVE DETAIL

N.T.S.

37TH STREET CONSTRUCTION PHASING

CONSTRUCTION PHASING GENERAL NOTES:

The Contractor shall prepare and submit a Traffic Control Plan (TCP) prior to starting. The TCP shall be submitted to the City of Evans’ Project Engineer for review and approval no less than five business days prior to starting construction.

The TCP shall conform to the requirements of Part 6 of the Manual on Uniform Traffic Control Devices (MUTCD), 2009 Edition, and the Colorado Department of Transportation M & S Standard Plans, 2019 (S–630–1 and S–630–2).

Project requirements include:

- 1. All construction work that will be in traffic lanes or affect the flow of traffic shall be completed between the hours of 9:00 AM and 4:00 PM Monday through Friday. Construction work that will not affect traffic shall be completed between the hours of 7:00 AM and 7:00 PM.
- 2. There shall be no work performed on weekends or holidays except by approval of the City of Evans with a minimum of 24 hours notice.
- 3. It is the Contractor’s responsibility to provide a safe traveled way for vehicular traffic traveling through the construction zone and within the clear zone of the excavated area.
- 4. Unless otherwise approved by the Engineer, the Contractor’s equipment shall follow normal and legal traffic movements. The Contractor’s ingress and egress of the work area shall be accomplished with as little disruption to traffic as possible. Traffic control devices shall be removed by picking up the devices in a reverse sequence to that used for installation. This may require moving backwards through the work zone, but is limited to within the lane or shoulder closures. When located behind or at other locations shown on approved traffic control plans, equipment may operate in a direction opposite to adjacent traffic.
- 5. The Contractor shall not have construction equipment or materials in the lanes open to traffic at any time, unless approved by the Engineer.
- 6. All travel lanes shall be a minimum of 11’ wide.
- 7. The Contractor shall maintain traffic flow and allow access to homes, businesses, and side streets at all times. The Contractor shall provide temporary ramping and use flaggers when necessary.
- 8. The Contractor should coordinate any temporary closures to homes or businesses with the owners.
- 9. Signal construction will need to be coordinated in each phase.

The construction sequence described below and shown on the plans is a potential sequence available for the Contractor’s use. It is a general concept and is provided for information only. Not all construction details have been addressed. The Contractor is in no way obliged to employ the methods or sequences of construction outlined in the phasing plans. Any variation in phasing must be approved before construction begins.

PHASE 1

- 1. Use existing pavement, and pavement markings for Phase 1 traffic.
- 2. All temporary construction signs and traffic control devices shall be placed according to an approved MHT before beginning construction.
- 3. Construct proposed Phase 1 utility improvements. See utility plans.
- 4. Construct proposed hydraulic improvements.
- 5. Construct proposed eastbound lanes, and apply temporary pavement markings for Phase 2 construction.
- 6. Construct curb and gutter on south side of roadway.
- 7. Construct parkway and sidewalks, including ADA ramps on south side of roadway.

PHASE 2

- 1. Shift traffic to new pavement as shown in Phase 2 drawings.
- 2. All temporary construction signs and traffic control devices shall be placed according to an approved MHT before beginning construction.
- 3. Construct proposed Phase 2 utility improvements under Phase 2 roadway. See utility plans.
- 4. Construct proposed westbound lanes, and apply permanent pavement markings for final traffic configuration.
- 5. Construct median island and turn lanes, see median detail.
- 6. Construct curb and gutter on north side of roadway.
- 7. Construct parkway and sidewalks, including ADA ramps on north side of roadway.



TABULATION OF TEMPORARY TRAFFIC CONTROL SIGNING			
SIGN	DESCRIPTION	DIMENSION	PANEL SIZE
			EACH
W20-1	ROAD WORK AHEAD	36" X 36"	6
G20-2	END ROAD WORK	36" X 18"	2
R2-1	SPEED LIMIT (30 MPH)	24" X 30"	6
R2-6aP	FINES DOUBLE (PLAQUE)	24" X 18"	6
R2-10	BEGIN FINES DOUBLE IN WORK ZONE	24" X 30"	2
R2-11	END FINES DOUBLE IN WORK ZONE	24" x 30"	2
W20-5L	LEFT LANE CLOSED	36" X 36"	1
W20-5R	RIGHT LANE CLOSED	36" X 36"	1
W20-7	FLAGGER (SYMBOLE)	36" X 36"	4
W4-2R	RIGHT LANE MERGE	36" X 36"	2
W4-2L	LEFT LANE MERGE	36" X 36"	2
G20-10	XYZ CONSTRUCTION THANKS YOU	24" X 30"	2
R9-9	SIDEWALK CLOSED	24" X 12"	4
TOTALS			40

TABULATION OF TRAFFIC CONTROL DEVICES			
ITEM	DESCRIPTION	UNIT	QUANTITY
630-00000	FLAGGING	HOURL	1000
630-00007	TRAFFIC CONTROL INSPECTION	DAY	36
630-00012	TRAFFIC CONTROL MANAGEMENT	DAY	90
630-80337	BARRICADE (TYPE 3M-C) (TEMPORARY)	EACH	6
630-80341	CONSTRUCTION TRAFFIC SIGN (PANEL SIZE A)	EACH	40
630-80342	CONSTRUCTION TRAFFIC SIGN (PANEL SIZE B)	EACH	15
630-80350	VERTICAL PANEL	EACH	50
630-80356	ADVANCE WARNING FLASHING OR SEQUENCING ARROW PANEL (A TYPE)	EACH	2
630-80360	DRUM CHANNELIZING DEVICE	EACH	200
630-80380	TRAFFIC CONE	EACH	100

Print Date: 5/2/2025

File Name: PH P2B-001 PHASING GENERAL NOTES.DWG

Horiz. Scale: N/A

Vert. Scale: N/A

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Sheet Revisions


Date	Comments	Initials

As Constructed	37TH STREET WIDENING PHASE 2B CONSTRUCTION PHASING TABULATIONS AND GENERAL NOTES	Project No.
No Revisions:		37TH STREET 2B
Revised:	Designer: B. DANE Detailer: B. DANE	Drawing Number PH-001
Void:	Sheet Subset: PHASING Subset Sheets: 1 of 4	Sheet Number 116


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FOR CONSTRUCTION 5/1/2025

Plot Date: 5/2/2025 6:51 AM Plotted By: Sarah Hemler
C:\G-PROJECTS\VAI\PROJECTS\33001\EVANS\37TH ST AND 47TH AVE PLAN\20_COMPUTER DESIGN FILES\PHASE 2B\PHASE 2B-001 PHASING TYPICAL SECTION.DWG

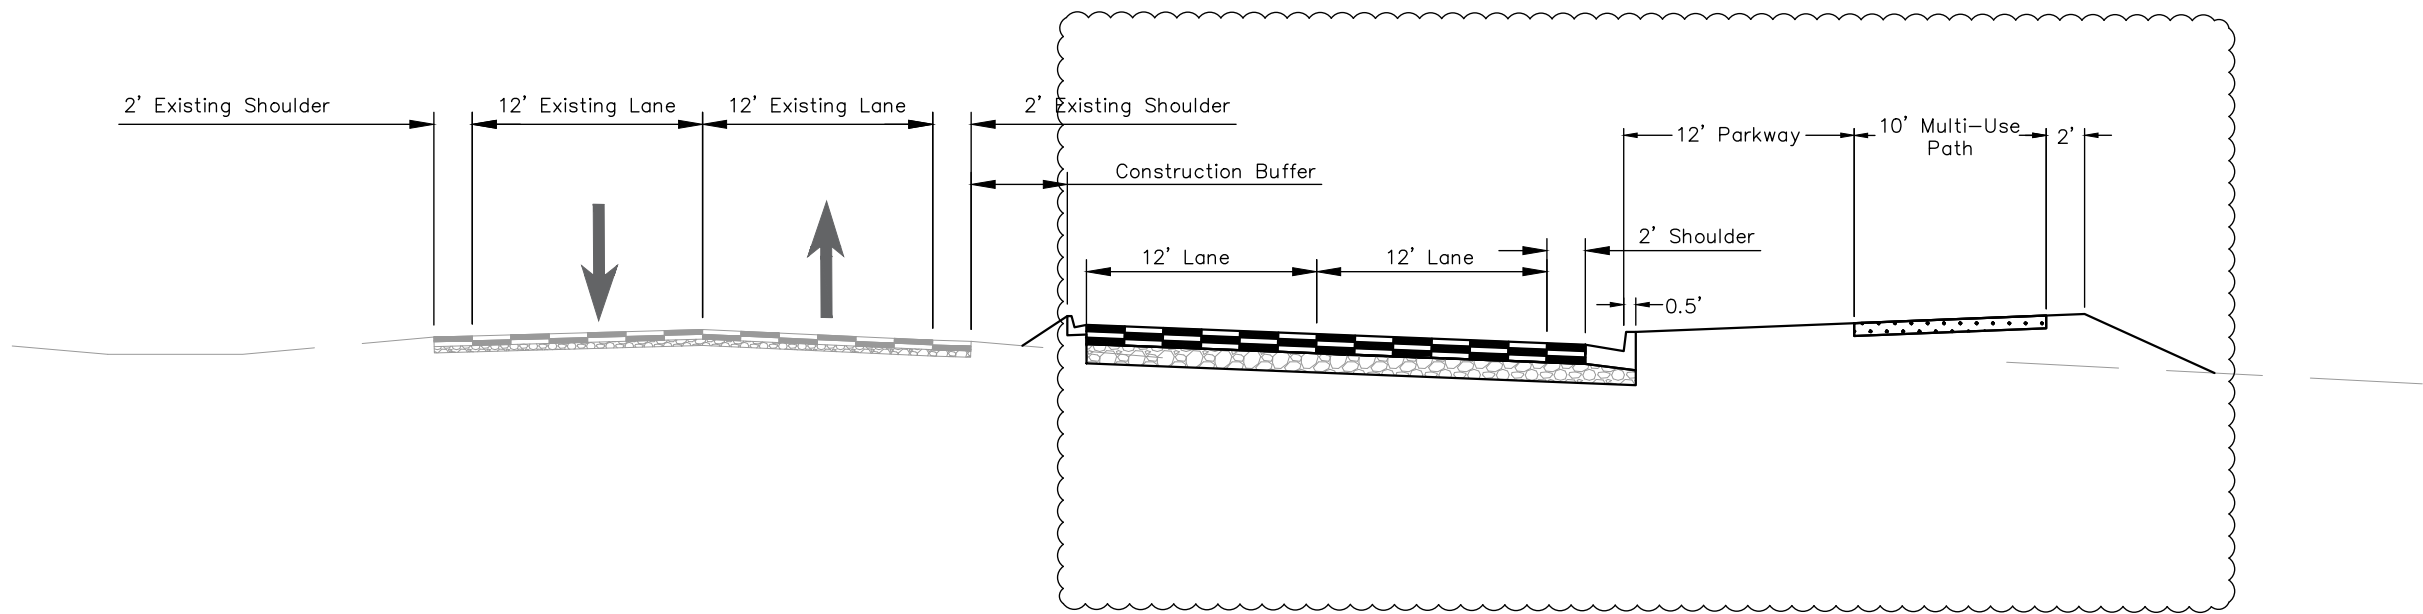

37th – Phase 1 Construction

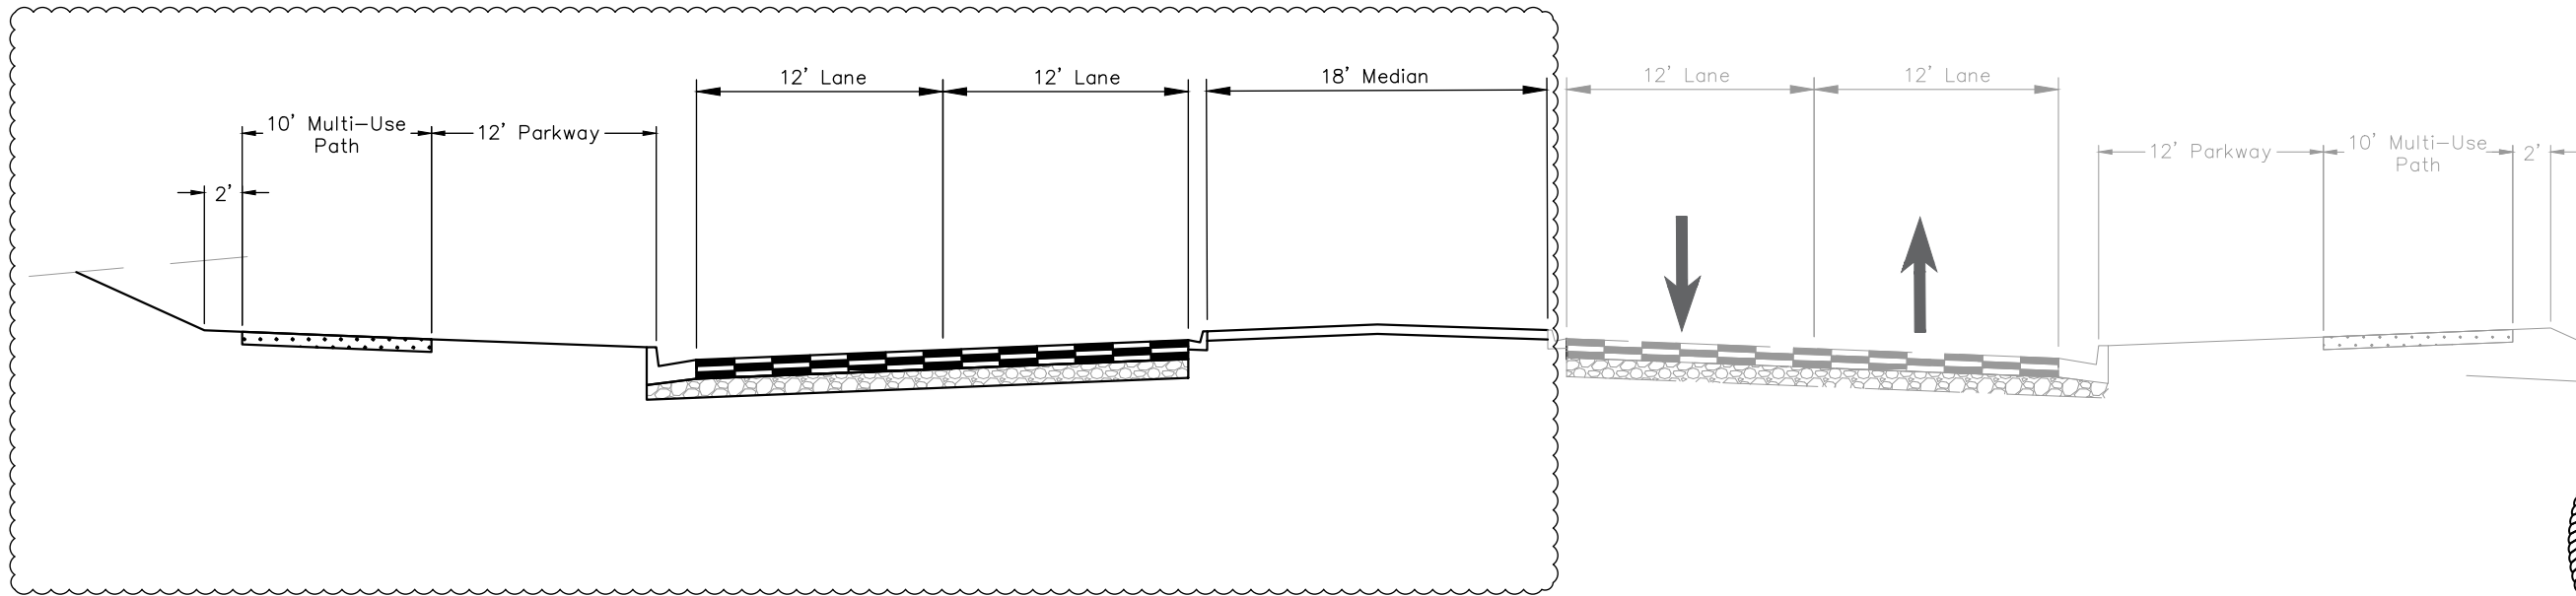


37th – Phase 2 Construction



Print Date: 5/2/2025	
File Name: PH P2B-001 PHASING TYPICAL SECTION.DWG	
Horiz. Scale: NTS	Vert. Scale: NTS
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	Ph: (303) 962-9300
	Fax: (303) 962-9350

Sheet Revisions		
Date:	Comments	Init.

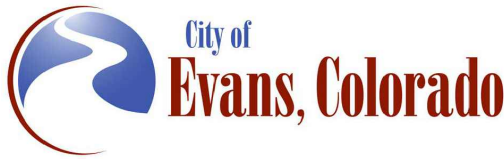

As Constructed	37TH STREET WIDENING PHASE 2B PHASING TYPICAL SECTION			Project No.
	No Revisions:	Designer: T. Tuttle	Structure Numbers	37TH STREET 2B
Revised:	Detailer: C. Peterson			Drawing Number PH-002
Void:	Sheet Subset: PHASING	Subset Sheets: 2 of 4		Sheet Number 117

Legend:


Construction Phase 1 -

Phase 1 Traffic -

Traffic Direction -

0 50 100

SCALE IN FEET

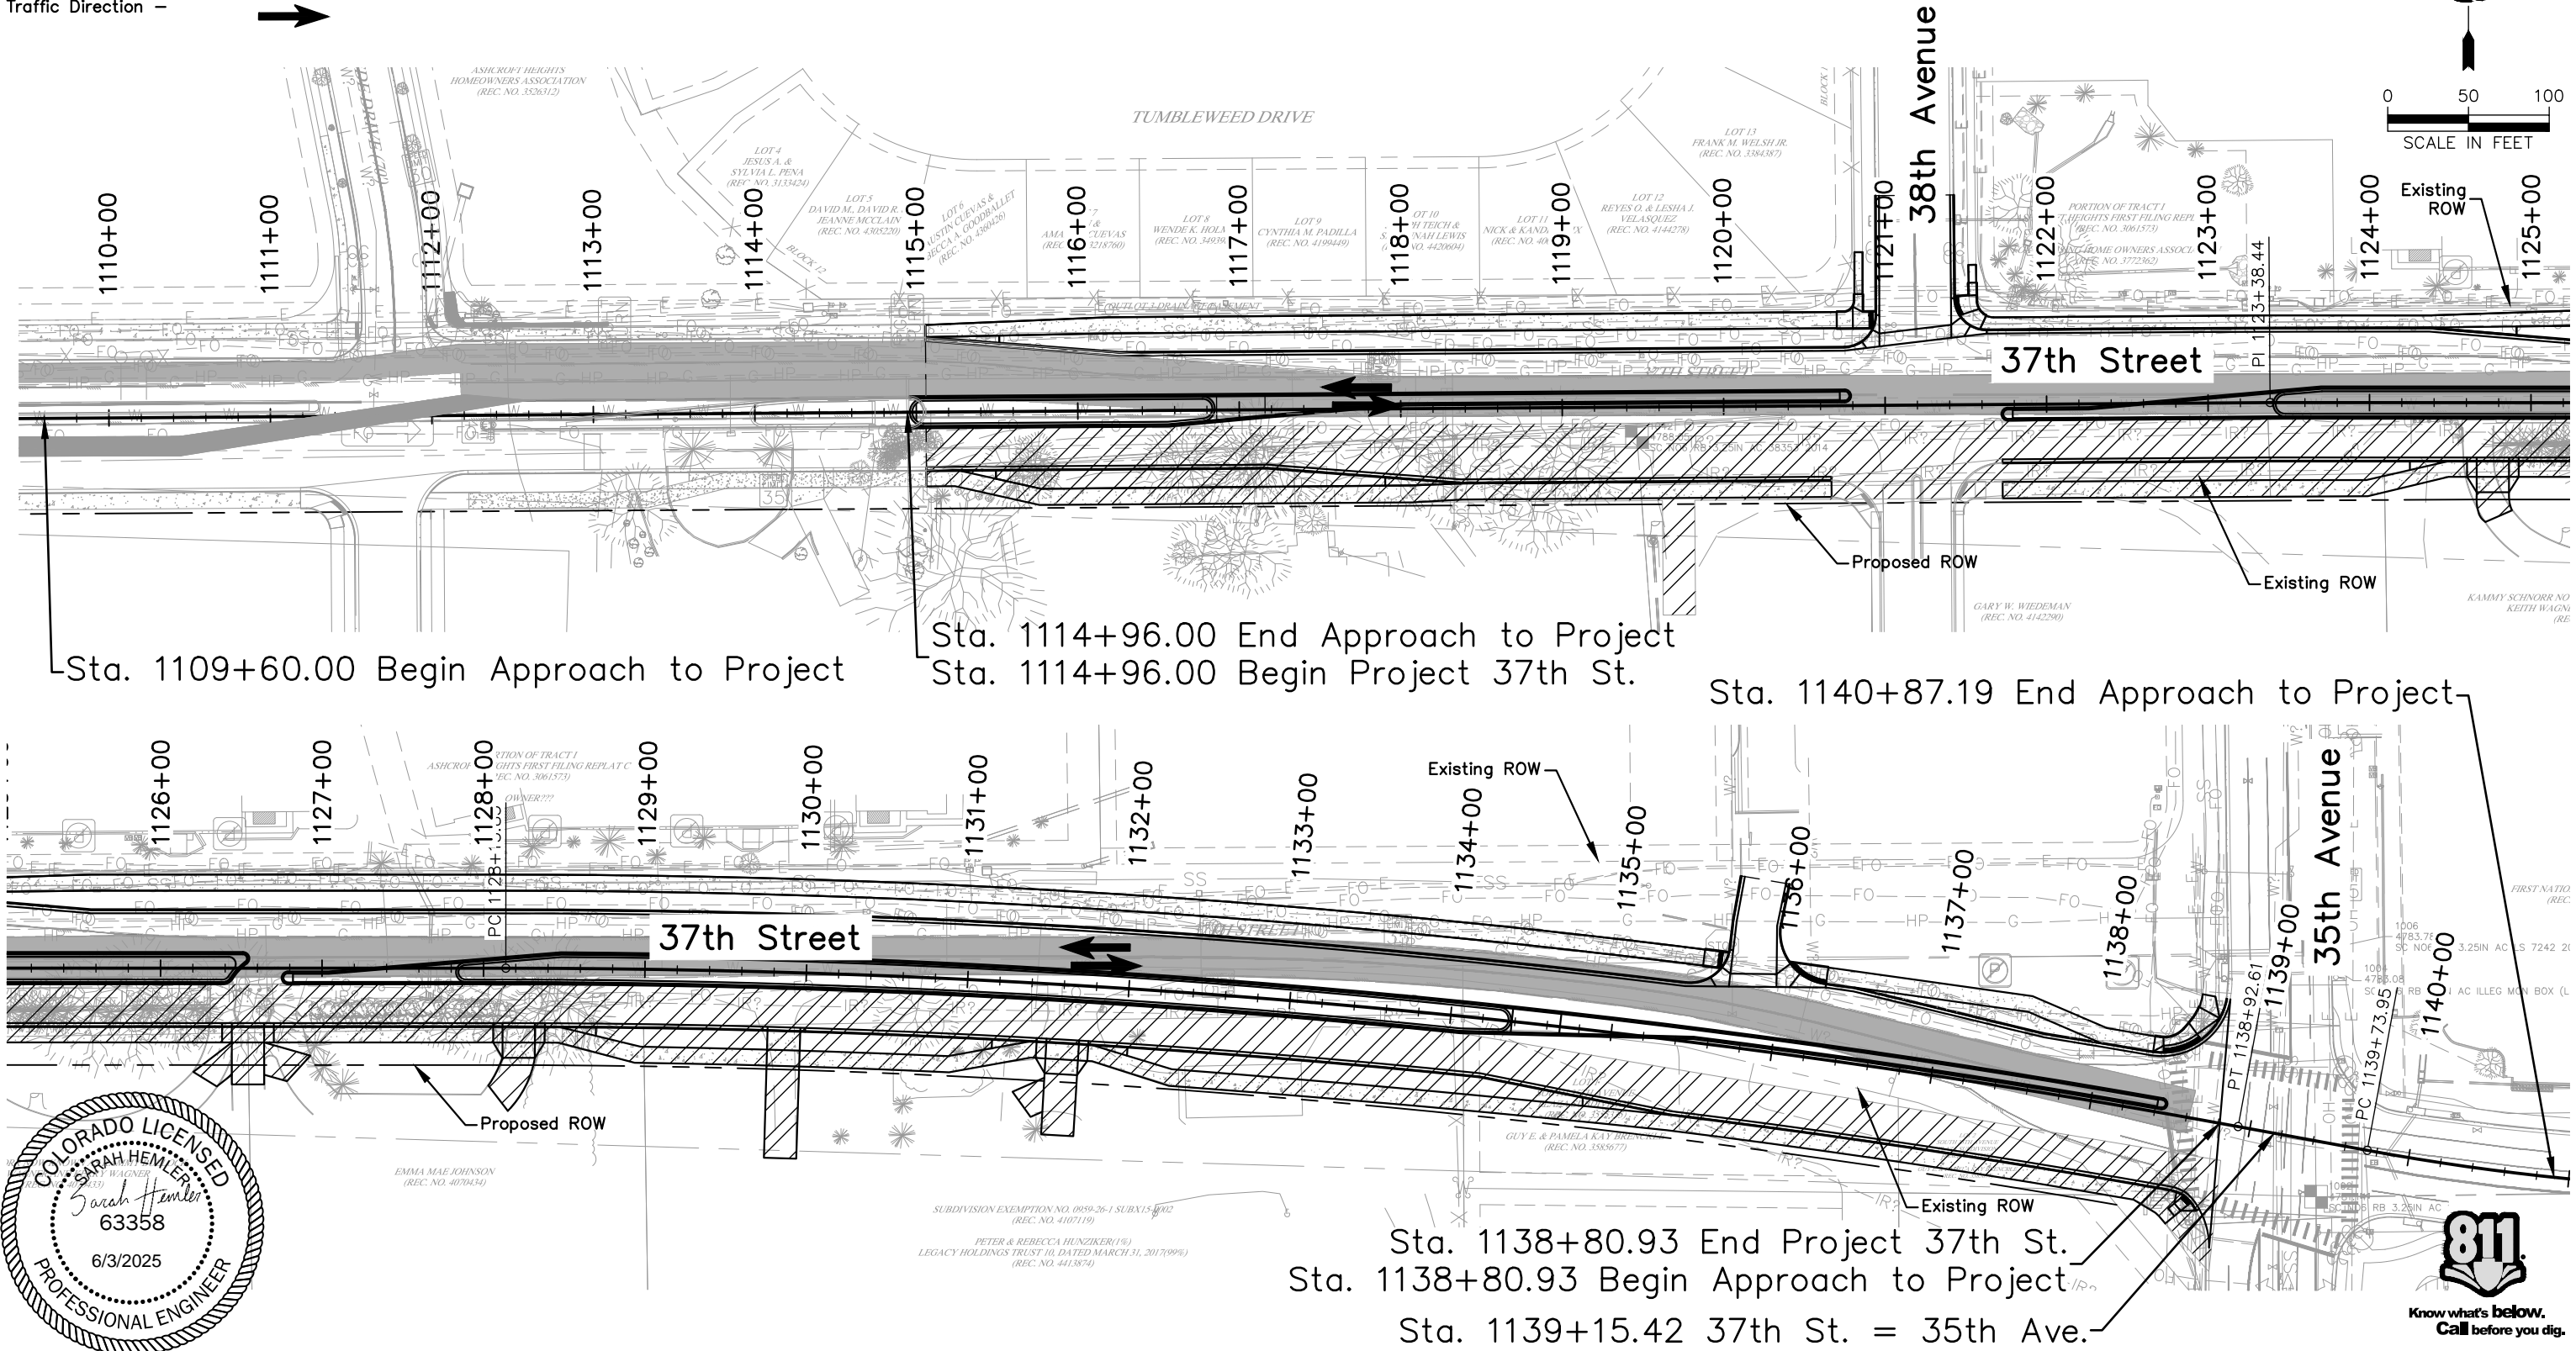

Print Date: 5/2/2025

File Name: PH P2B-001 CONSTRUCTION PHASING.DWG

Horiz. Scale: As Noted Vert. Scale: N/A




RockSol Consulting Group, Inc.



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Sheet Revisions		
Date	Comments	Initials

As Constructed	37TH STREET WIDENING PHASE 2B CONSTRUCTION PHASING PHASE 1		Project No.
	No Revisions:		37TH STREET 2B
	Revised:	Designer: T. Tuttle Detailer: C. Petersen	Drawing Number PH-003
Void:	Sheet Subset: PHASING	Subset Sheets: 3 of 4	Sheet Number 118

FOR CONSTRUCTION 5/1/2025


Legend:
Construction Phase 2 - 
Phase 2 Traffic - 
Traffic Direction - 

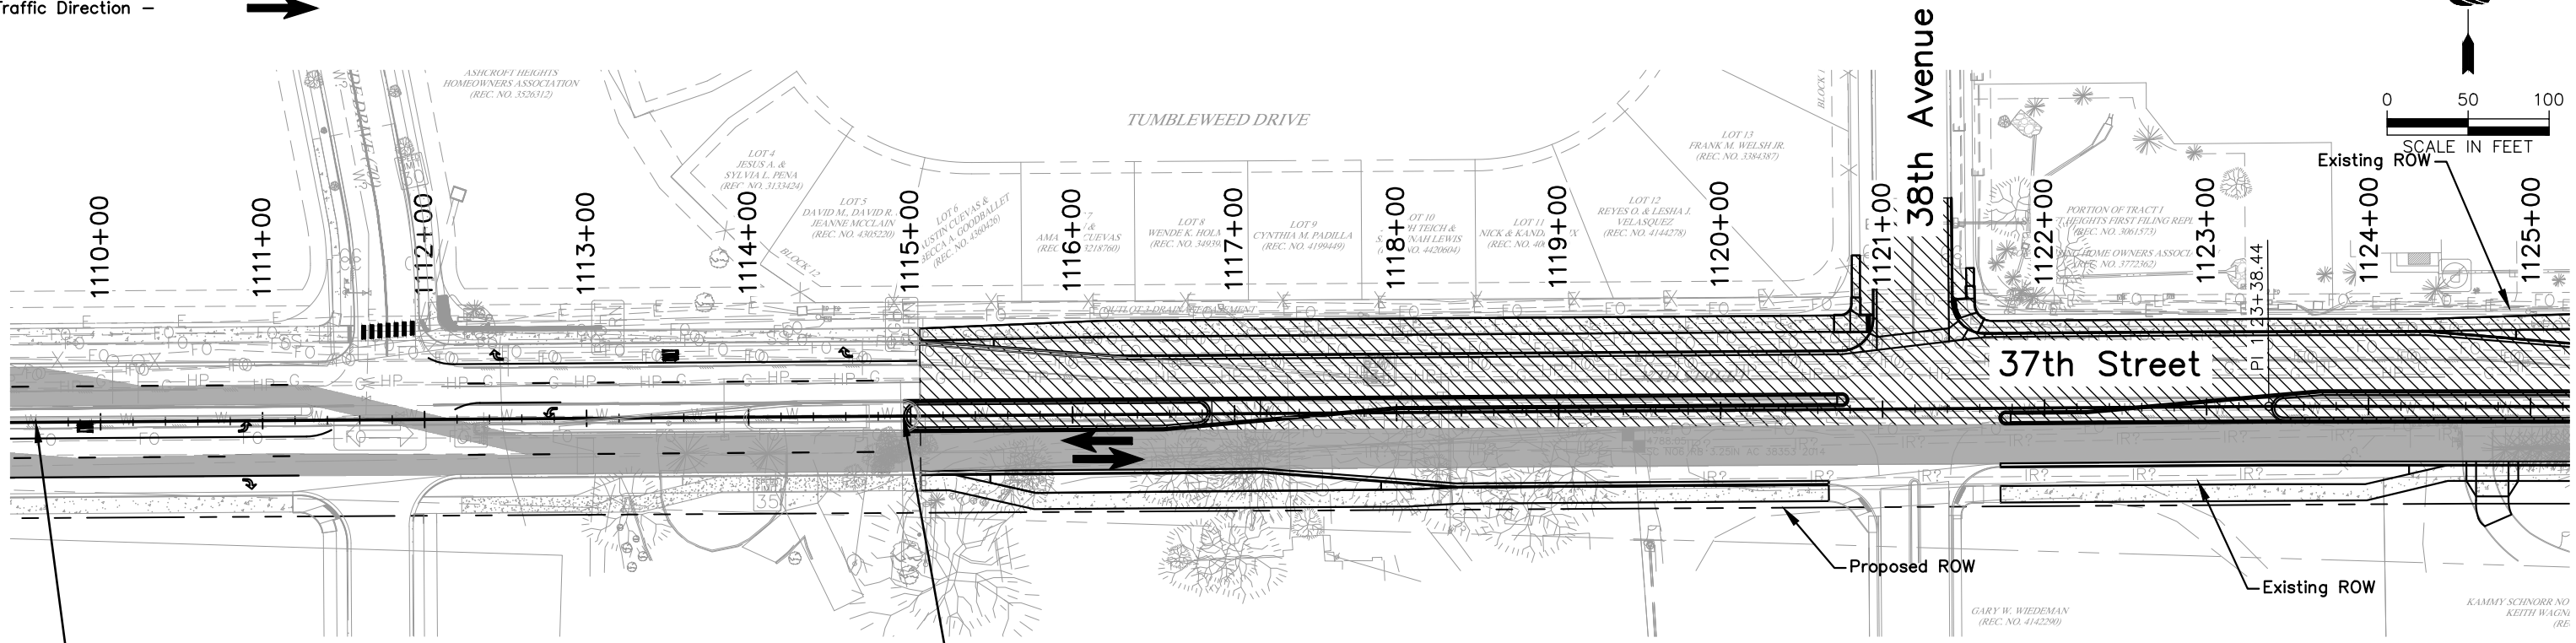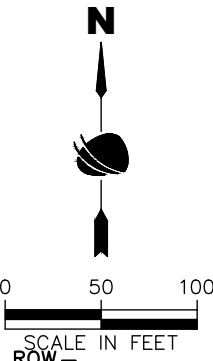

Sta. 1109+60.00 Begin Approach to Project

Sta. 1114+96.00 End Approach to Project
Sta. 1114+96.00 Begin Project 37th St.

Sta. 1140+87.19 End Approach to Project

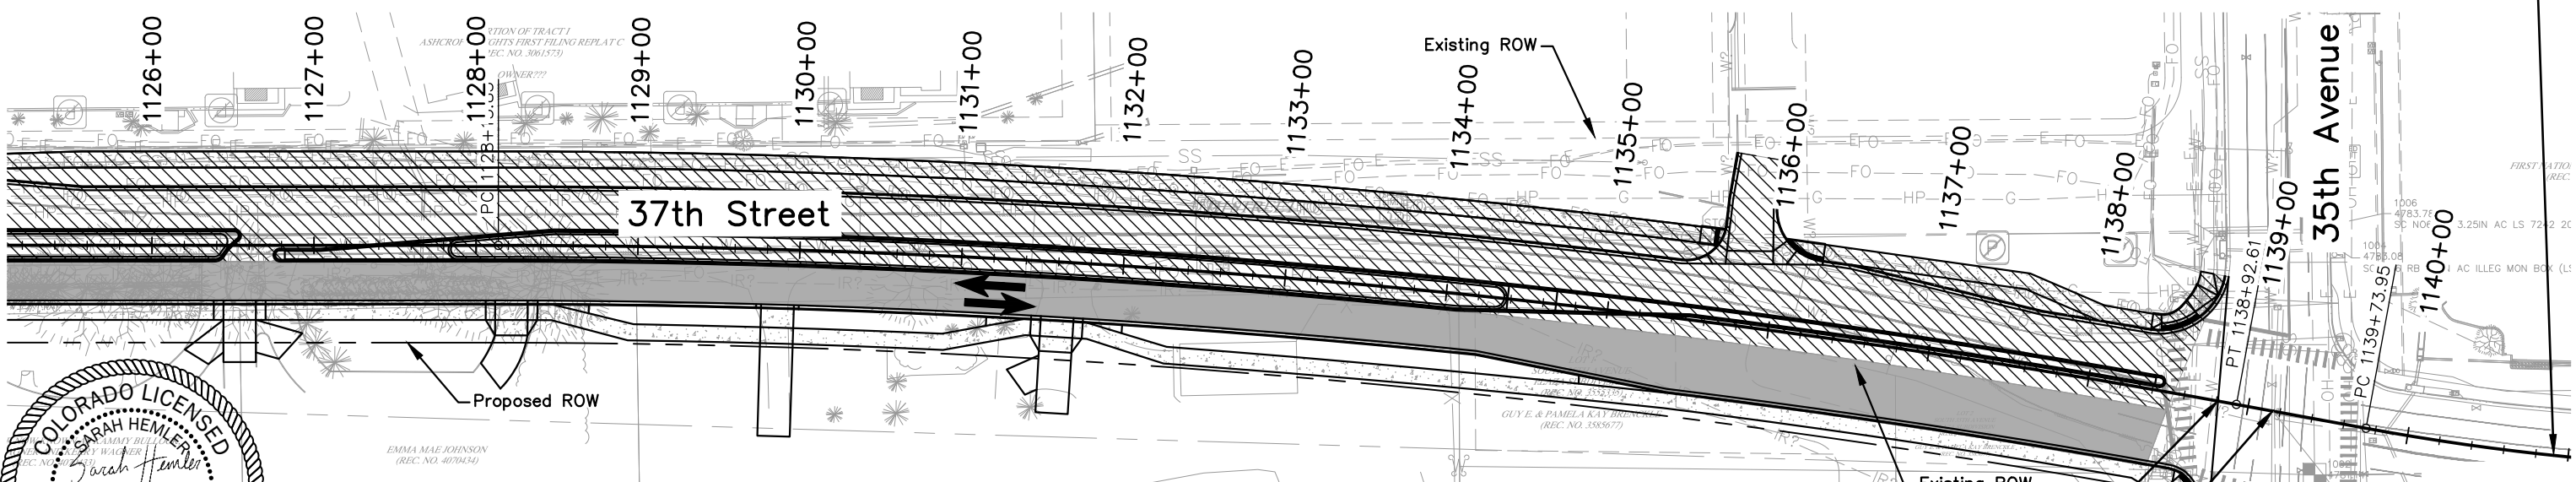

Sta. 1138+80.93 End Project 37th St.
Sta. 1138+80.93 Begin Approach to Project
Sta. 1139+15.42 37th St. = 35th Ave.



Print Date: 5/2/2025
File Name: PH P2B-002 CONSTRUCTION PHASING.DWG
Horiz. Scale: As Noted Vert. Scale: N/A



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City of
Evans, Colorado



FREEDOM
Parkway

As Constructed	37TH STREET WIDENING PHASE 2B CONSTRUCTION PHASING PHASE 2		Project No.
No Revisions:			37TH STREET 2B
Revised:	Designer: T. Tuttle	Structure Numbers	Drawing Number PH-004
Void:	Detailer: C. Petersen		
	Sheet Subset: PHASING	Subset Sheets: 4 of 4	Sheet Number 119

Plot Date: 5/2/2025 6:53 AM Plotted By: Sarah Hemler
C:\Q-PROJECTS\VAI\PROJECTS\33001\EVANS 37TH ST AND 47TH AVE PLAN\2020 COMPUTER DESIGN FILES\P2 - PHASE 2B\2020 SHEET FILES\TRAFTAB P2B-001 TRAFFIC TABULATION.DWG

TABULATION OF SIGNS														
SIGN NO.	SIGN CODE	LEGEND	COLOR	EXISTING LOCATION	EXISTING POSITION	TRAVEL DIRECTION	PANEL SIZE	PROPOSED LOCATION	PROPOSED POSITION	STEEL SIGN POST (1.75x1.75 INCH TUBING)	SIGN PANEL	RESETS	REMOVALS	REMARKS
							INCHES			LF	CLASS I	GROUND SIGN	GROUND SIGN	
											SF	EACH	EACH	
1	W4-2	Lane Ends	Yellow	1109+63	58' Right	East	36" x 36"						1	Remove from transition of 37th St. Ph 2A Project
2	R2-1	Speed Limit 45mph	White	1117+90	25' Left	West	30" x 36"						1	
3	R2-1	Speed Limit 35mph	White			West	30" x 36"	1120+01	42' Left	11.0	7.50			
4	R4-7	Keep Right	White			West	24" x 30"	1120+53	6' Left	10.5	5.00			
5a	R1-1	Stop	Red	1120+89	42' Left	South	36" x 36"	1120+90	63' Left	13.0	9.00			
5b	D3-1	38th Avenue	Green	1120+89	42' Left	South	36" x 12"	1120+90	63' Left		3.00			
5c	D3-1	37th St	Green	1120+89	42' Left	South	36" x 12"	1120+90	63' Left		3.00			
6	W1-7	Two-Direction Large Arrow	Yellow	1121+09	21' Right	South	48" x 24"	1121+24	42' Right	10.0	8.00			
7	R3-7R	Right Lane Must Turn Right	White	1121+93	35' Left	West	30" x 30"	1121+81	63' Left	10.5	6.25			
8	R4-7	Keep Right	White			East	24" x 30"	1121+87	0'	10.5	5.00			
9	R2-1	Speed Limit 35mph	White			East	30" x 36"	1122+61	42' Right	11.0	7.50			
10	R3-7R	Right Lane Must Turn Right	White	1124+23	33' Left	West	30" x 30"	1124+36	64' Left	10.5	6.25			
11	R3-4	No U-Turn	White			East	24" x 24"	1126+24	6' Right	10.0	4.00			
12	R6-1R	One Way	White			North	54" x 18"	1126+42	0'	9.5	6.75			
13	OM3-R	Warning	Yellow	1127+62	9' Right	East	12" x 36"						1	
14	OM3-R	Warning	Yellow	1127+72	9' Right	West	12" x 36"						1	
15	R2-1	Speed Limit 35mph	White	1132+54	7' Left	East	30" x 36"						1	
16a	R1-1	Stop	Red	1135+61	62' Left	South	36" x 36"	1135+61	60' Left			1		
16b	D3-1	37th St	Green	1135+22	64' Left	South	36" x 12"							Included in reset of 16a
17	R3-7R	Right Lane Must Turn Right	White			East	30" x 30"	1135+93	64' Right	10.5	6.25			
18	R3-7R	Right Lane Must Turn Right	White			West	30" x 30"	1136+43	62' Left	10.5	6.25			
19	SPECIAL	Special Sign	White	1136+77	7' Right	East	36" x 36"	1136+75	64' Right	11.0	9.00			See Signing and Striping
20	R2-1	Speed Limit 35mph	White			West	30" x 36"	1136+84	41' Left	11.0	7.50			
21	R4-7	Keep Right	White			West	24" x 30"	1138+30	5' Left	10.5	5.00			
22	R3-7R	Right Lane Must Turn Right	White			East	30" x 30"	1138+33	63' Right	10.5	6.25			
23	R3-5R	Right Turn Only	White	1138+60	26' Right	West	30" x 36"						1	Mounted on mast arm
24	R3-7R	Right Lane Must Turn Right	White	1140+24	30' Left	West	30" x 30"						1	
TOTAL										170.5	111.5	1	7	



Print Date: 5/2/2025

File Name: TRAF TAB P2B-001 TRAFFIC TABULATION.DWG

Horiz. Scale: N/A

Vert. Scale: N/A

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Sheet Revisions		
Date	Comments	Initials

As Constructed

No Revisions:

Revised:

Void:

37TH STREET WIDENING PHASE 2B
SIGNING AND STRIPING TABULATION

Designer: T. Tuttle

Detailer: S. Hemler

Sheet Subset: TRAF TAB

Structure Numbers

Subset Sheets: 1 of 2

Project No.

37TH STREET 2B

Drawing Number TTAB-001

Sheet Number 120

FOR CONSTRUCTION 5/1/2025

Plot Date: 5/2/2025 6:53 AM Plotted By: Sarah Hemler
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TABULATION OF PAVEMENT MARKINGS								
STATION	SIDE	LANE	CHANNELIZING		PVMT MARKING		REMARKS	
		WHITE BROKEN 4 INCH	WHITE LANE LINE 8 INCH	WHITE LANE DROP 8 INCH	WORD SYMBOL	X WALK - STOP LINE		
		LF	LF	LF	SF	SF		
1115+06 - 1120+76	RT	143						
1115+06 - 1120+76	LT	143						
1118+00 - 1120+91	RT		292					
1118+30	RT				16.1			
119+41	RT				22.5			
1120+49	RT				16.1			
1121+19						180		
1121+49 - 1124+35	LT		287					
1121+65 - 1138+19	RT	414						
1121+65 - 1138+11	LT	412						
1121+90	LT				16.1			
1122+90	LT				22.5			
1123+87	LT				16.1			
1126+51 - 1127+04	LT		75					
1126+99	RT				16.1			
1135+42 - 1138+57	RT		313					
1135+51 - 1138+49	RT		371					
1136+06	RT				32.2			
1136+11 - 1136+46	LT		35					
1136+40	LT				16.1			
1136+46 - 1137+65	LT			120				
1137+25	RT				45.0			
1138+31	RT				32.2			
1138+56	LT & RT					96	Stop Bar at Intersection	
1138+60	LT & RT					320	Cross Walk Markings	
1138+71	LT					22	Stop Bar at Intersection	
1139+69 - 1140+87	LT	30					East Side of Intersection	
TOTAL		855	1,374	120	251	618		

SUMMARY OF PAVEMENT MARKING QUANTITIES				
COLOR	MODIFIED EPOXY PAVEMENT MARKING		PREFORMED THERMO PAVEMENT MARKING	
			X-WALK	WORD SYMBOL
	MIN GAL	MAX GAL	SF	SF
WHITE	13	15	618	251
TOTALS	13	15	618	251

Note:
All cross walks, stop bars, and arrows shall be pre-formed thermoplastic.
Stationing is approximate, locations are to be field verified by contractor prior to final placement.



Print Date: 5/2/2025

File Name: TRAF TAB P2B-001 TRAFFIC TABULATION.DWG

Horiz. Scale: N/A Vert. Scale: N/A

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Sheet Revisions		
Date	Comments	Initials

As Constructed

No Revisions:

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37TH STREET WIDENING PHASE 2B
SIGNING AND STRIPING TABULATION

Designer: T. Tuttle
Detailer: S. Hemler
Sheet Subset: TRAF TAB

Structure Numbers
Subset Sheets: 2 of 2




Project No.

37TH STREET 2B

Drawing Number TTAB-002

Sheet Number 121

SIGN NO. 1
REMOVE

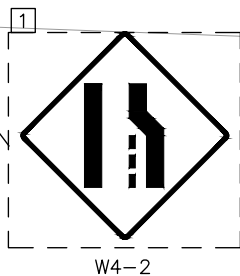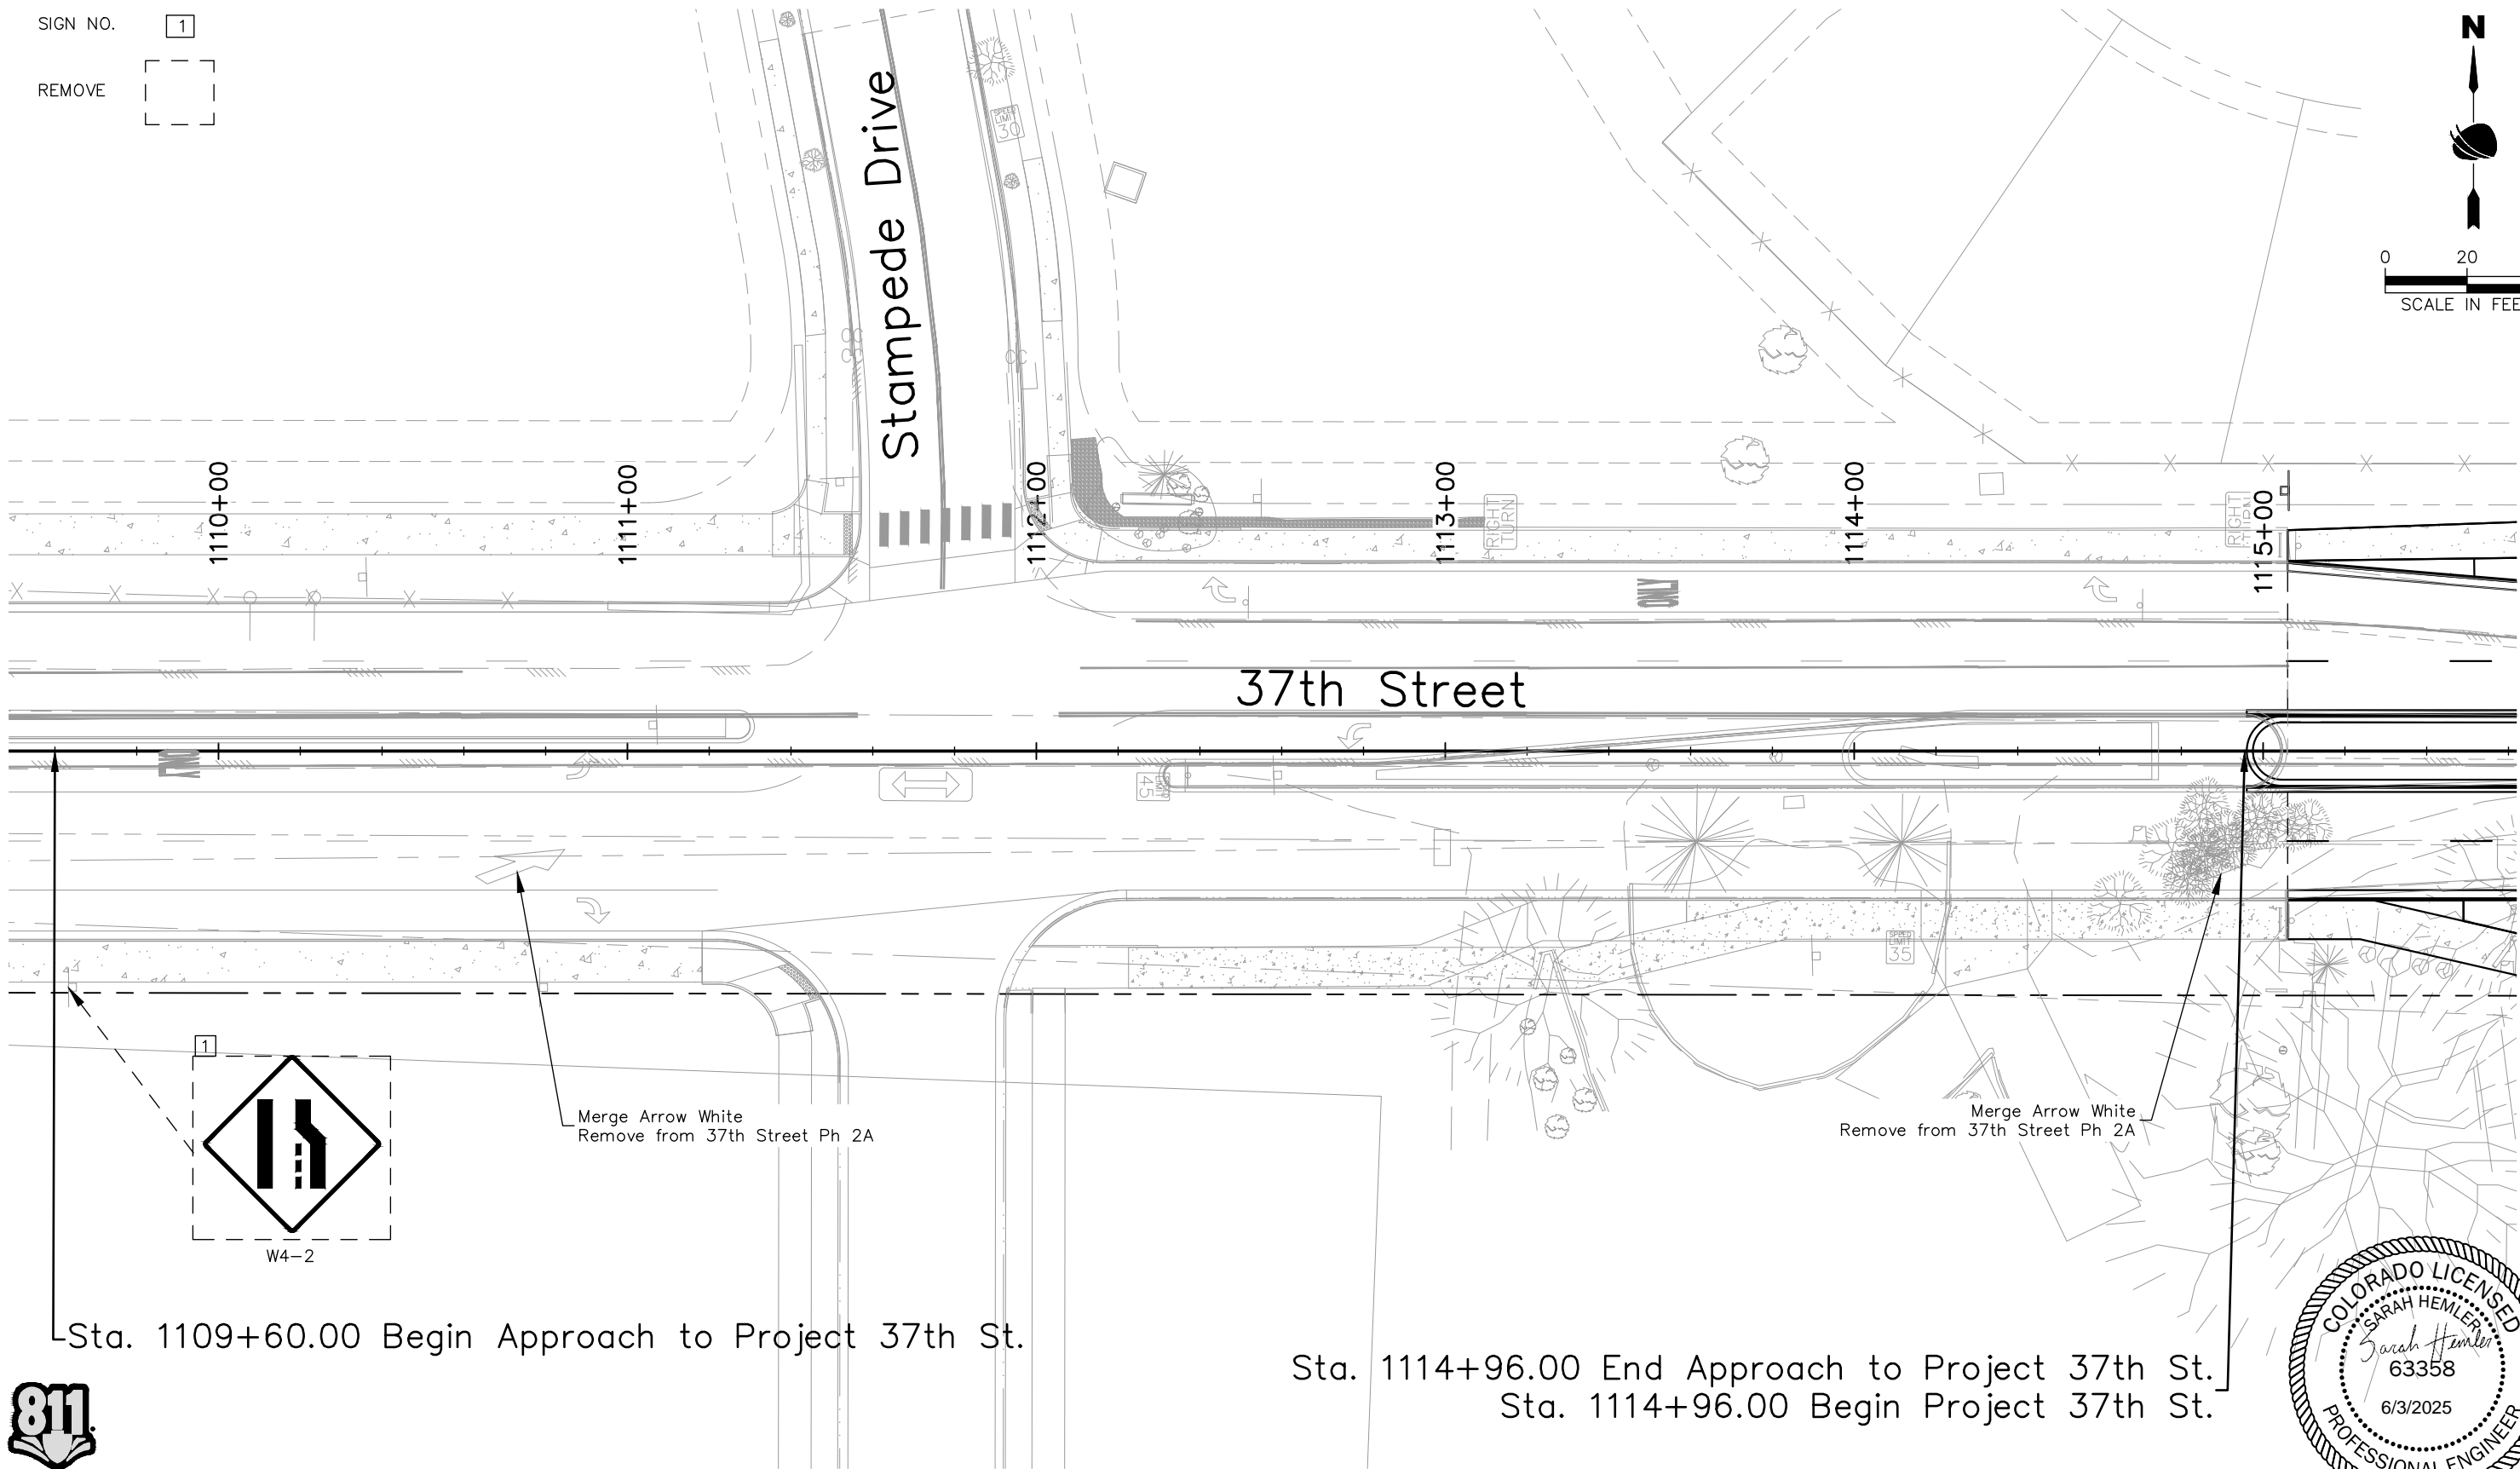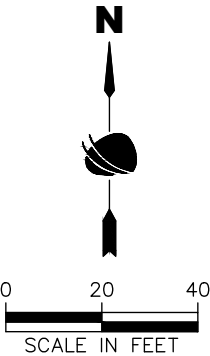

Merge Arrow White
Remove from 37th Street Ph 2A

Merge Arrow White
Remove from 37th Street Ph 2A

Sta. 1109+60.00 Begin Approach to Project 37th St.

Sta. 1114+96.00 End Approach to Project 37th St.
Sta. 1114+96.00 Begin Project 37th St.




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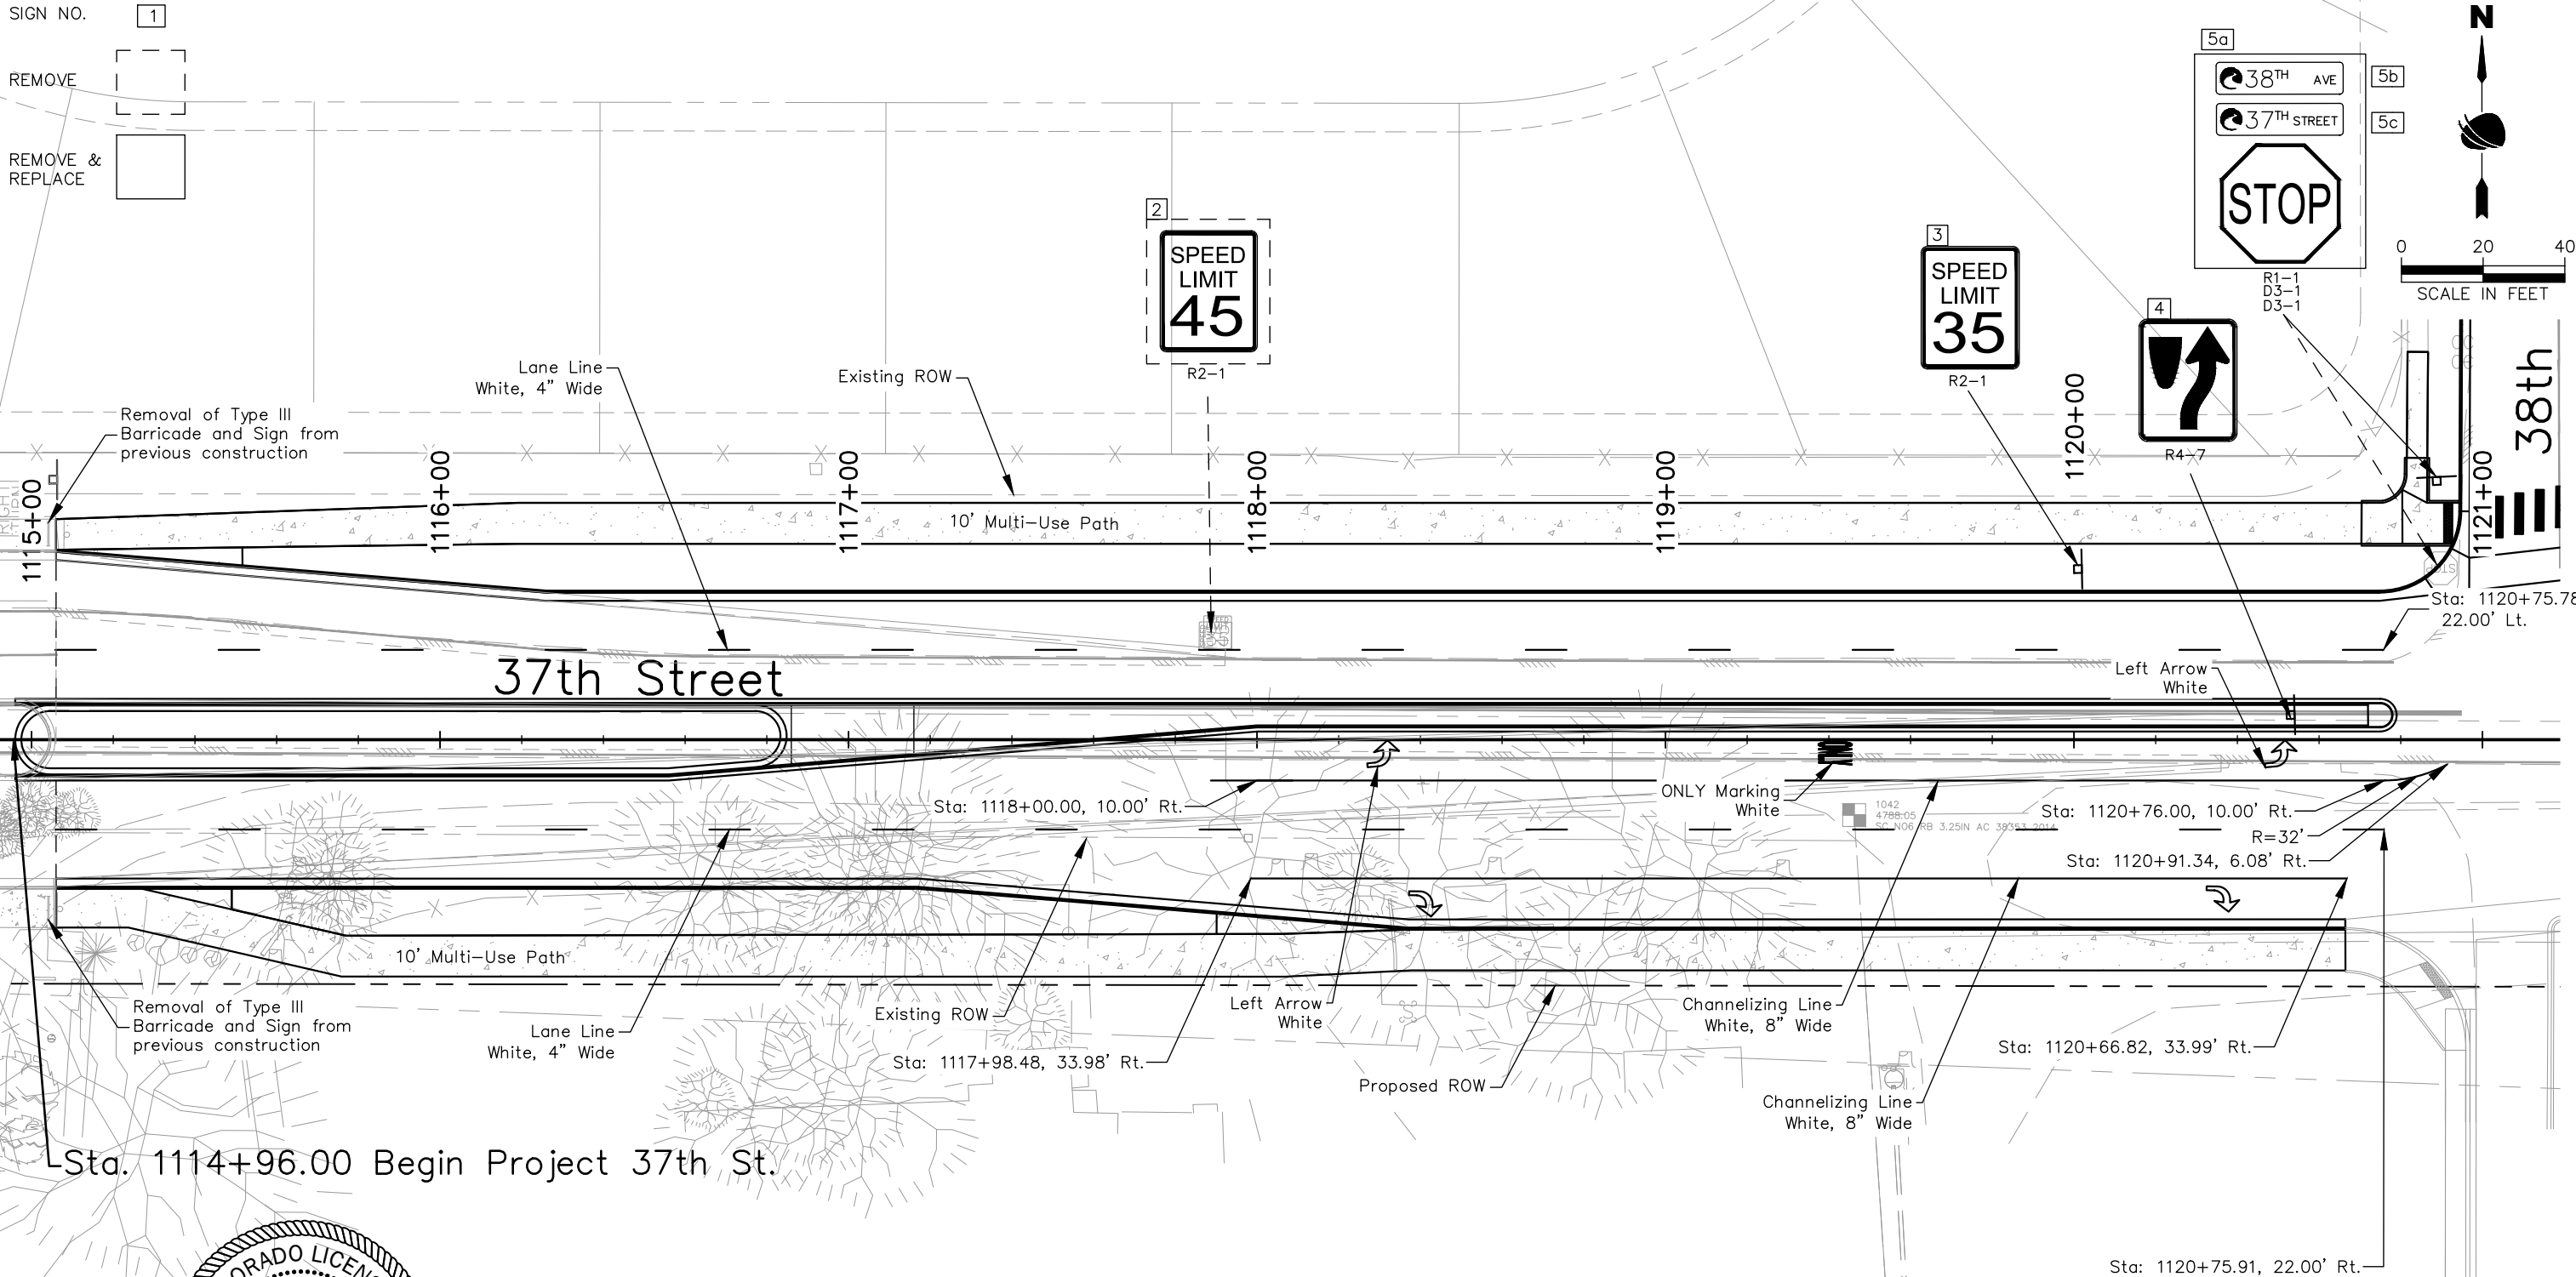
12076 Grant Street
Thornton, CO 80241
Ph: (303) 962-9300
Fax: (303) 962-9350


Sheet Revisions		
Date	Comments	Initials




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No Revisions:				37TH STREET 2B
Revised:		Designer: T. Tuttle	Structure Numbers	Drawing Number TRAF-001
Void:		Detailer: C. Petersen		Sheet Number 122
		Sheet Subset: TRAFFIC	Subset Sheets: 1 of 6	
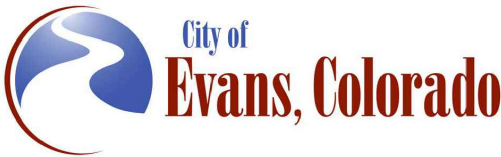
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Print Date: 5/2/2025		<table><tr><th colspan="3">Sheet Revisions</th></tr><tr><th>Date</th><th>Comments</th><th>Initials</th></tr><tr><td></td><td></td><td></td></tr><tr><td></td><td></td><td></td></tr><tr><td></td><td></td><td></td></tr></table>	Sheet Revisions			Date	Comments	Initials										As Constructed		37TH STREET WIDENING PHASE 2B SIGNING AND STRIPING PLAN			Project No.	
Sheet Revisions																								
Date	Comments		Initials																					
File Name: TRAF P2B-001 TRAFFIC SIGNING AND STRIPING.DWG			No Revisions:					37TH STREET 2B																
Horiz. Scale: As Noted Vert. Scale: N/A			Revised:		Designer:	T. Tuttle	Structure	Drawing Number TRAF-002																
 12076 Grant Street Thornton, CO 80241 Ph: (303) 962-9300 Fax: (303) 962-9350			Void:		Detailer:	C. Petersen	Numbers	Sheet Number 123																
					Sheet Subset:	TRAFFIC	Subset Sheets: 2 of 6																	




City of
Evans, Colorado





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Print Date: 5/2/2025

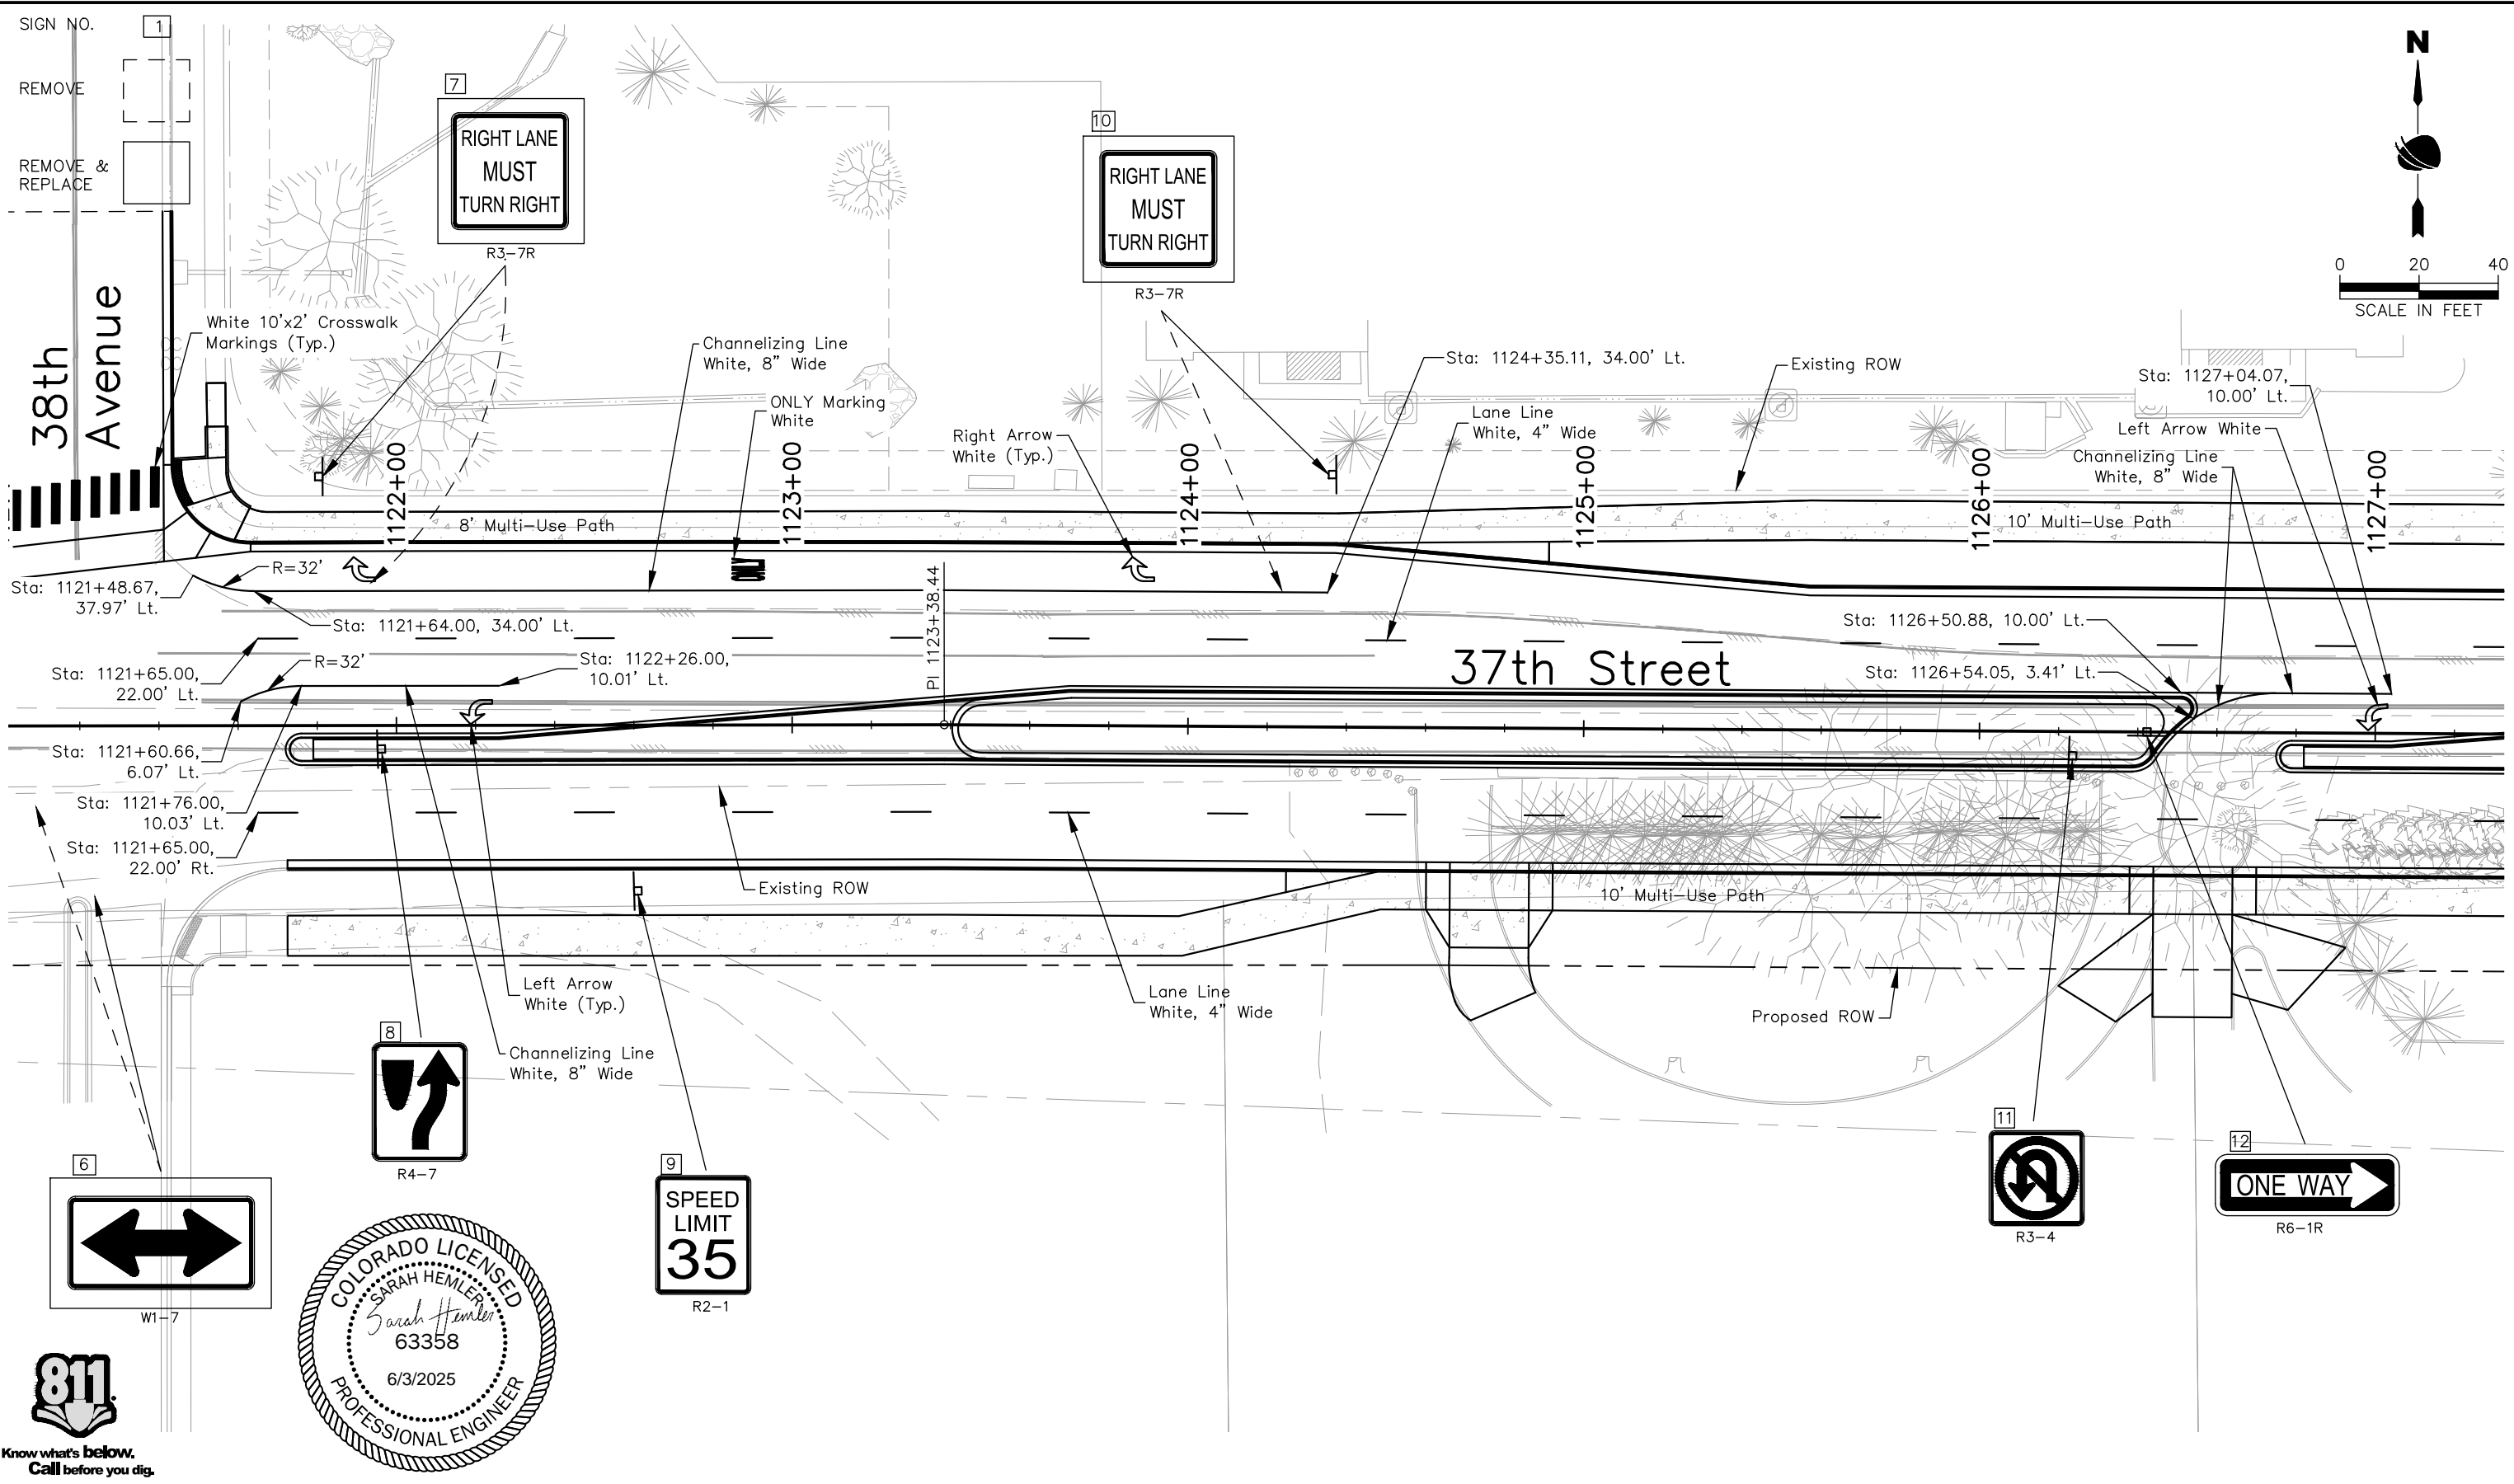File Name: TRAF P2B-001 TRAFFIC SIGNING AND STRIPING.DWG

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Sheet Revisions		
Date	Comments	Initials







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No Revisions:			37TH STREET 2B
Revised:	Designer: T. Tuttle	Structure Numbers	Drawing Number TRAF-003
Void:	Detailer: C. Petersen		
Sheet Subset: TRAFFIC		Subset Sheets: 3 of 6	Sheet Number 124

Plot Date: 5/2/2025 6:54 AM Plotted By: Sarah Hemler
C:\Q-PROJECTS\TRAFFIC PROJECTS\37TH ST AND 47TH AVE PLAN\2025\COMPUTER DESIGN FILES\TRAFFIC P2B-001 TRAFFIC SIGNING AND STRIPING.DWG


FOR CONSTRUCTION 5/1/2025

SIGN NO. 1
REMOVE
REMOVE & REPLACE

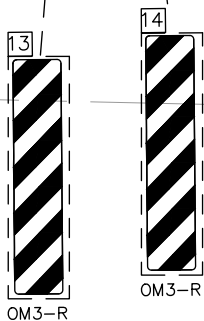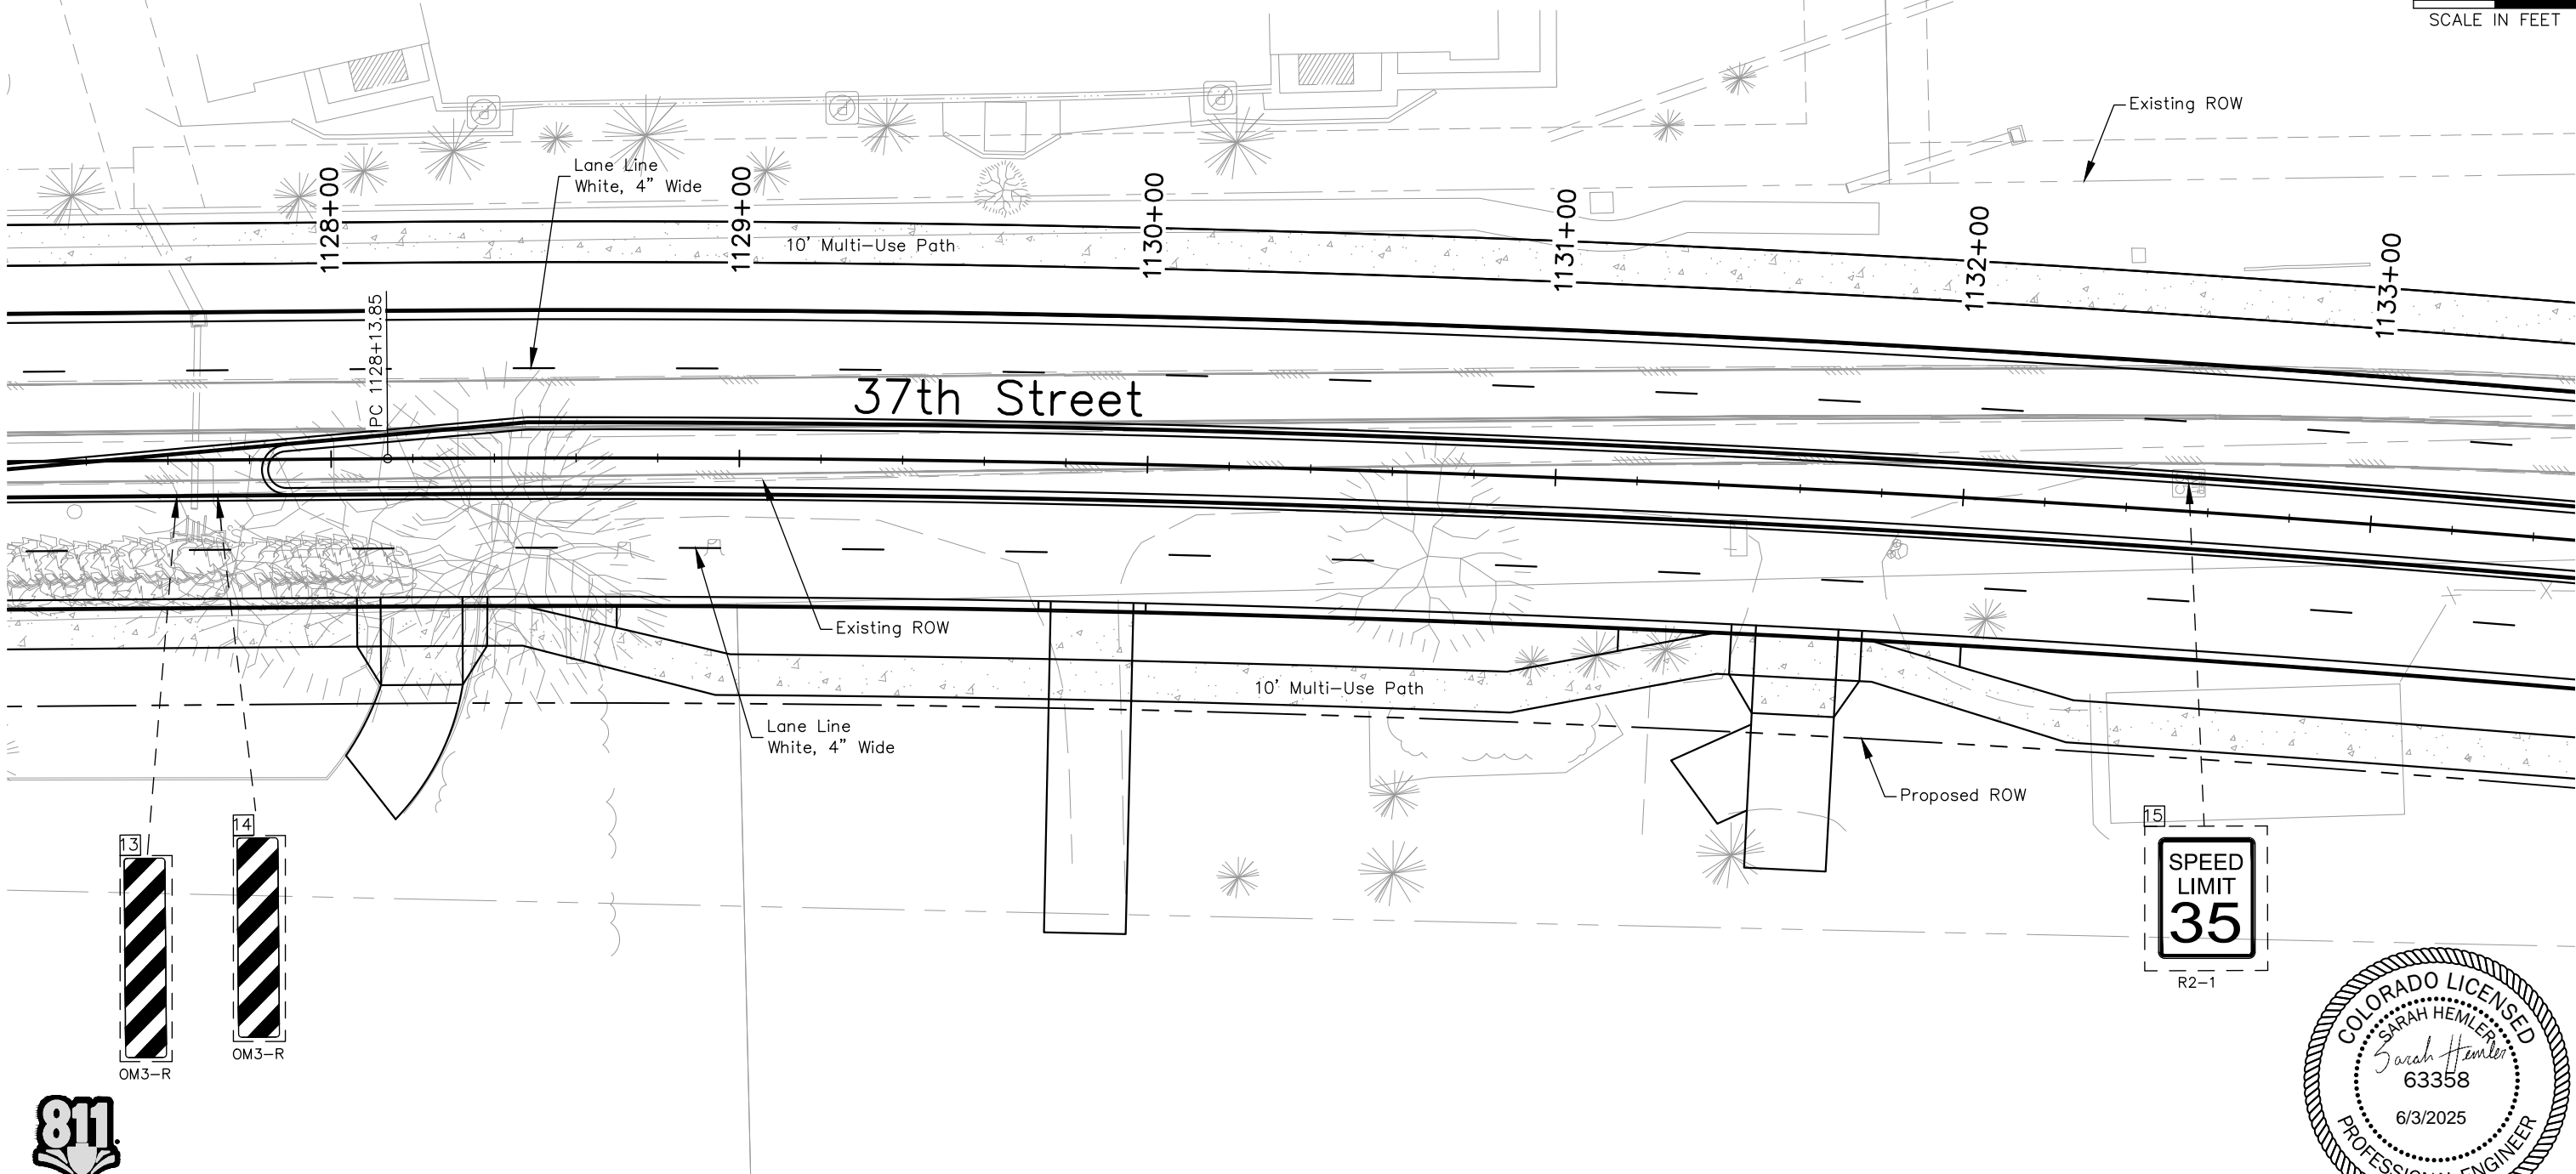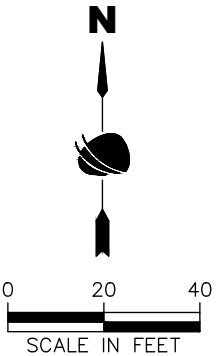

Print Date: 5/2/2025	
File Name: TRAF P2B-001 TRAFFIC SIGNING AND STRIPING.DWG	
Horiz. Scale: As Noted	Vert. Scale: N/A
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Sheet Revisions		
Date	Comments	Initials

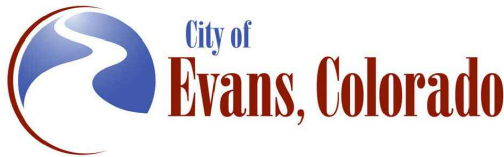

As Constructed	37TH STREET WIDENING PHASE 2B SIGNING AND STRIPING PLAN			Project No.
	No Revisions:	Designer: T. Tuttle	Structure Numbers	37TH STREET 2B
Revised:		Detailer: C. Petersen		Drawing Number TRAF-004
Void:		Sheet Subset: TRAFFIC	Subset Sheets: 4 of 6	Sheet Number 125

FOR CONSTRUCTION 5/1/2025

SIGN NO. 1

REMOVE

REMOVE & REPLACE

RESET

16a

37TH STREET

16b

STOP

R1-1
D3-1

18

RIGHT LANE
MUST
TURN RIGHT

R3-7R

20

SPEED
LIMIT
35

R2-1

21

R4-7

White 11' x 2'
Stop Line


See TRAF-005

White 10' x 2'
Crosswalk
Markings (Typ.)

N

0 20 40

SCALE IN FEET

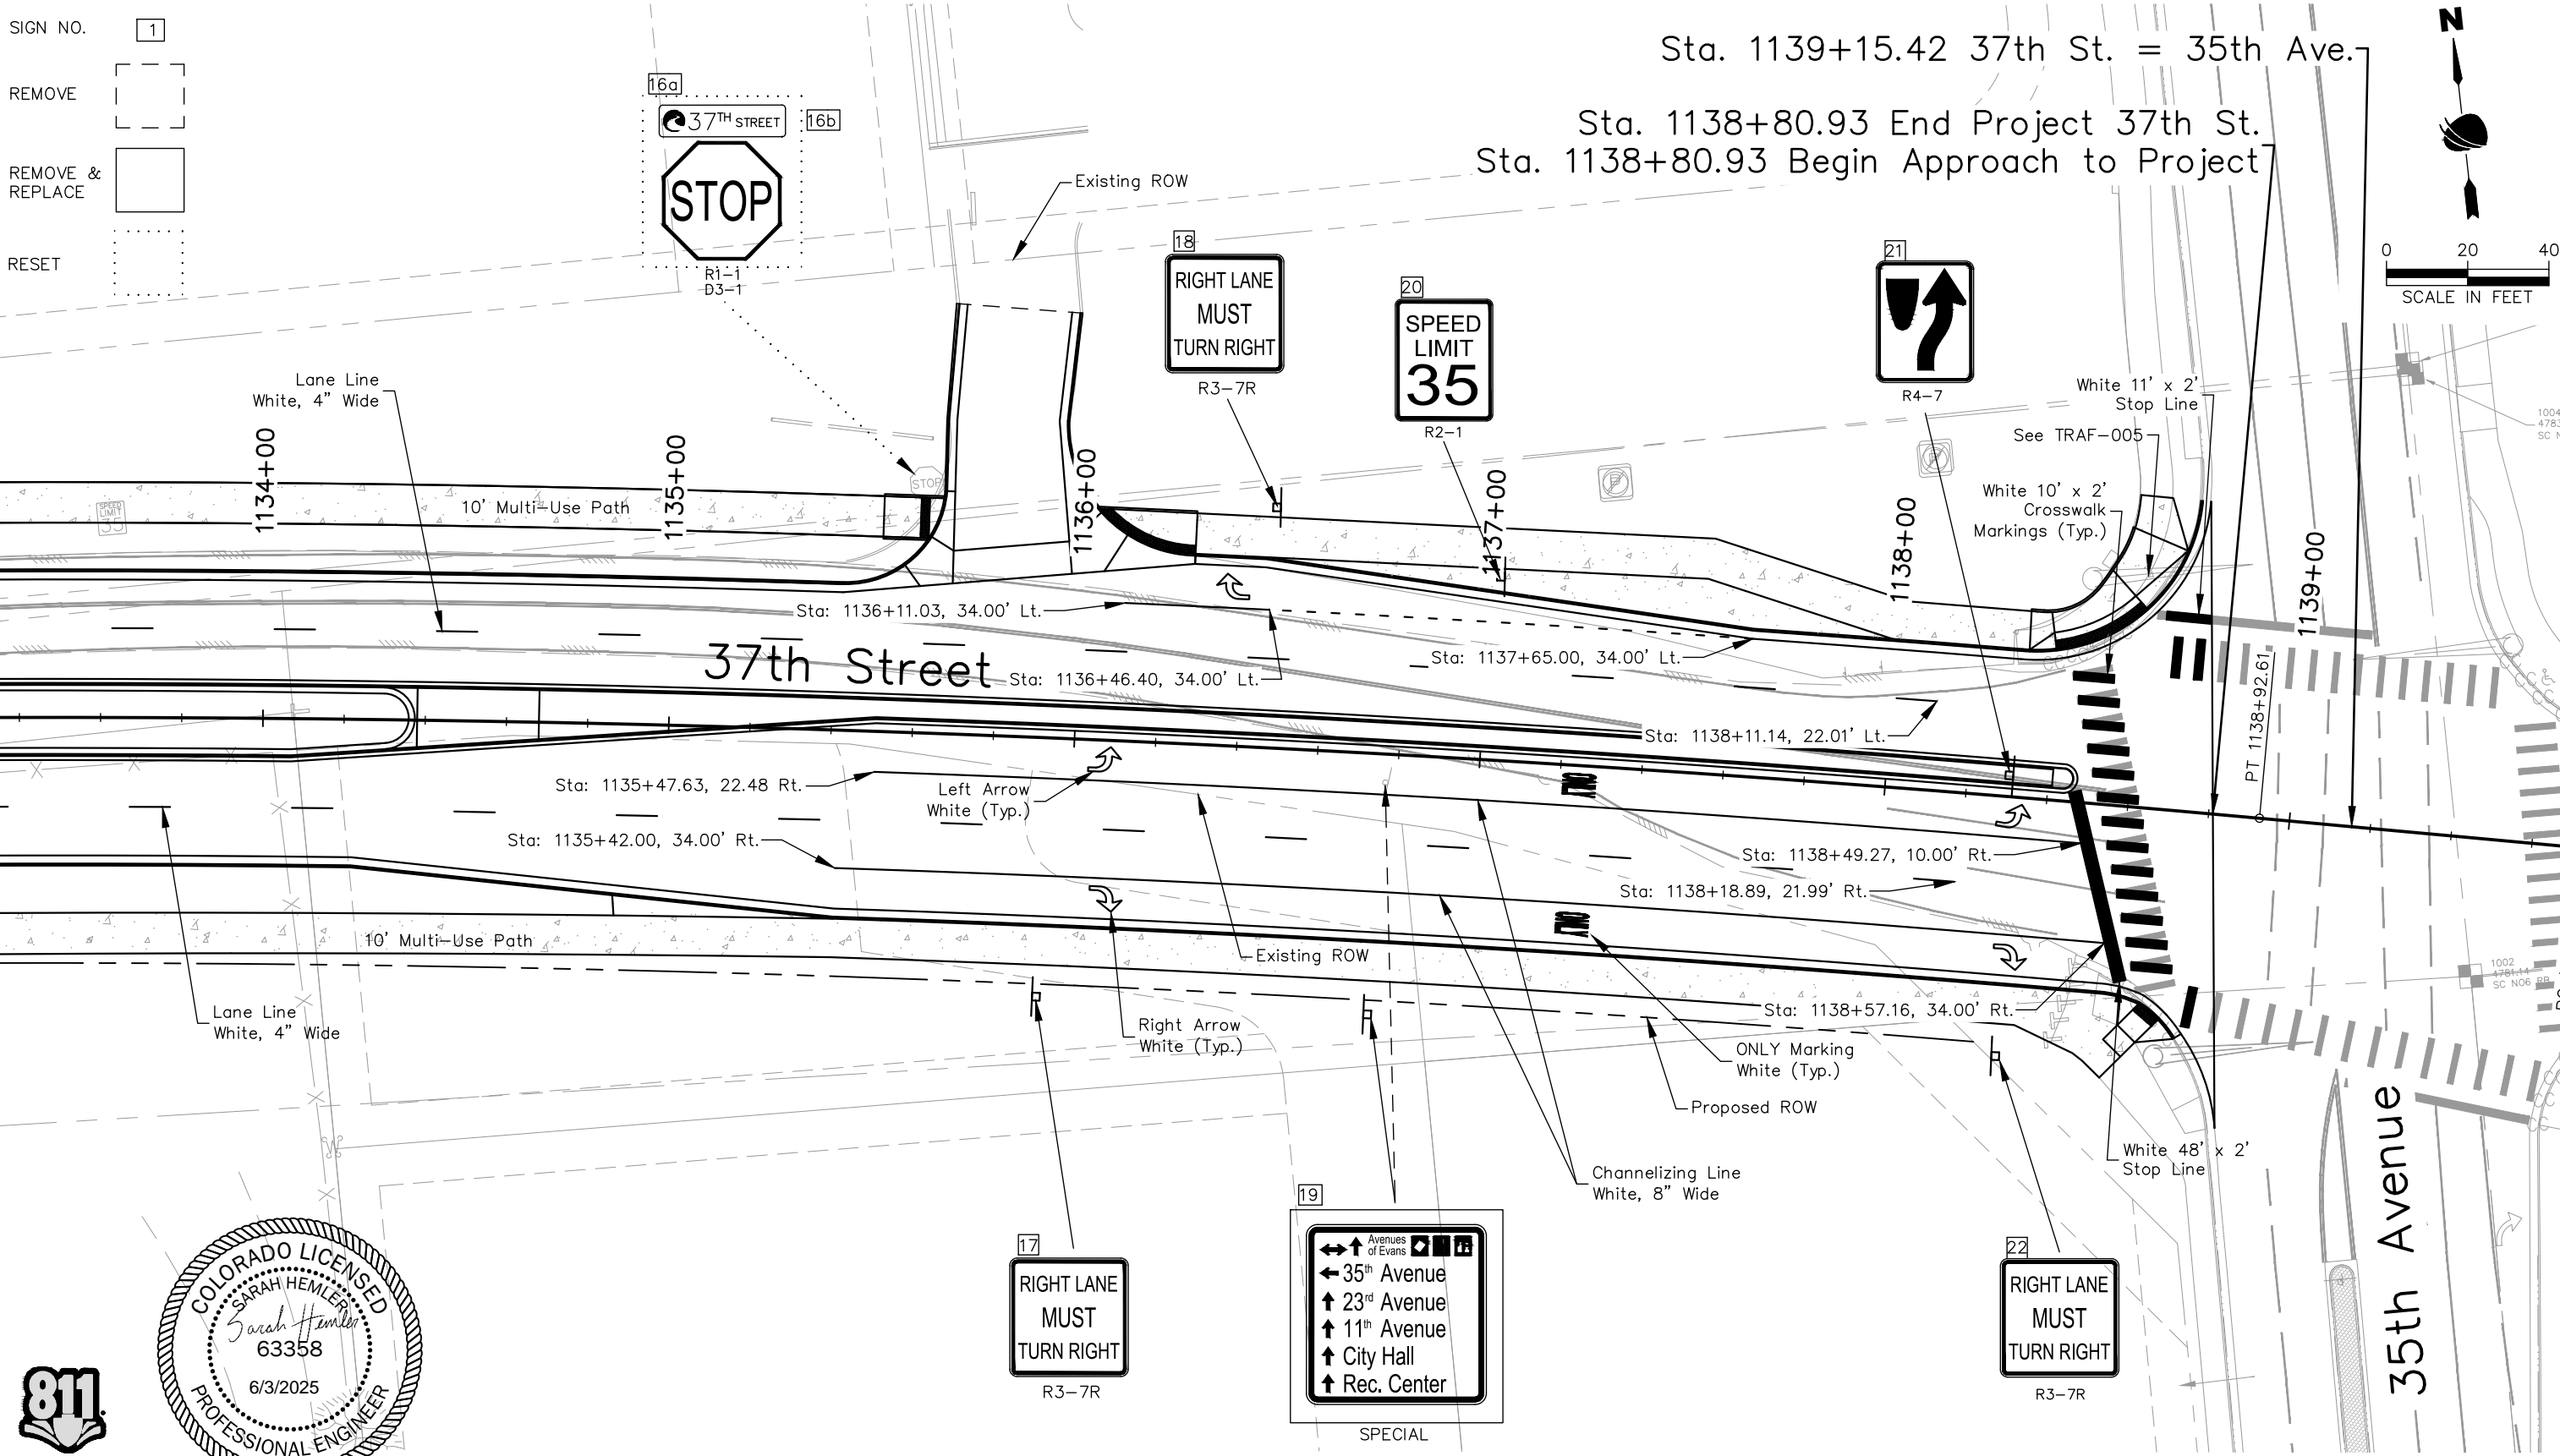

Print Date: 5/2/2025


File Name: TRAF P2B-001 TRAFFIC SIGNING AND STRIPING.DWG

Horiz. Scale: As Noted Vert. Scale: N/A

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Date	Comments	Initials



As Constructed		37TH STREET WIDENING PHASE 2B SIGNING AND STRIPING PLAN		Project No.
No Revisions:		Designer: T. Tuttle Detailer: C. Petersen Sheet Subset: TRAFFIC		37TH STREET 2B
Revised:		Structure Numbers		Drawing Number TRAF-005
Void:		Subset Sheets: 5 of 6		Sheet Number 126

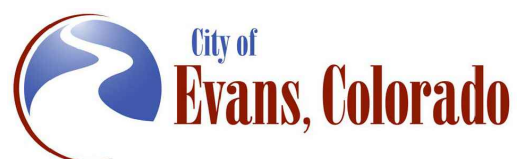FOR CONSTRUCTION 5/1/2025



SIGN NO. 1
REMOVE
REMOVE & REPLACE

Sta. 1138+80.93 End Project 37th St.
Sta. 1138+80.93 Begin Approach to Project

Sta. 1139+15.42 37th St. = 35th Ave.

RIGHT LANE
MUST
TURN RIGHT

ONLY

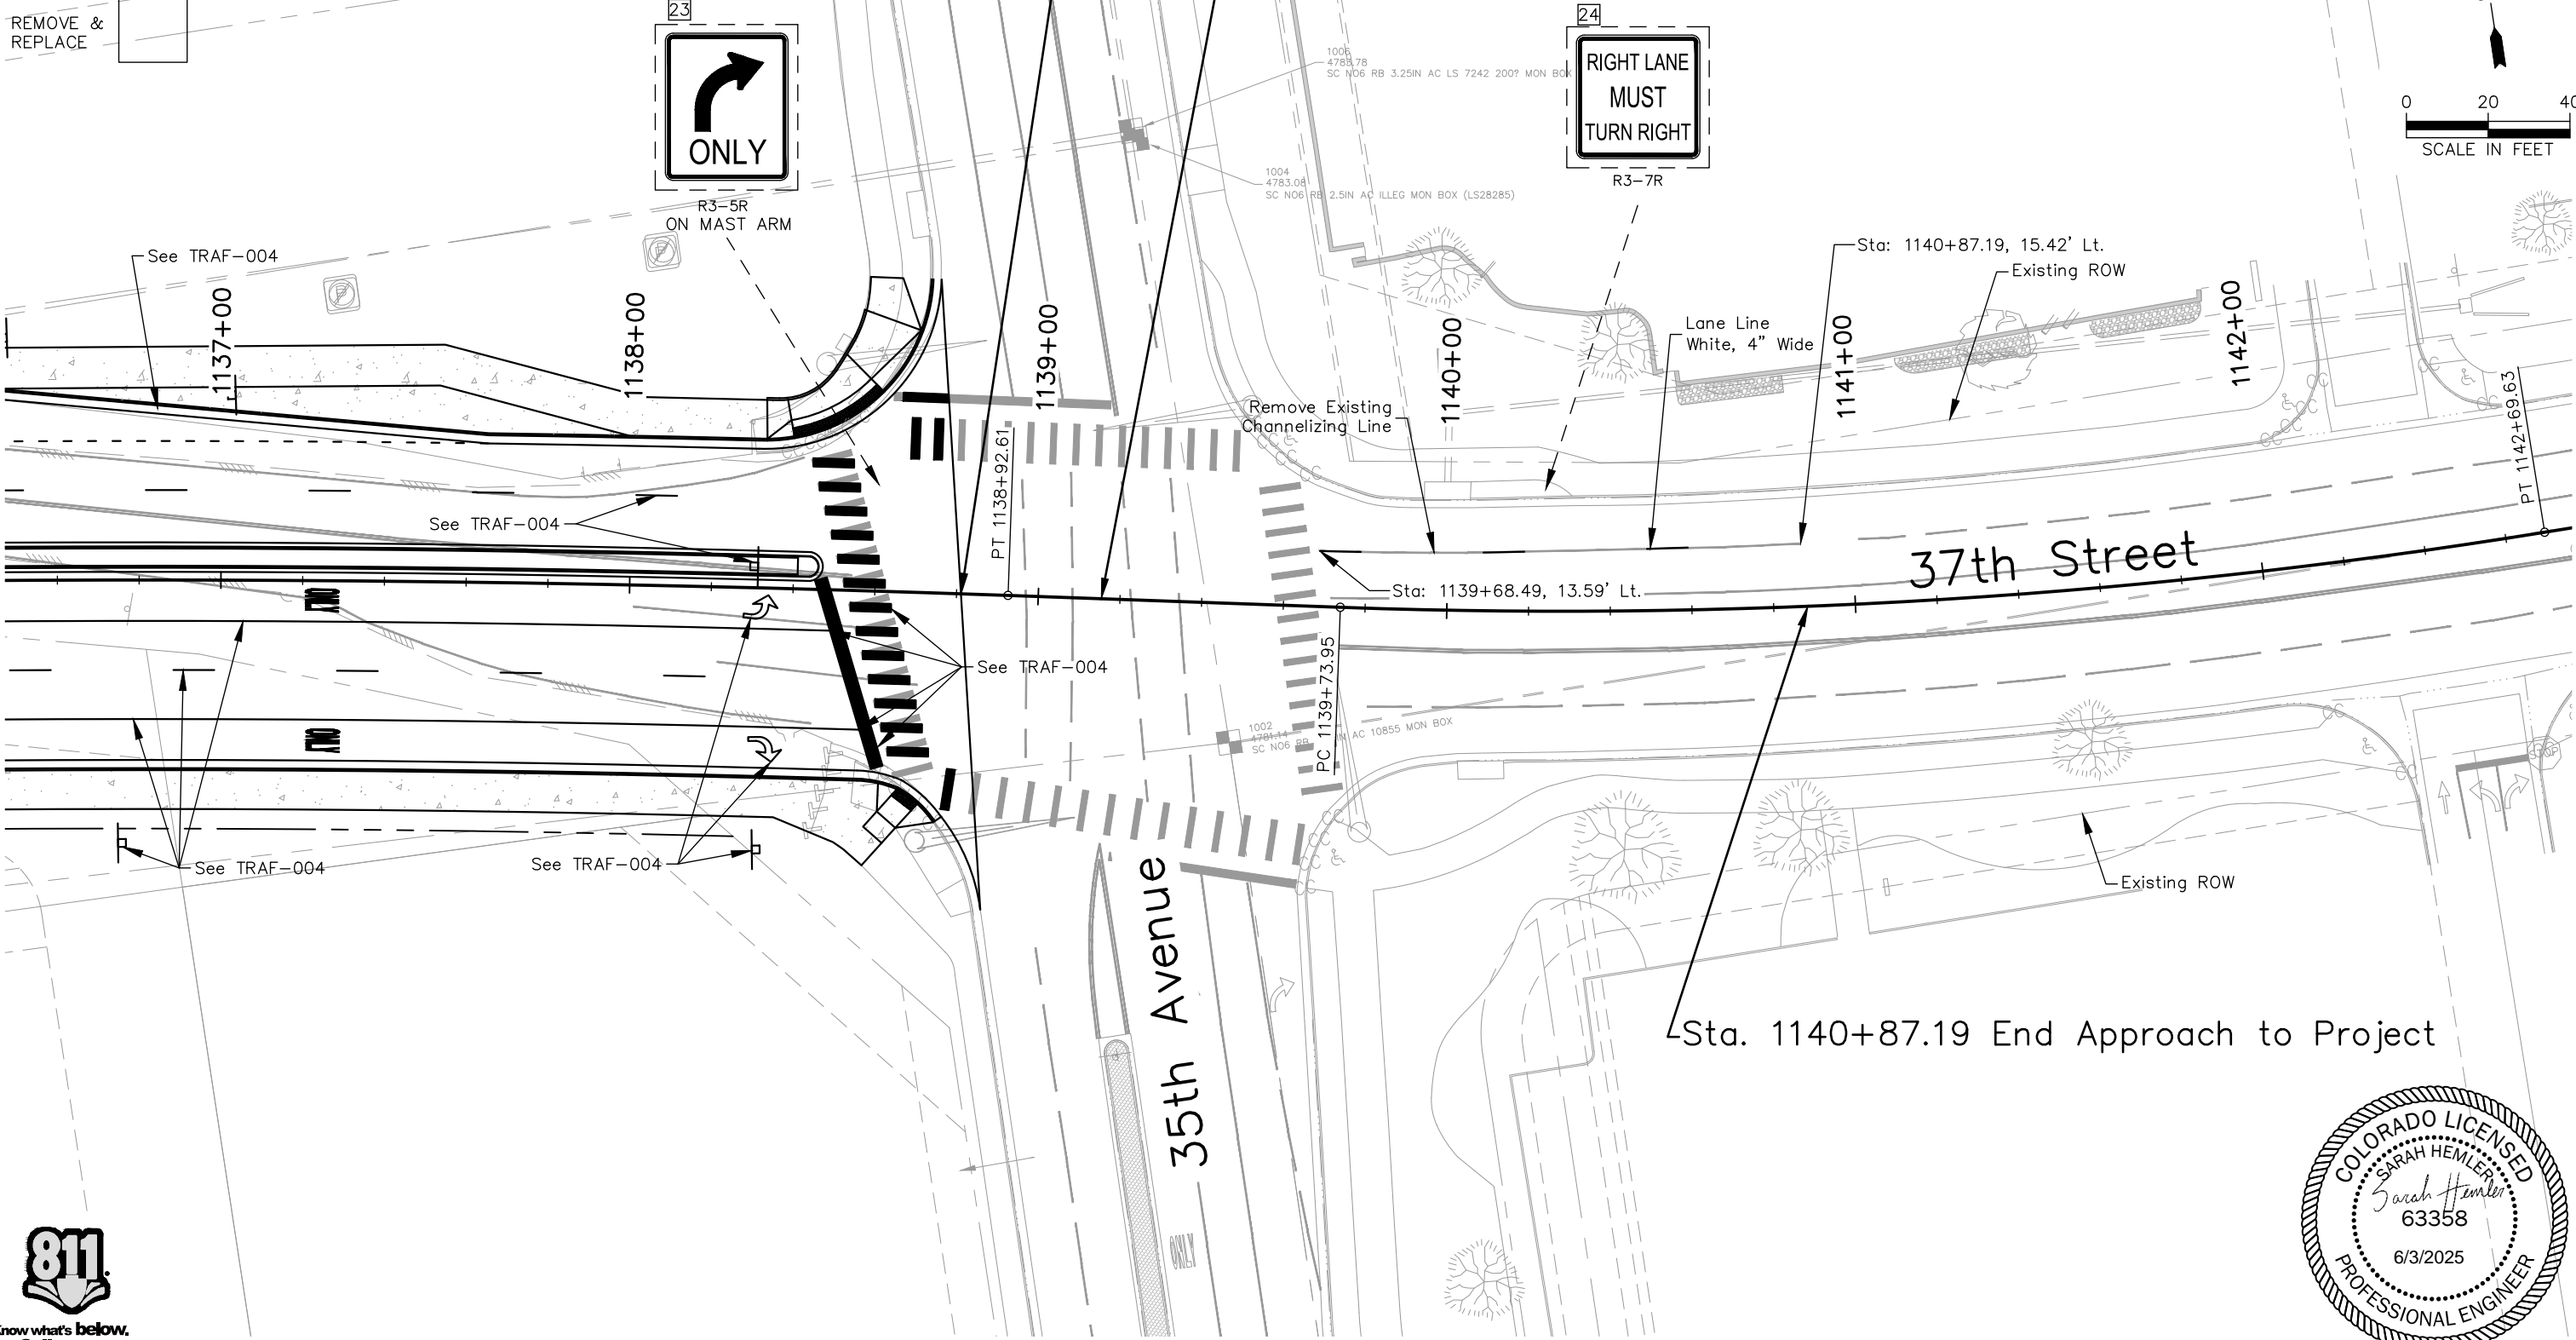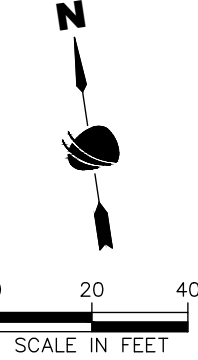

Sta. 1140+87.19 End Approach to Project




Print Date: 5/2/2025
File Name: TRAF P2B-001 TRAFFIC SIGNING AND STRIPING.DWG
Horiz. Scale: As Noted Vert. Scale: N/A

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Sheet Revisions		
Date	Comments	Initials



As Constructed		37TH STREET WIDENING PHASE 2B SIGNING AND STRIPING PLAN		Project No.
No Revisions:				37TH STREET 2B
Revised:		Designer: T. Tuttle	Structure Numbers	Drawing Number TRAF-006
Void:		Detailer: C. Petersen		Sheet Number 127
		Sheet Subset: TRAFFIC	Subset Sheets: 6 of 6	

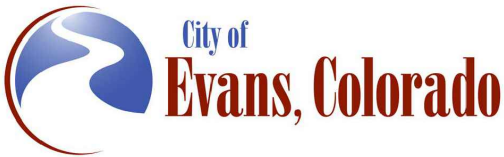FOR CONSTRUCTION 5/1/2025

Plot Date: 5/2/2025 6:54 AM Plotted By: Sarah Hemler
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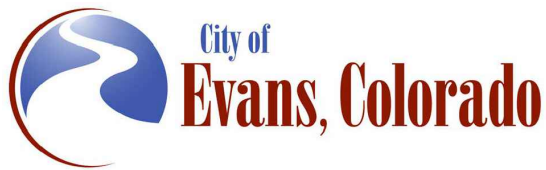


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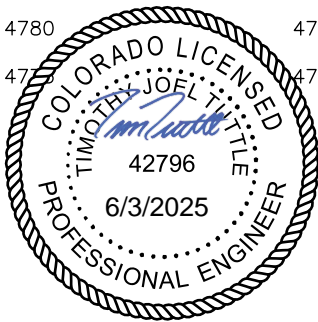
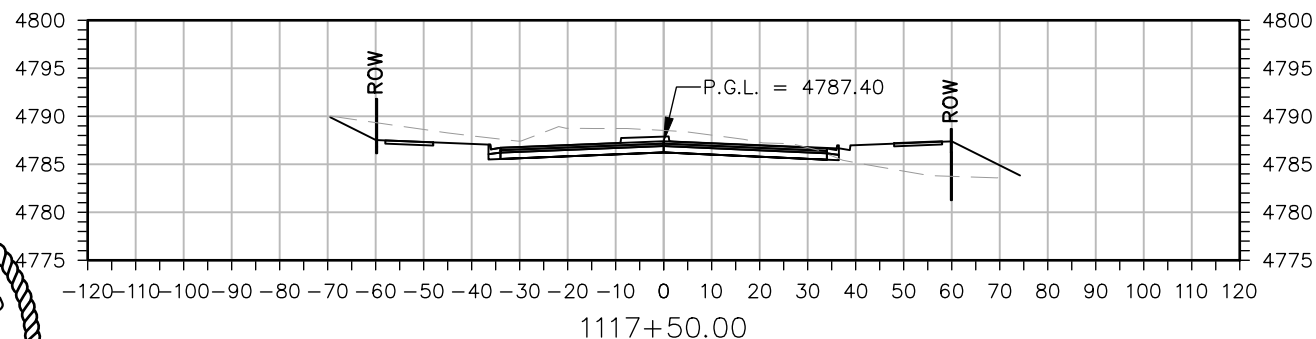
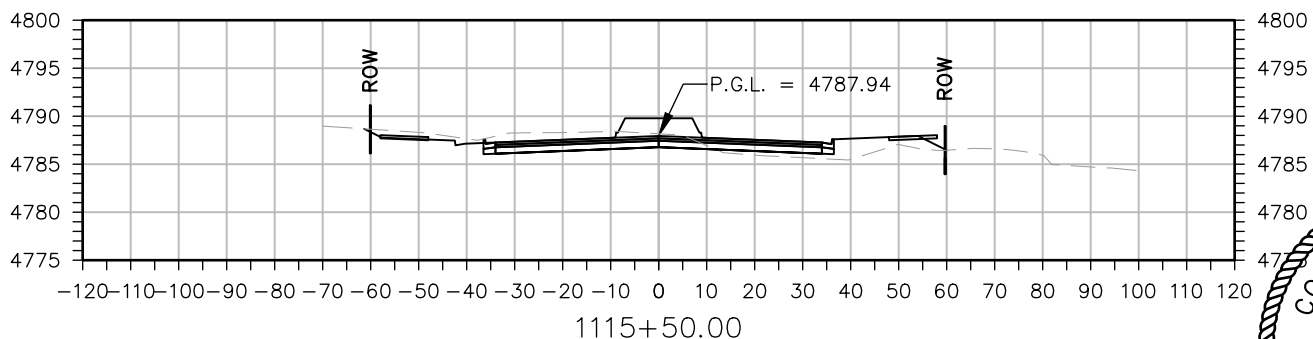
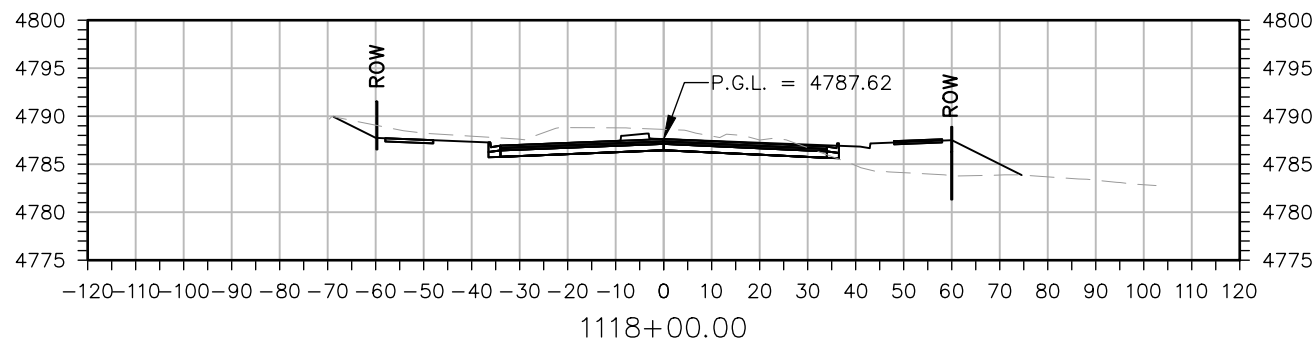
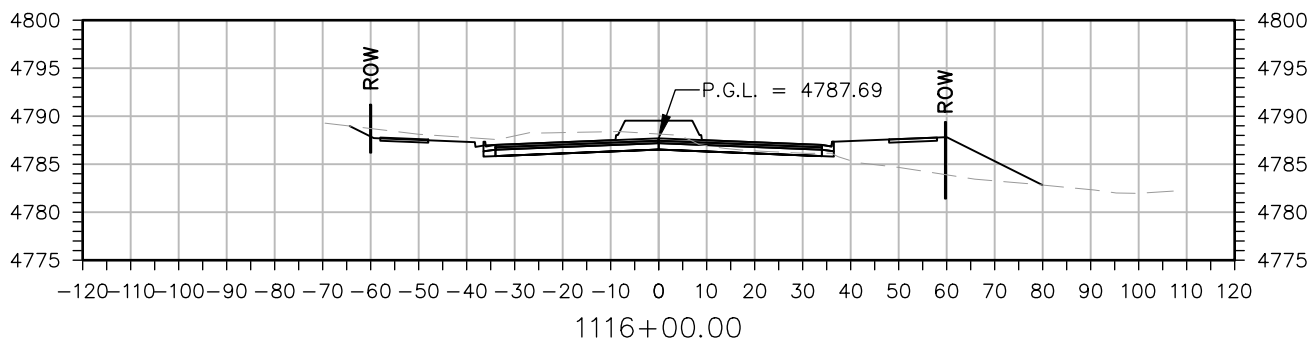
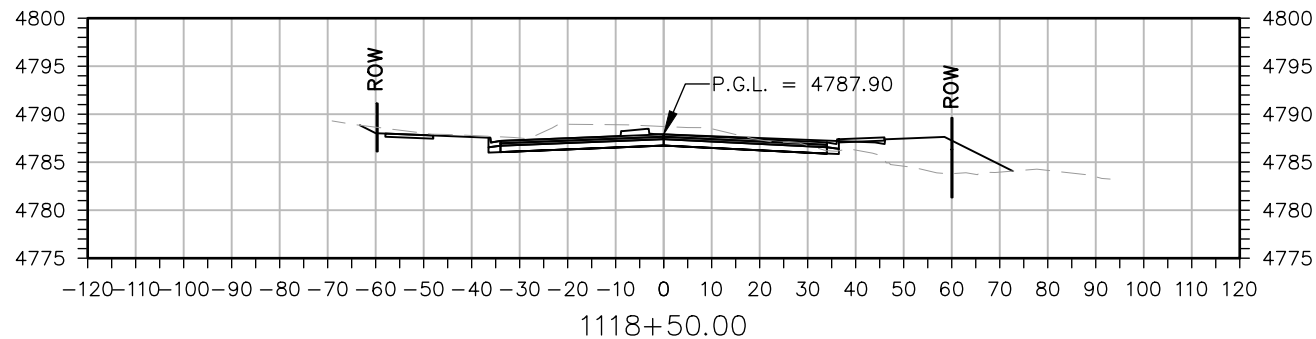
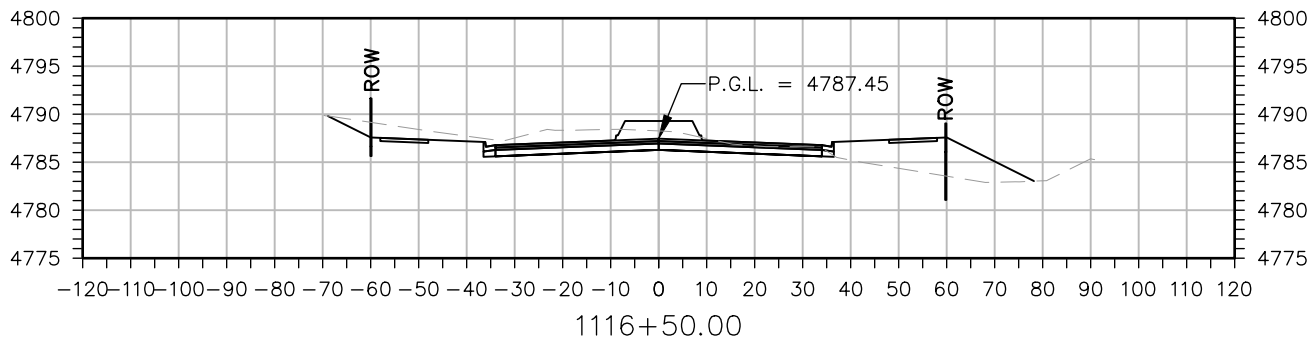
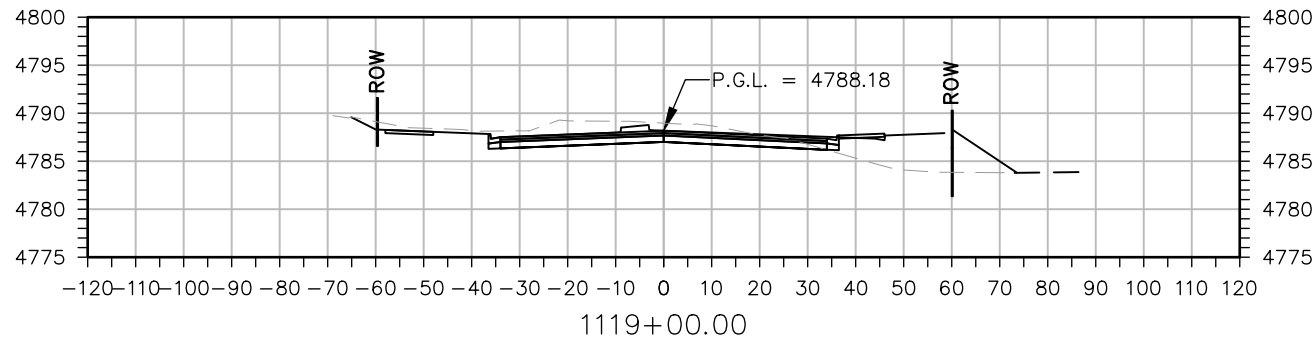
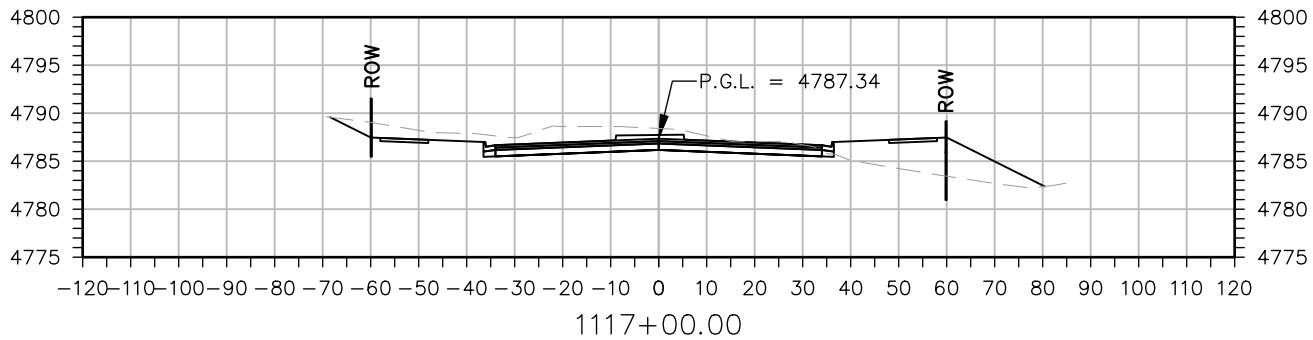
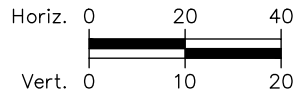
STA. 1114+96.00 BEGIN PROJECT 37TH ST.

Print Date: 5/2/2025	
File Name: XS P2B-001 CROSS SECTIONS.DWG	
Horiz. Scale: As Noted	Vert. Scale: As Noted
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Sheet Revisions		
Date:	Comments	Init.











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	No Revisions:		37TH STREET 2B
Revised:	Designer: T. Tuttle	Structure Numbers	Drawing Number XS-001
Void:	Detailer: S. Hemler		Sheet Number 200
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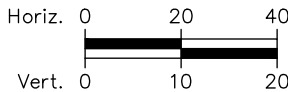
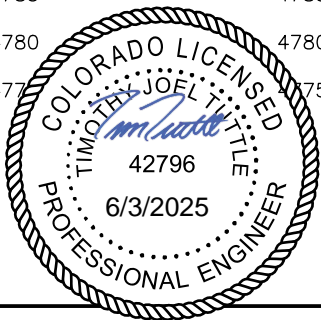


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Plot Date: 5/2/2025 6:54 AM Plotted By: Sarah Hemler
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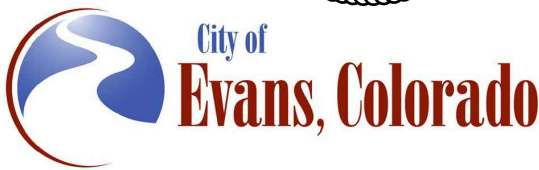


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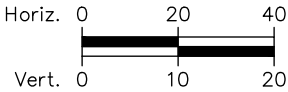
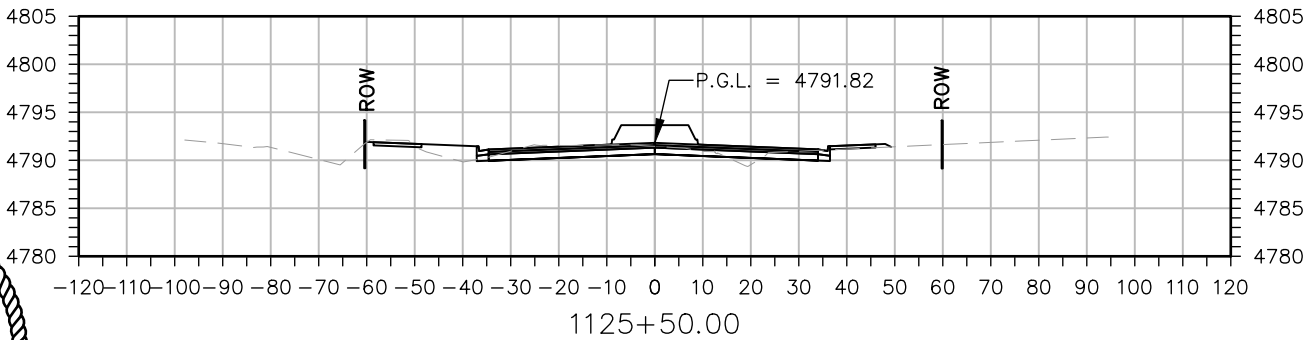
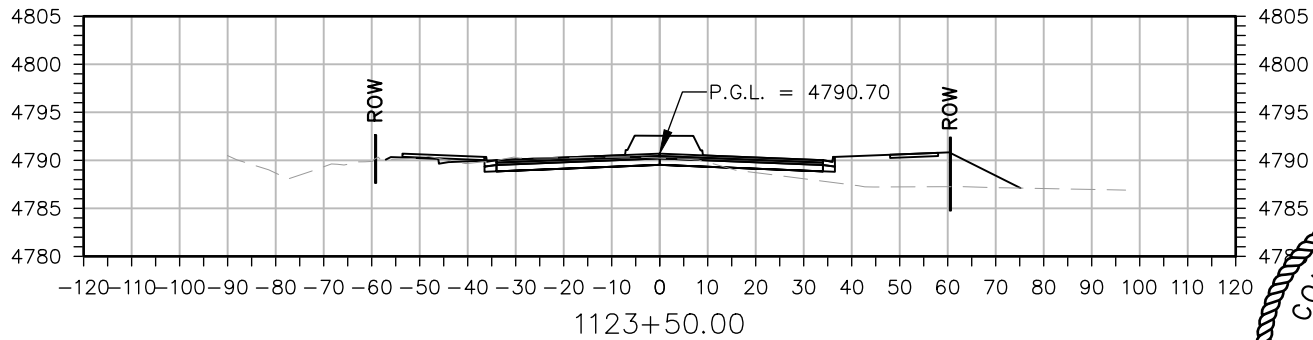
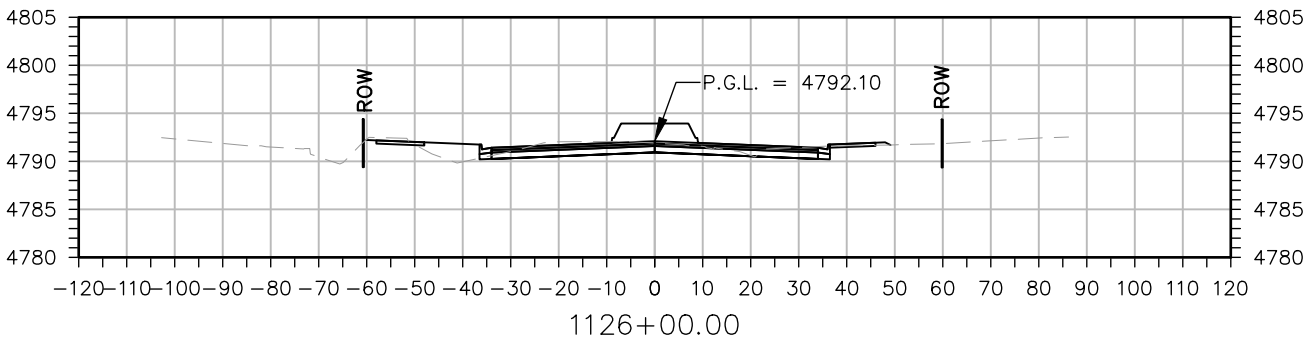
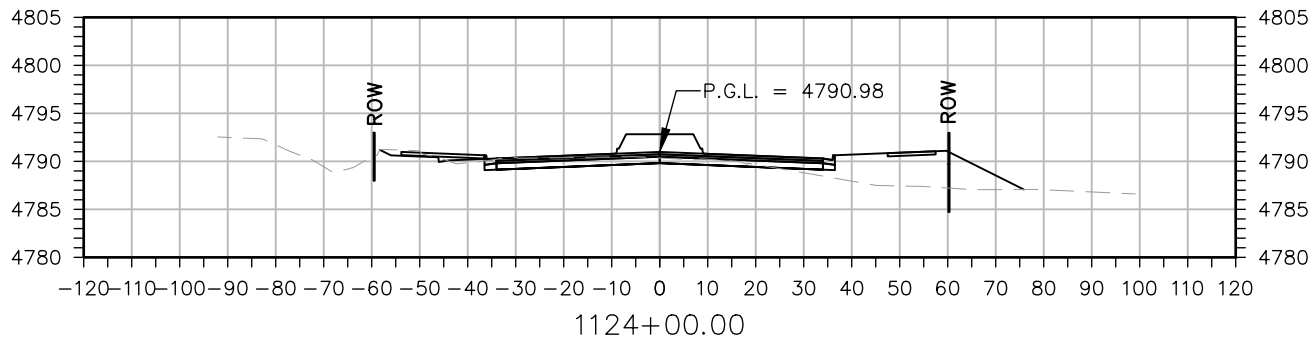
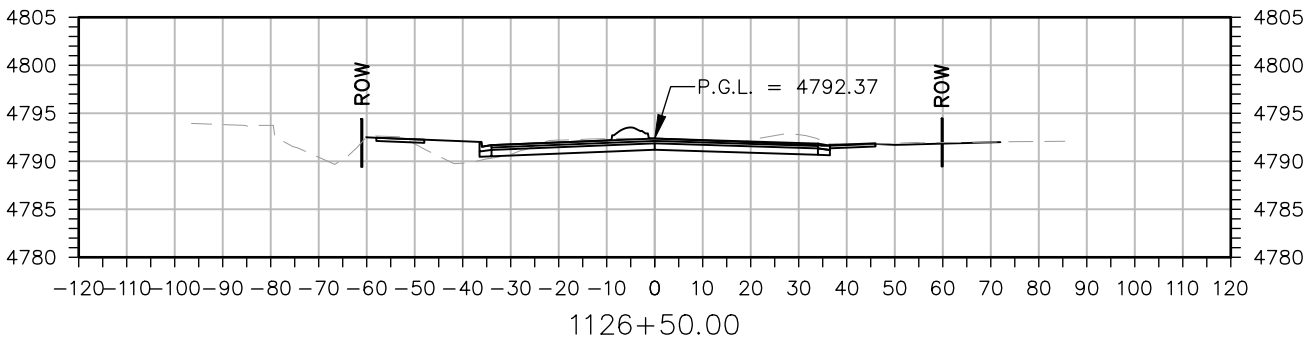
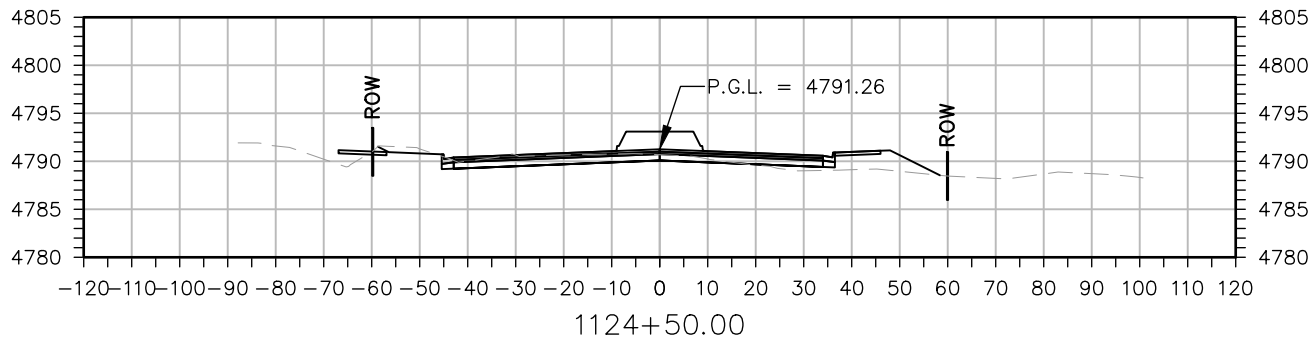
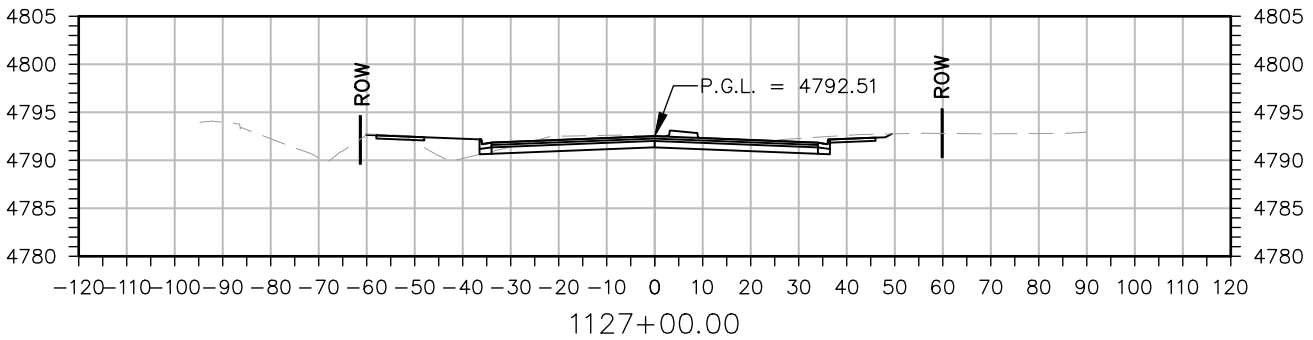
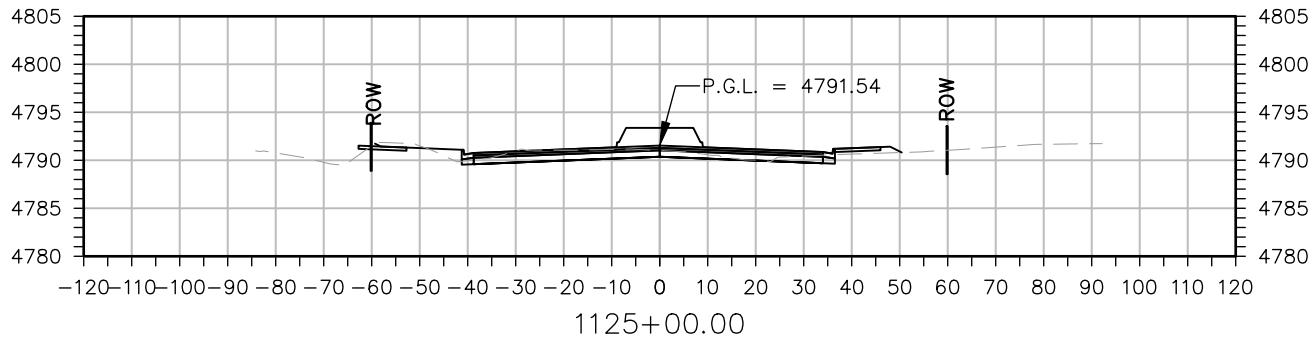
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Horiz. Scale: As Noted	Vert. Scale: As Noted
	12076 Grant Street
	Thornton, CO 80241
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Sheet Revisions		
Date:	Comments	Init.

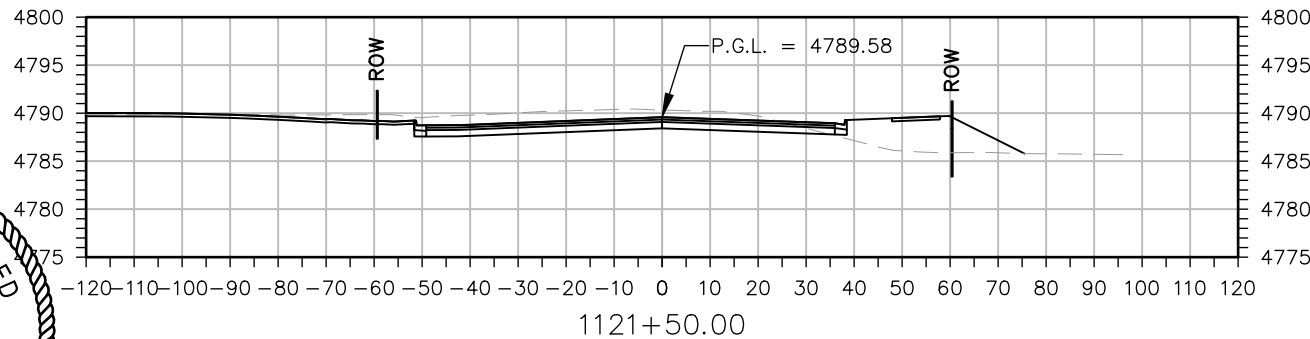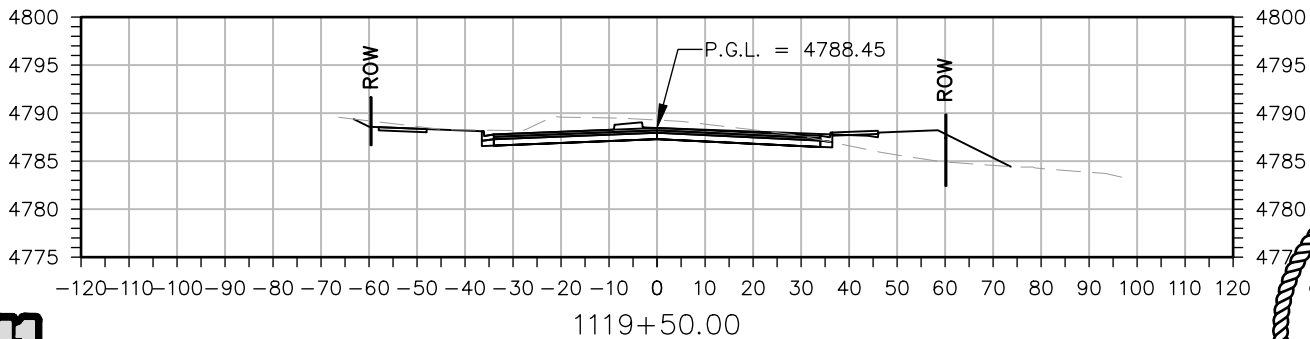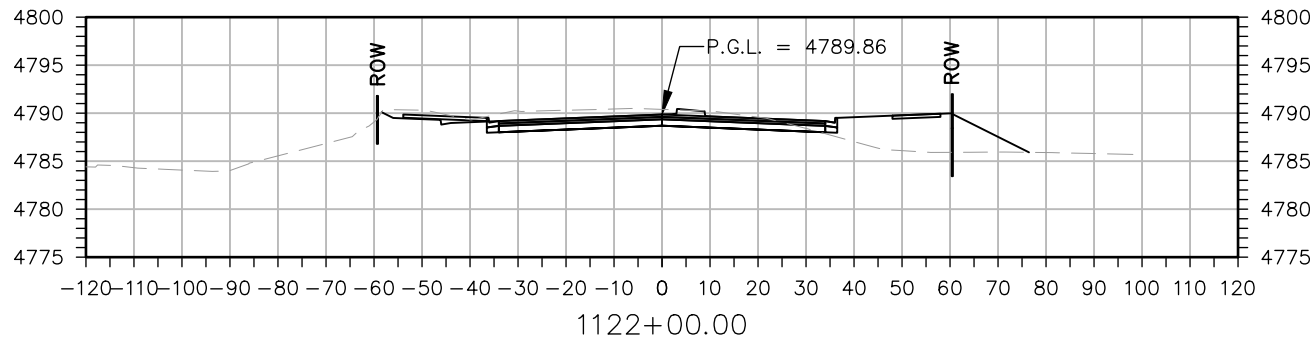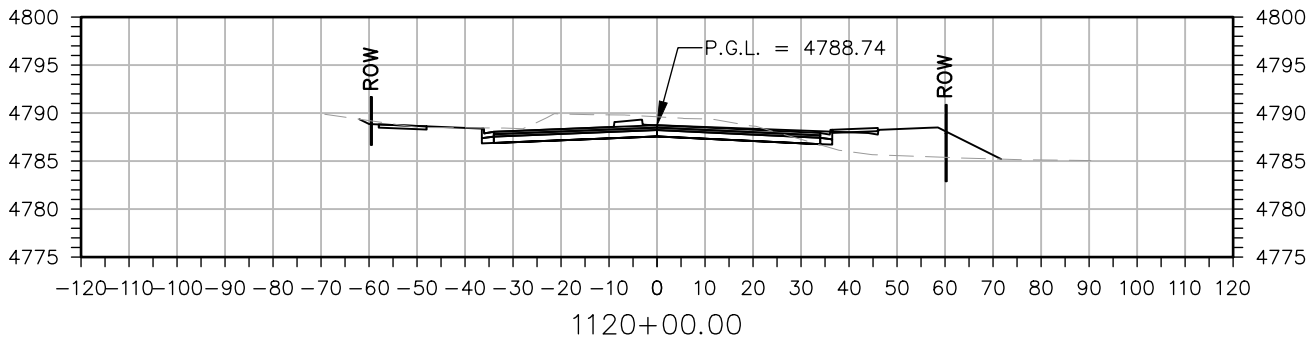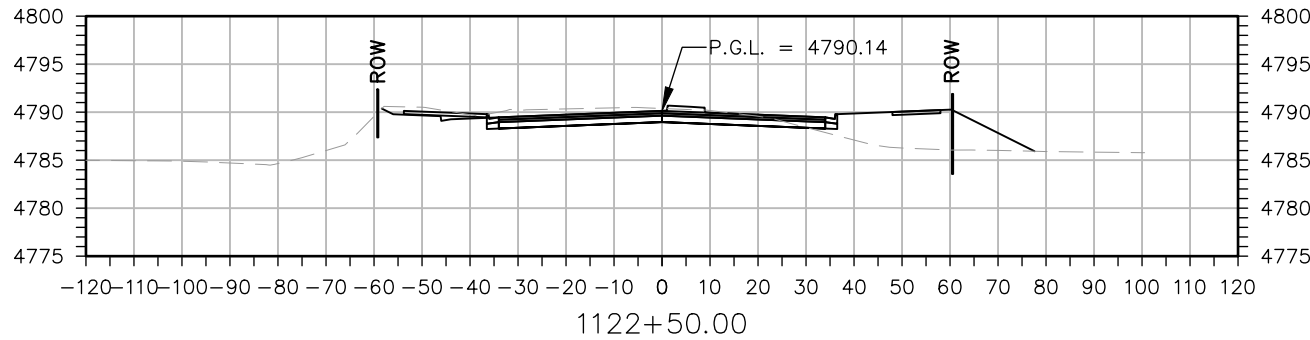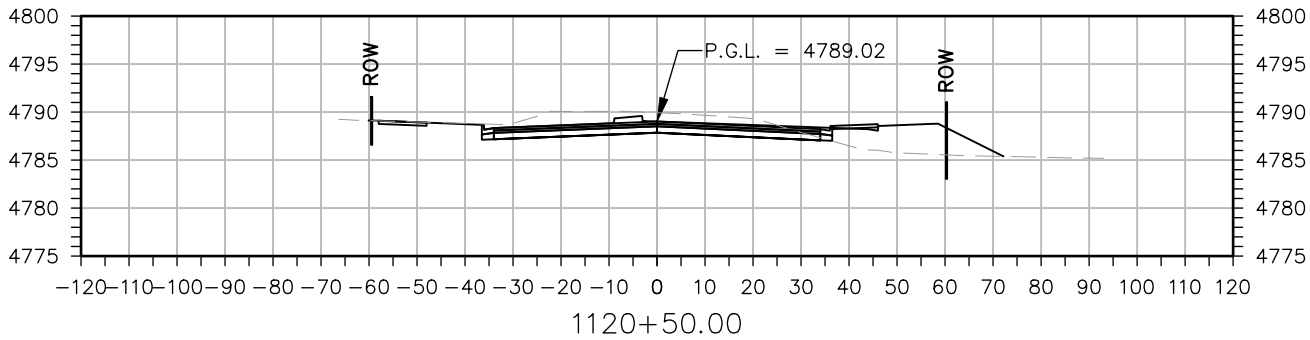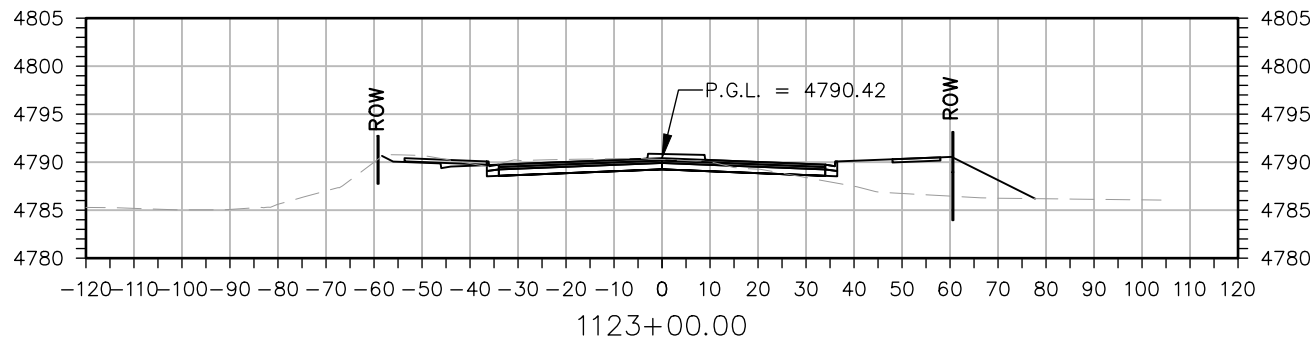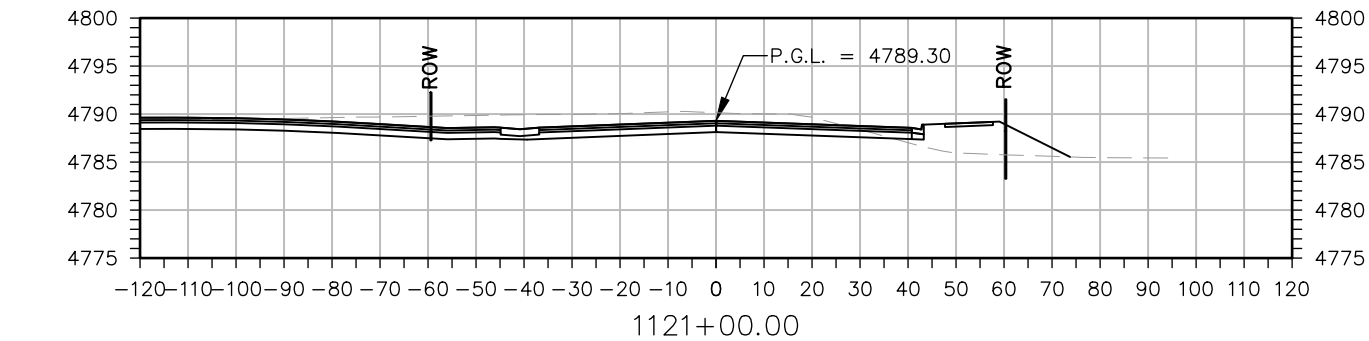


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Revised:	Designer: T. Tuttle	Structure		Drawing Number XS-002
Void:	Detailer: S. Hemler	Numbers		Sheet Number 201
	Sheet Subset: X SECTIONS	Subset Sheets: 2 of 6		

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Print Date: 5/2/2025	
File Name: XS P2B-001 CROSS SECTIONS.DWG	
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	Thornton, CO 80241
	Ph: (303) 962-9300
Fax: (303) 962-9350	










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Date:	Comments	Init.




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Revised:	Designer: T. Tuttle	Structure Numbers		Drawing Number XS-003
Void:	Detailer: S. Hemler			Sheet Number 202
Sheet Subset: X SECTIONS		Subset Sheets: 3 of 6		

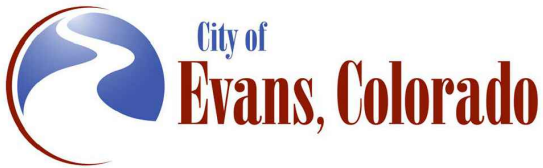Plot Date: 5/2/2025 6:54 AM Plotted By: Sarah Hemler
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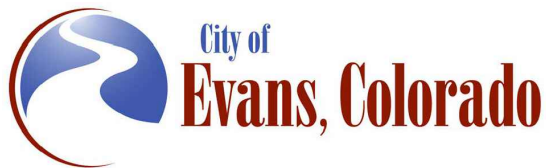


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Print Date: 5/2/2025	
File Name: XS P2B-001 CROSS SECTIONS.DWG	
Horiz. Scale: As Noted	Vert. Scale: As Noted
	12076 Grant Street
	Thornton, CO 80241
	Ph: (303) 962-9300
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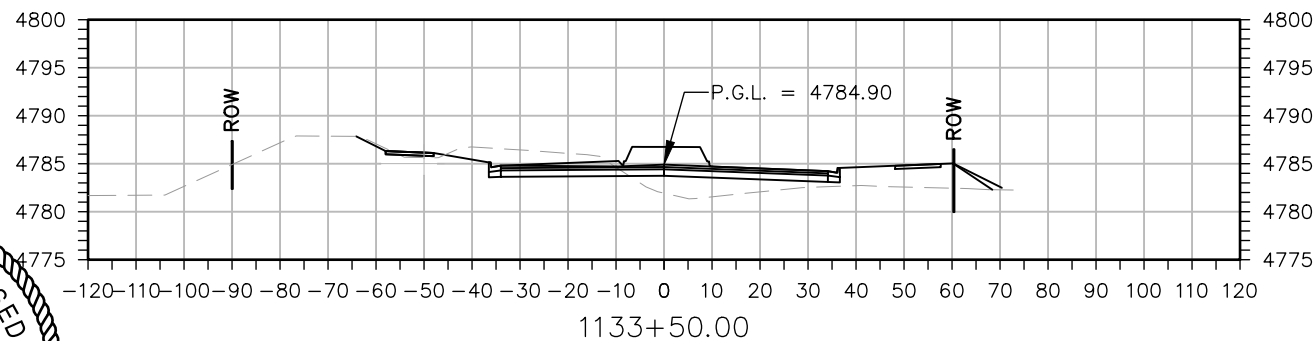
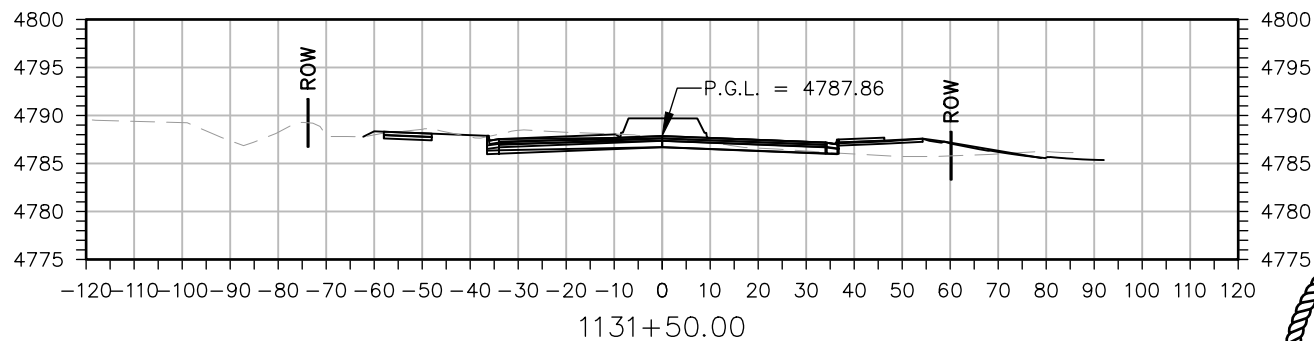
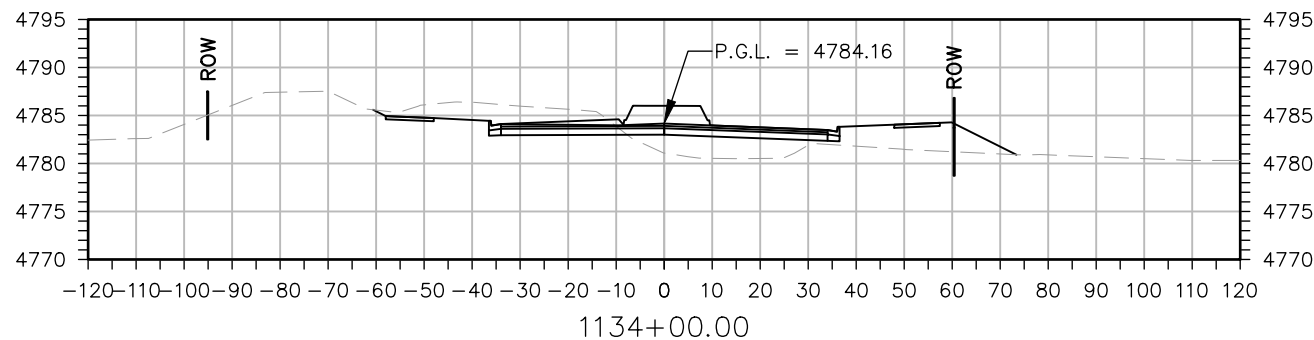
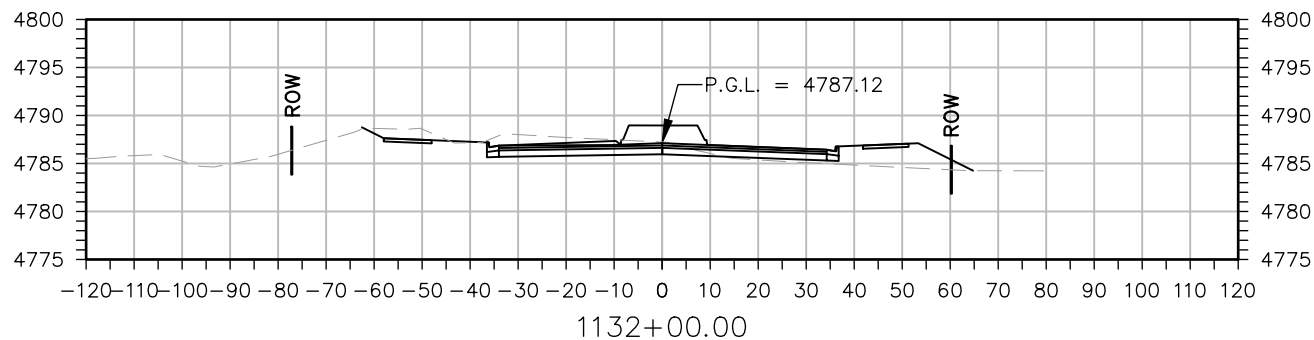
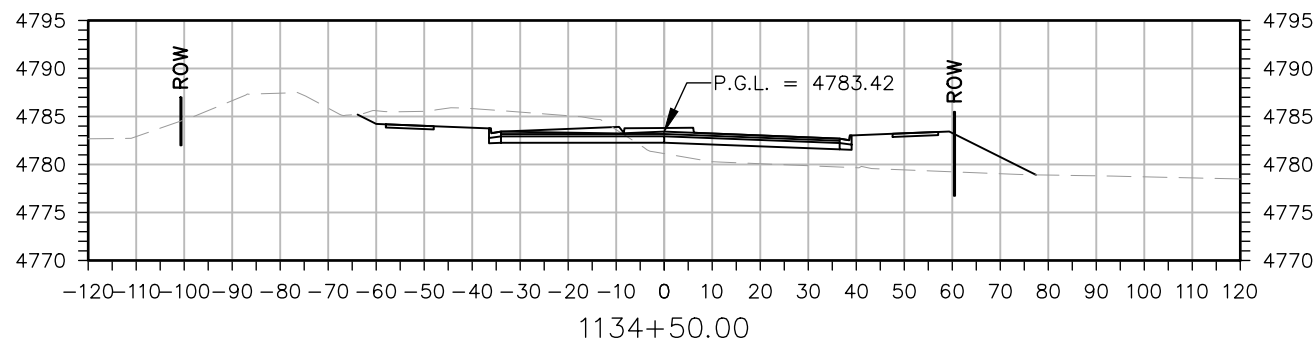
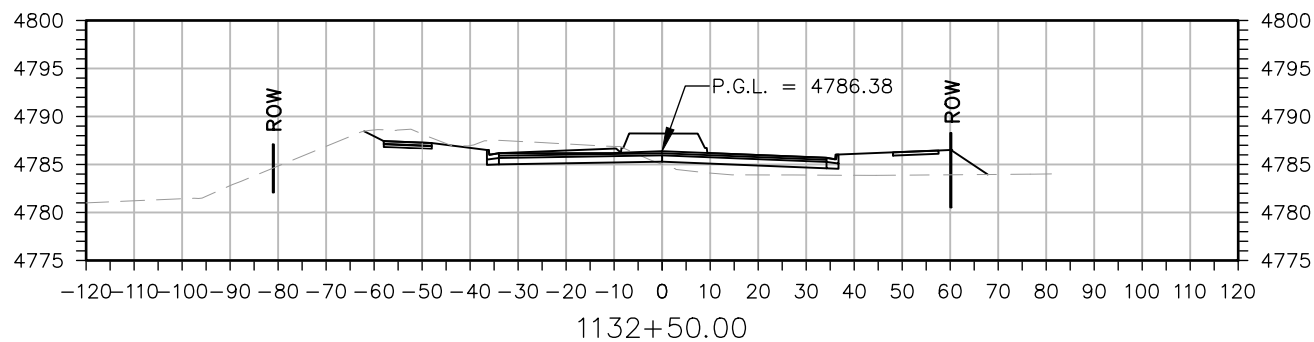
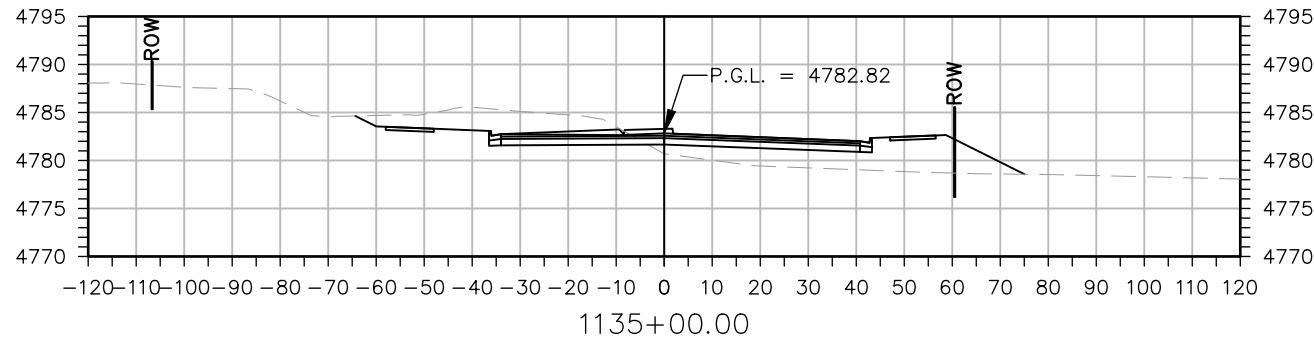
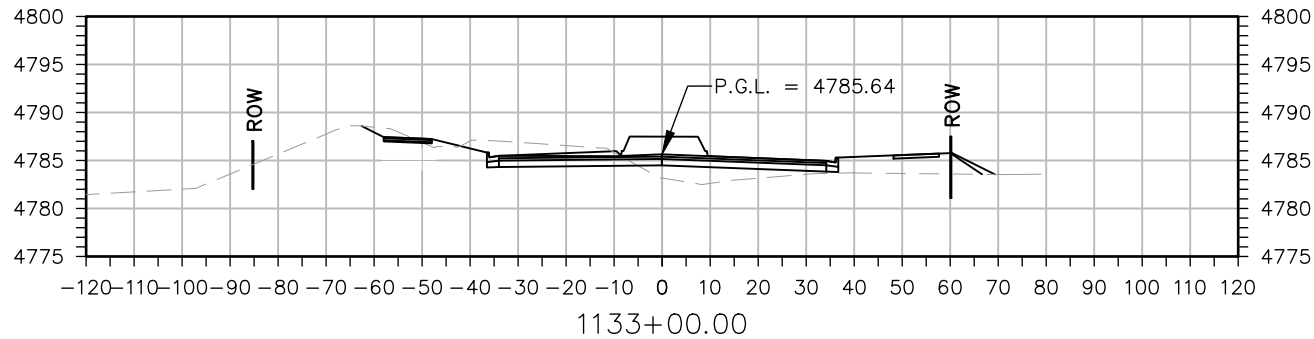
Sheet Revisions		
Date:	Comments	Init.

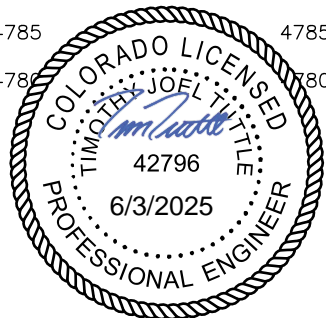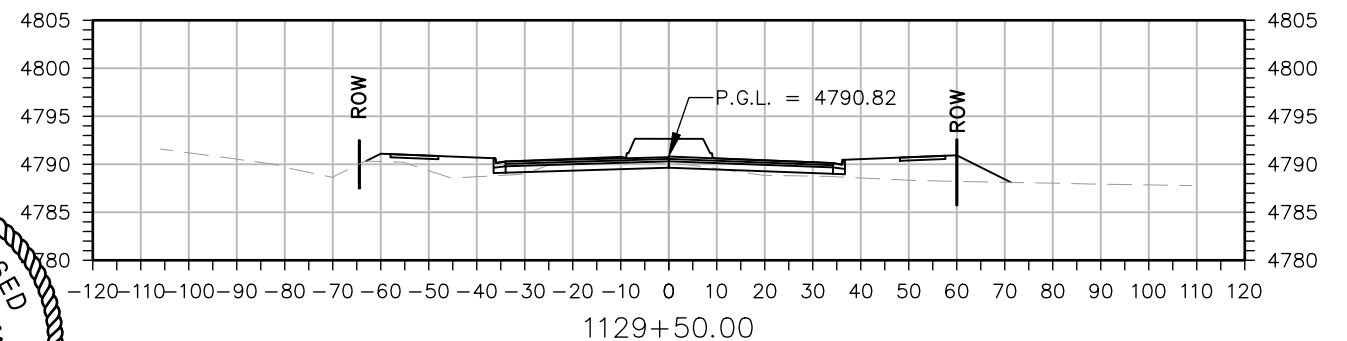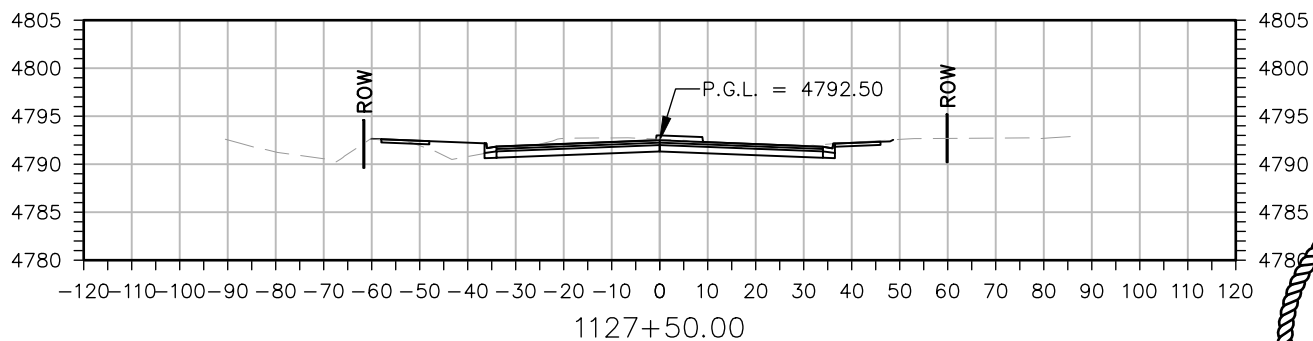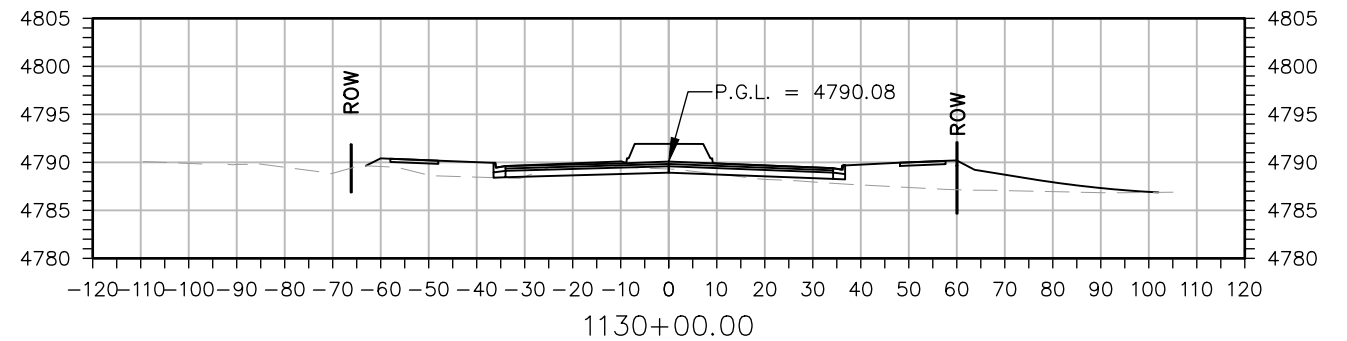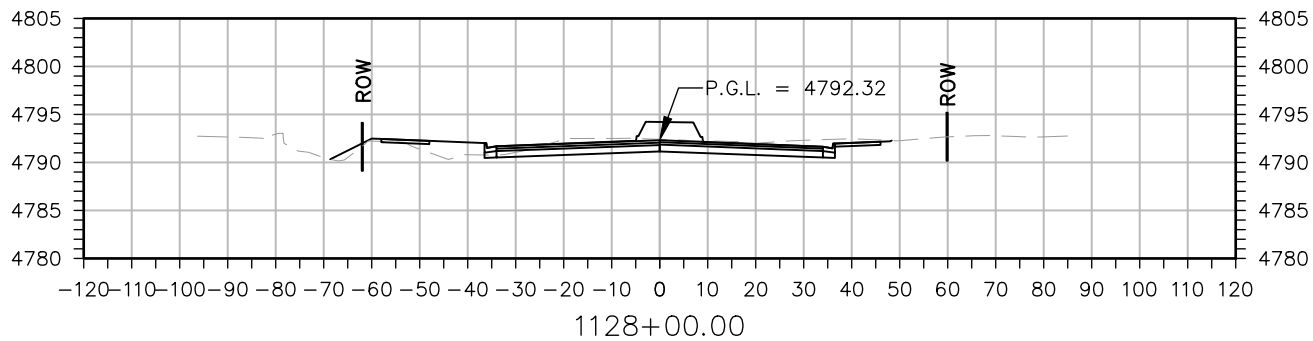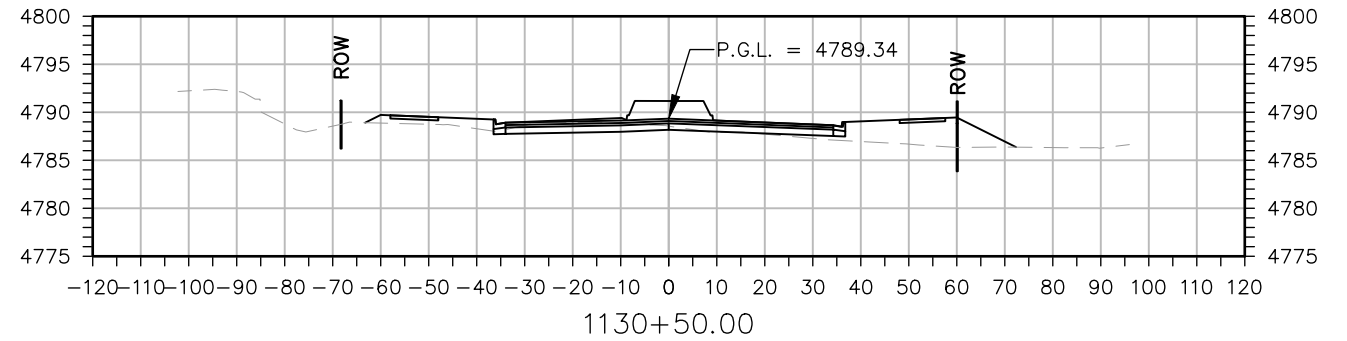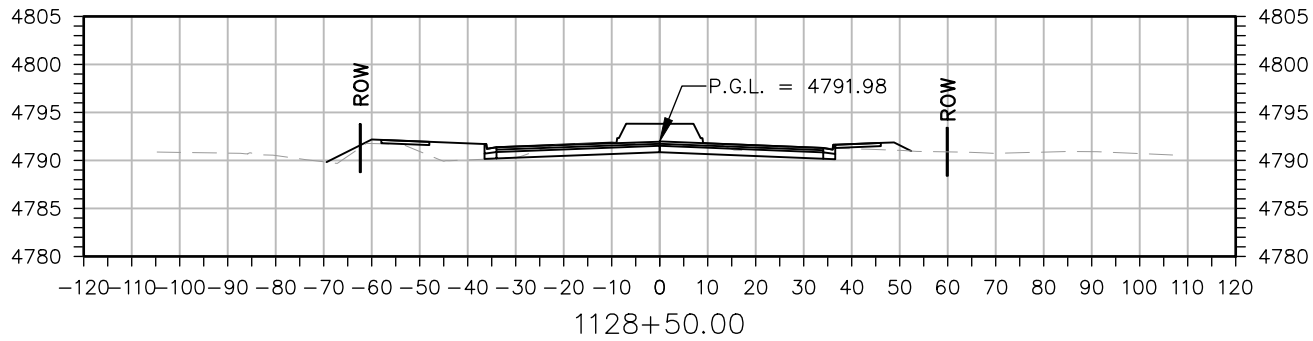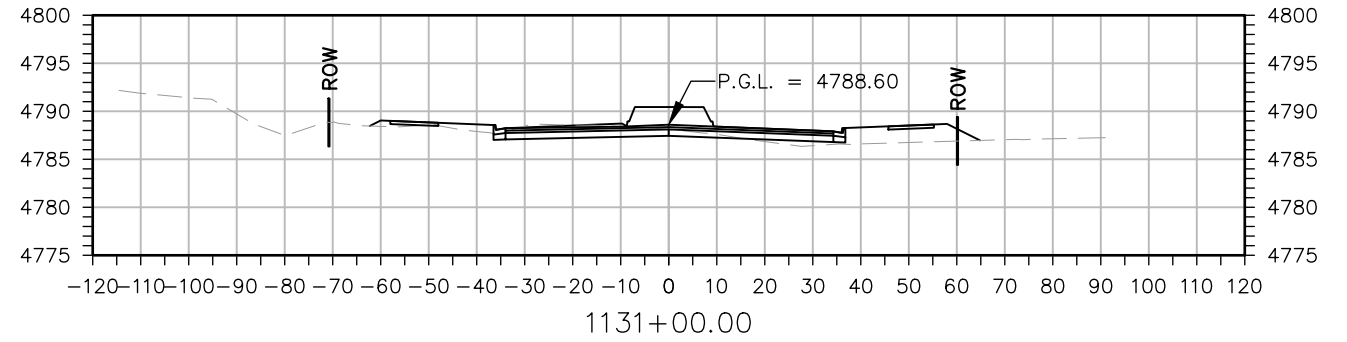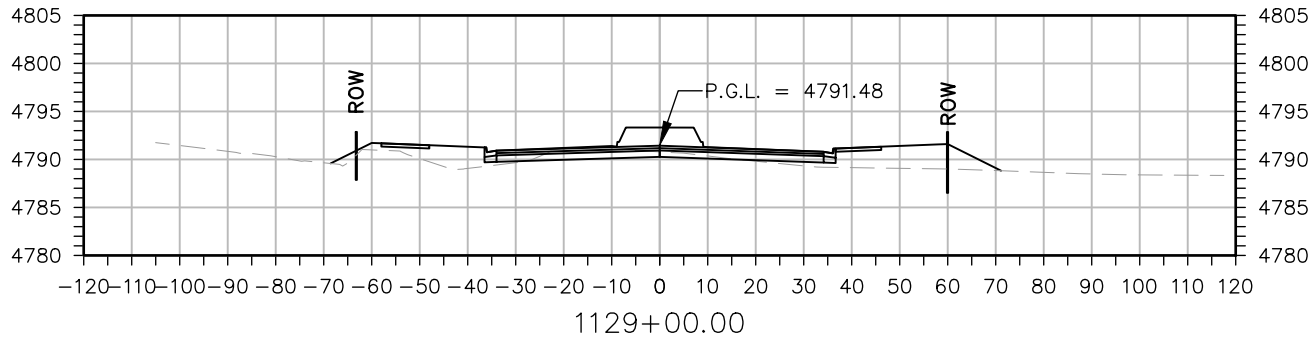



As Constructed		37TH STREET WIDENING PHASE 2B CROSS SECTIONS		Project No.
No Revisions:				37TH STREET 2B
Revised:		Designer: T. Tuttle	Structure Numbers	Drawing Number XS-004
Void:		Detailer: S. Hemler		Sheet Number 203
		Sheet Subset: X SECTIONS	Subset Sheets: 4 of 6	

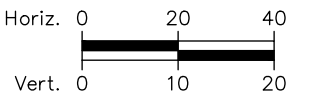Plot Date: 5/2/2025 6:54 AM Plotted By: Sarah Hemler
C:\Q-PROJECTS\37TH STREET WIDENING PHASE 2B\001 CROSS SECTIONS.DWG

FOR CONSTRUCTION 5/1/2025




Know what's below.
Call before you dig.

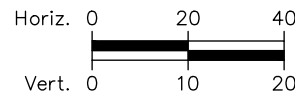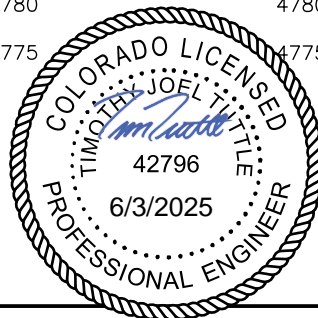

Print Date: 5/2/2025	
File Name: XS P2B-001 CROSS SECTIONS.DWG	
Horiz. Scale: As Noted	Vert. Scale: As Noted
	12076 Grant Street
	Thornton, CO 80241
	Ph: (303) 962-9300
Fax: (303) 962-9350	








Sheet Revisions		
Date:	Comments	Init.

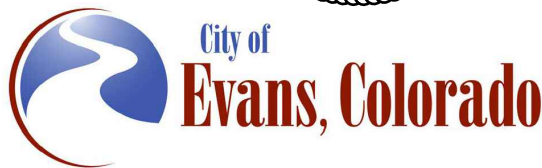

As Constructed	37TH STREET WIDENING PHASE 2B CROSS SECTIONS			Project No.
	No Revisions:			37TH STREET 2B
Revised:	Designer: T. Tuttle	Structure		Drawing Number XS-005
Void:	Detailer: S. Hemler	Numbers		Sheet Number 204
Sheet Subset: X SECTIONS		Subset Sheets: 5 of 6		

Plot Date: 5/2/2025 6:54 AM Plotted By: Sarah Hemler
C:\G-PROJECTS\37TH STREET WIDENING PHASE 2B\37TH ST AND 47TH AVE PLAN\2025\COMPUTER DESIGN FILES\2B - PHASE 2B\2025\2B-001 CROSS SECTIONS.DWG

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STA. 1138+80.93 END PROJECT 37TH ST.

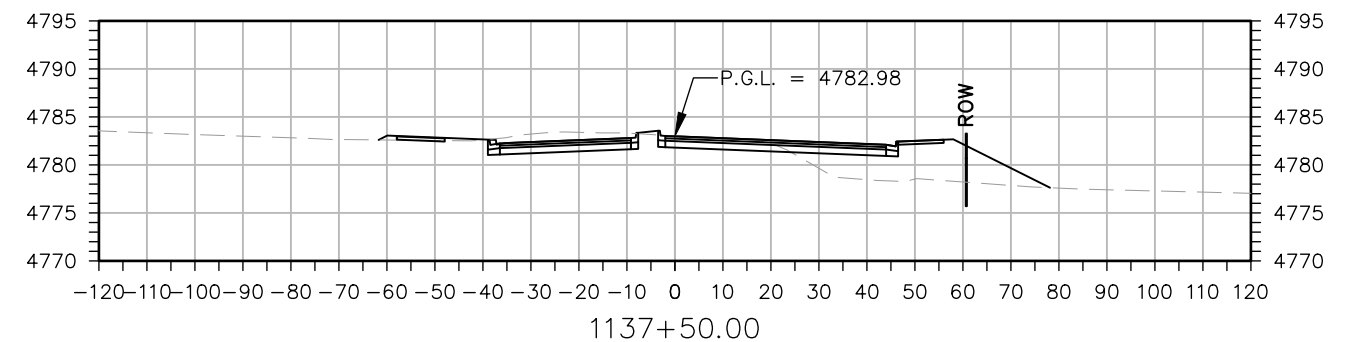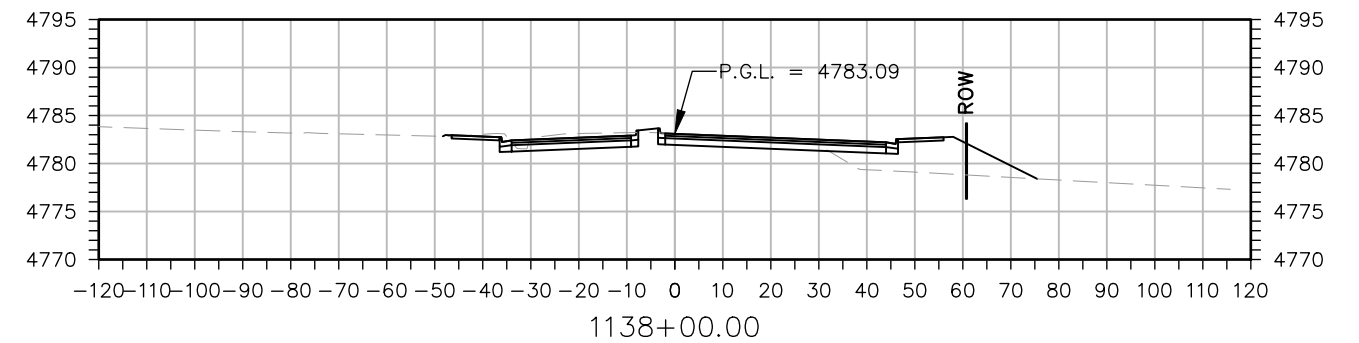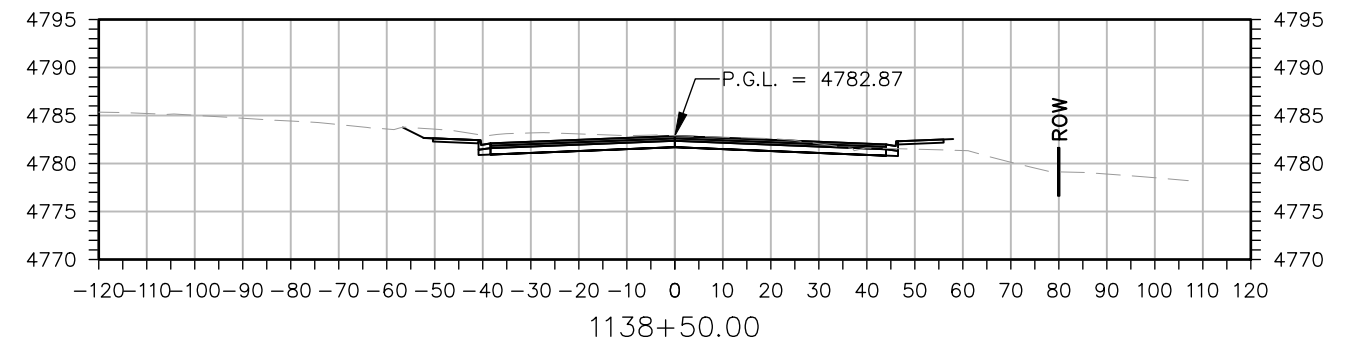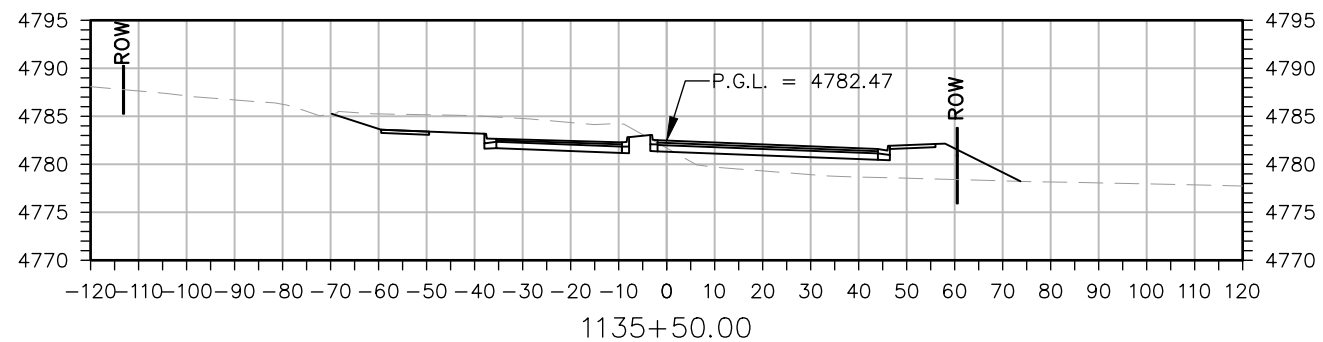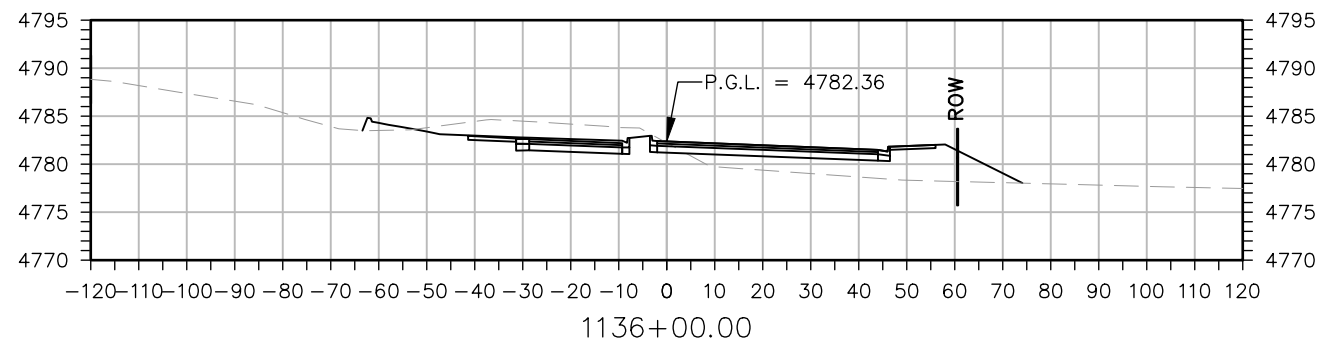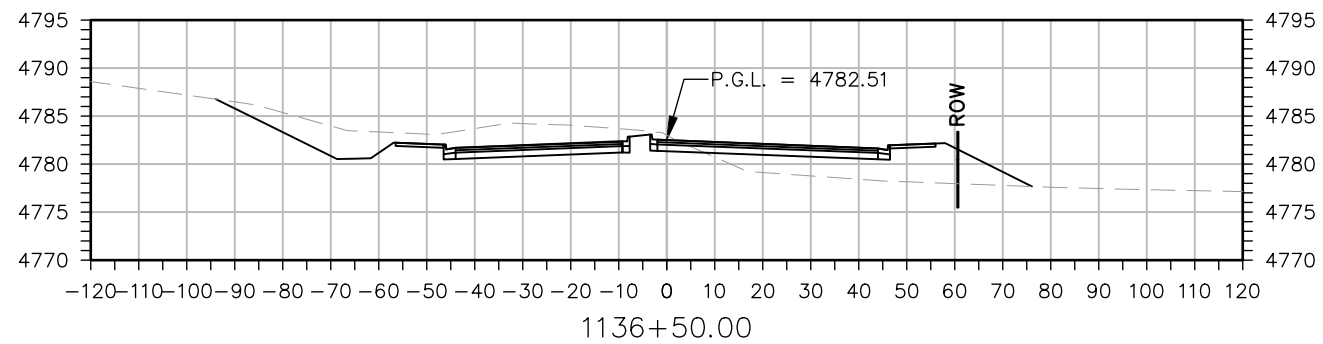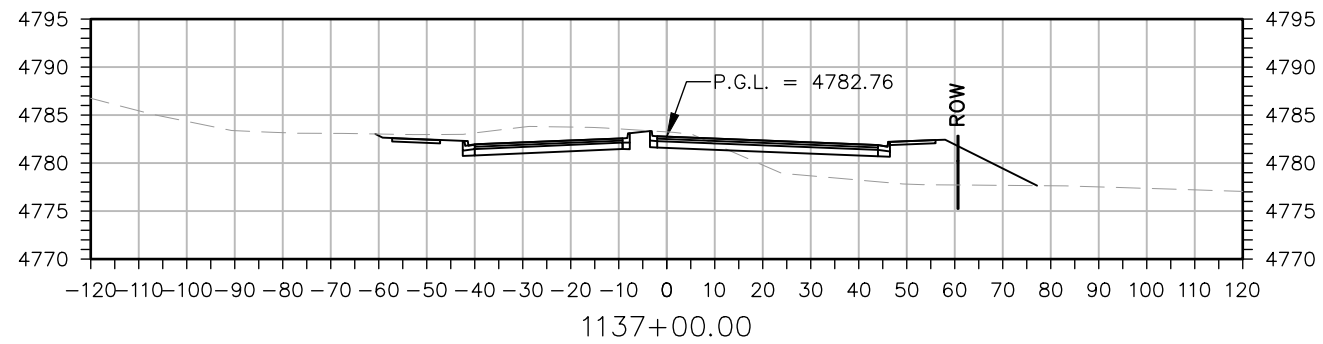

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Print Date: 5/2/2025

File Name: XS P2B-001 CROSS SECTIONS.DWG

Horiz. Scale: As Noted


Vert. Scale: As Noted



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As Constructed

No Revisions:

Revised:

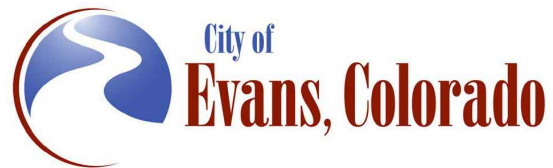Void:

37TH STREET WIDENING PHASE 2B CROSS SECTIONS

Designer:	T. Tuttle
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Detailer: S. Hemler

Sheet Subset: X SECTIONS

e	Structure
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r	Numbers
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S Subset Sheets: 6 of 6

Project No.

37TH STREET 2B

Drawing Number XS-006

Sheet Number 205

FOR CONSTRUCTION 5/1/2025